Town of North Hempstead

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Board of Zoning Appeals

210 Plandome Road Manhasset, NY 11030 (516) 869-7667 Fax (516) 869-7812

CALENDAR FOR SEPTEMBER 4, 2024

RESIDENTIAL CALENDAR

APPEAL #21589 – Evangelia Karanikas; 141 Country Club Dr., Manhasset; Section 3, Block 148, Lot 73; Zoned: Residence-A

Variances from §§ 70-30.B and 70-100.2.A(2) to construct a one-story portico too close to the street (primary front yard), to construct a raised deck too close to the street (secondary front yard), and to install fences in the front yard (secondary front yard)

APPEAL #21580 – Lisa David; 50 Bregman Ave., New Hyde Park; Section 8, Block 212, Lot 110; Zoned: Residence-C

Variances from §§ 70-49(C), 70-51(A) and 70-52.3 to construct a new house that would be too big, with side yards which are too small, with not enough total side yards (aggregate side yards) and that would encroach into the sky exposure plane.

APPEAL #21586 – Onkar Singh; 47 Reed Dr., Roslyn; Section 9, Block 653, Lot 64; Zoned: Residence-A

Variances from §§ 70-29(C) & 70-30(C) to legalize a new home which is too big and is located too close to the street.

APPEAL #21582 - Xin Wei Xu; 3 Twelfth Street, Carle Place, Section 10, Block 269, Lot 30; Zoned: Residence-B

Variances from §§70-40.B, 70-41.B, 70-42, 70-42.6, 70-102.C(5)(a), 70-100.1(A), 70-100.2(A), and 70-100.2(D) to construct a one story addition that is too close to the street, a deck and louvered awning that are too close to the side property line, a second story addition that is too close to the rear property line, paving covering too much of the secondary front yard, an inground pool that is too close to the side property line, pool equipment that is too close to the rear property line, an inground pool, awning, barbecue and a pool barrier in the side yard (not permitted), fencing that is too tall and being used as a pool barrier fence, and a barbecue that is too close to the side property line.

APPEAL #21590 - Tomas Garcia; 701 Roman Avenue, Westbury; Section 11, Block 91, Lot 20; Zoned: Residence-A

Variance from §70-100.2(A)(2) to install fencing that is located within a front yard.


APPEAL #21591 – Zheng Ying Cai & Shu Zhen Wu; 6 Hollow Ct., Westbury; Section 11, Block 415, Lot 16; Zoned: Residence-C


Variances from §§ 70-100.2.A(2), 70-100.2.A(4) & 70-100.2.A(4)(b) to legalize fencing which is too tall and which is located within the front yard.

COMMERCIAL CALENDAR

APPEAL #21088 - PK 800 Northern, LLC (DermWalk) 800 Northern Boulevard, Suite 6, Great Neck; Section 2, Block 116, Lot 1; Zoned: Business-A

Variances from §§70-103.A(1), 70-103.B, 70-229.A, and 70-203.H to construct interior alterations to convert a commercial space to a doctor's office with not enough parking on site, parking stalls that are too small, removal of a required landscape buffer, and non-compliance with previous BZA decision #11198.

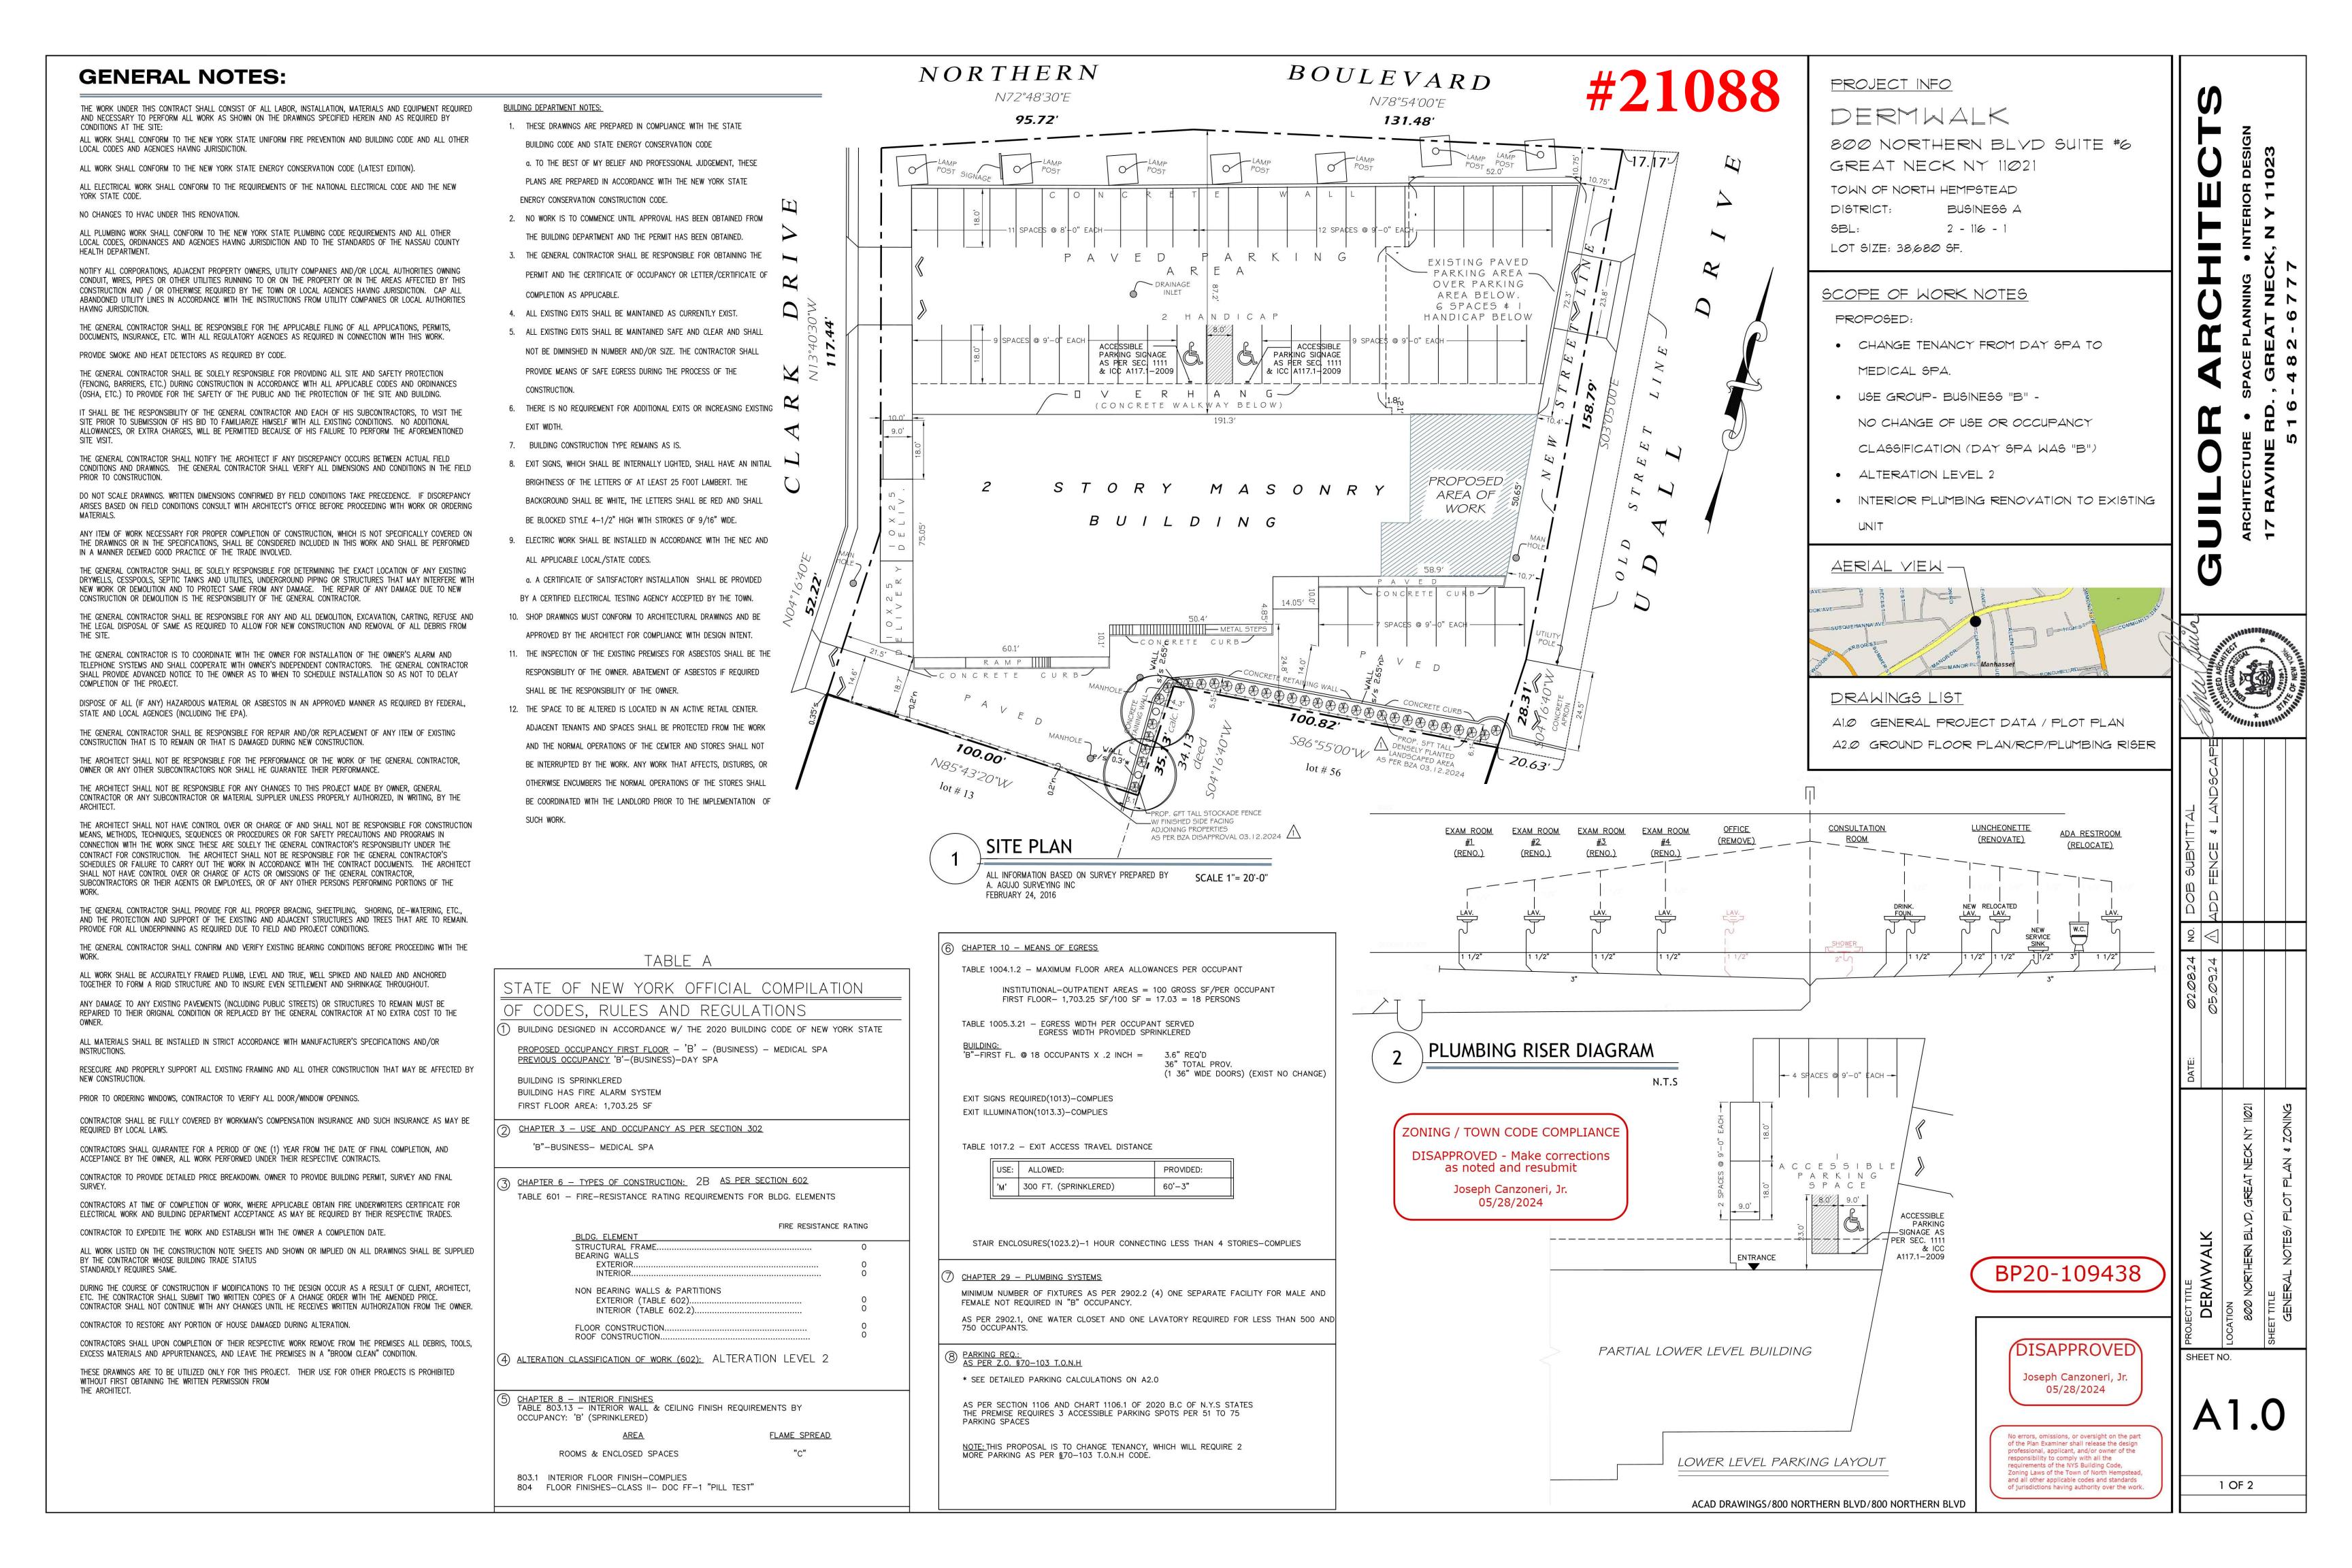

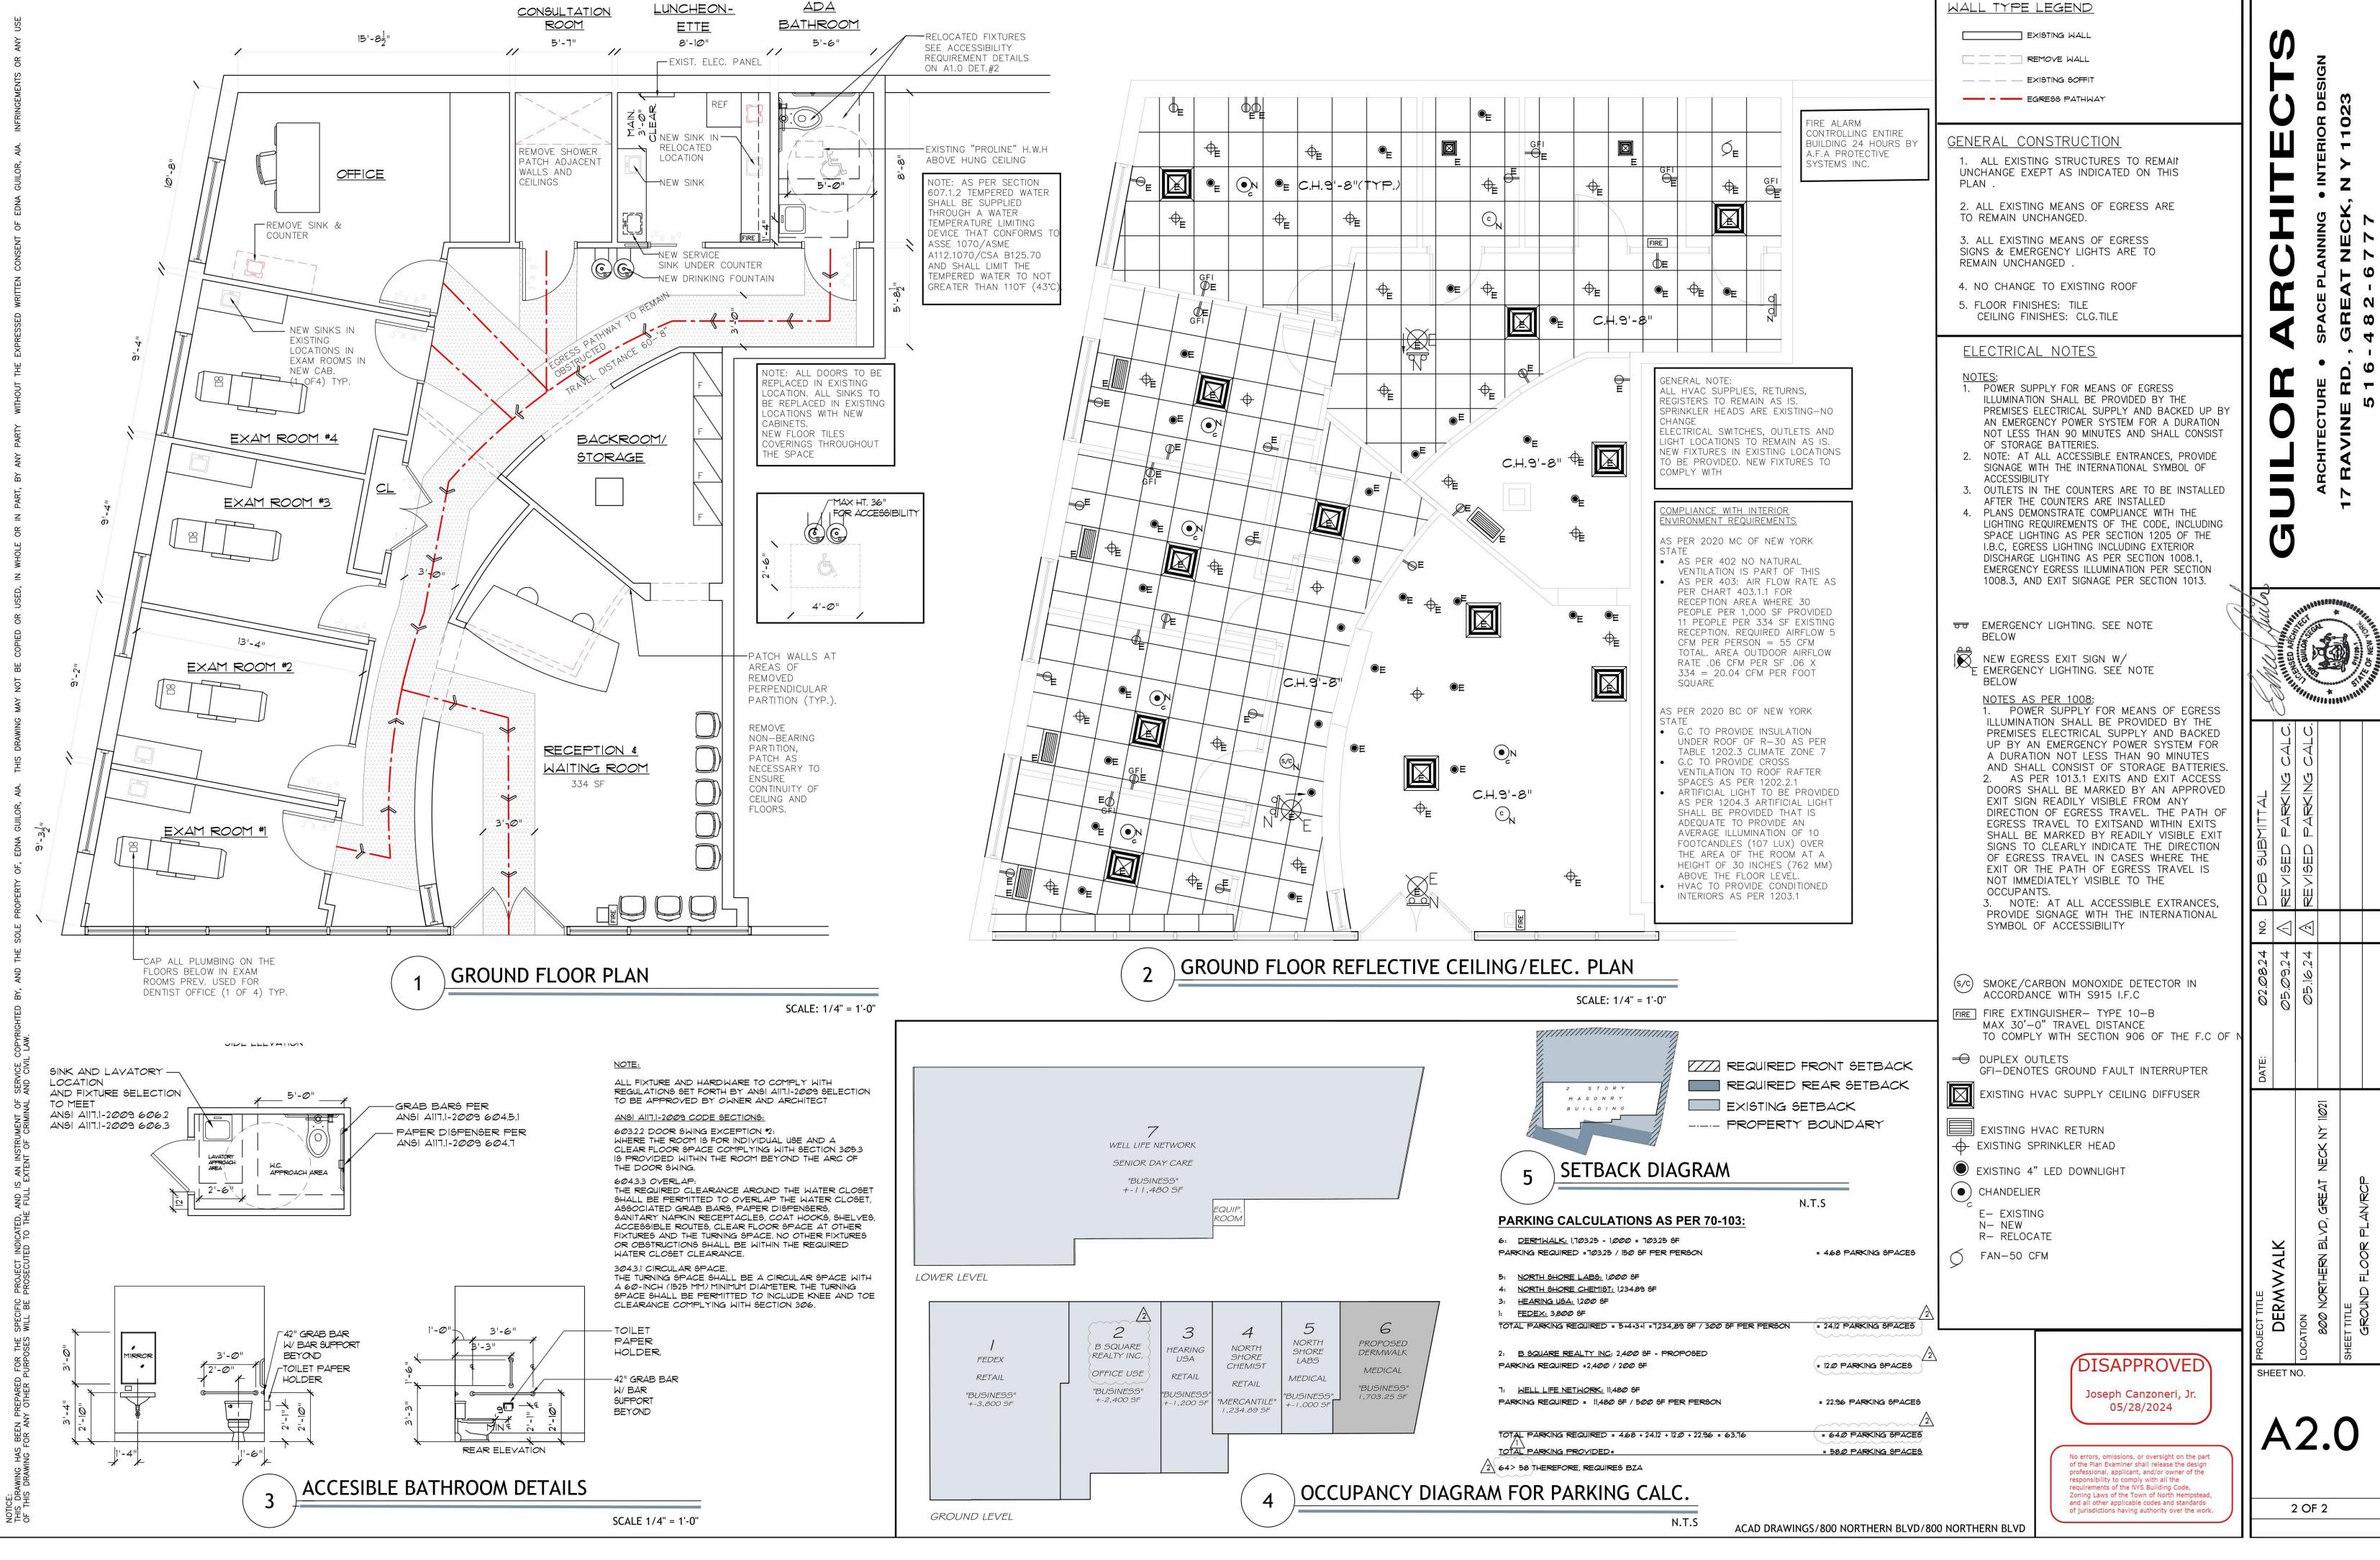

LIST OF DRAWINGS

T-1 TITLE PAGE, SITE PLAN, PLUMBING & GAS RISER DIAGRAM, AREA DIAGRAMS, **GENERAL NOTES, DRY WELL CALCS**

A-1 EXISTING FIRST &SECOND FL, EXISTING FRONT ELEVATION, ZONING

A-2 PROP FOUNDATION, FINISHED CELLAR **LEGEND**

A-3 PROP FIRST &SECOND FLOOR A-4.LIGHT&VENT CALCS.SECTIONS, LEGEND A-5 FRONT AND RIGHT ELEVATION

A-6 REAR AND LEFT ELEVATION

A-7 GARAGE PLANS

S-1 FIRST FLOOR STRUCTURAL

S-2 SECOND FLOOR STRUCTURAL

D-1 DETAILS

D-2 DETAILS

D-3 EXTERIOR WALL DETAILS

ADMINISTRATIVE NOTES

D-4 ENERGY DETAILS

THESE PLANS MUST BE APROVED BY THE LOCAL MUNICIPALITY AND A PERMIT BE ISSUED BEFORE WORK BEGINS. THE ENGINEER, DRAFTSMAN OR EXPEDITOR WILL NOT BE HELD

SUBSTANDARD CONSTRUCTION PRACTICES. THE ENGINEER OF RECORD HAS NOT BEEN RETAINED FOR THE SUPERVISION OF THIS PROJECT.

RESPONSIBLE FOR DEFECTS IN MATERIALS, STRUCTURE OR

NO CHANGES WILL BE PERMITTED WITHOUT PRIOR WRITTEN NOTIFICATION OF AND APPROVAL OF THE ENGINEER OF RECORD. NO CONSTRUCTION OR DEMOLITION SHALL COMMENCE PRIOR TO THE ISSUANCE OF THE BUILDING PERMIT.

ALL ELECTRICAL WORK TO BE INSPECTED BY A CERTIFIED ELECTRICAL INSPECTOR.

THE CONTRACTOR SHALL PROVIDE ALL REQUIRED INSURANCE AND INSURANCE CERTIFICATES.

LICENSED PLUMBER TO OBTAIN PERMITS AND INSPECTIONS FOR

ALL PLUMBING WORK. THESE PLANS INDICATE REQUIRED INFORMATION FOR BUILDING DEPARTMENT USE. THE CONTRACTOR SHALL COORDINATE WITH

OWNER FOR ALL MATERIALS AND FINISHES ELECTRIC WORK TO BE IN ACCORDANCE WITH N.E.C. AND TO BE CERTIFIED BY THE NEW YORK BOARD OF FIRE UNDERWRITERS.

NOTED DIMENSIONS TAKE PRECEDENCE OVER SCALE. **NYS 2020 CODE NOTES**

ALL CONSTRUCTION SHALL BE IN ACCORDANCE WITH THE BUILDING CODE 2020 OF NEW YORK STATE.

GROUND SNOW LOAD IS 20# SQ./FT.

WIND SPEED IS 120 MPH SEISMIC DESIGN CATEGORY "C" AND ASCE 7-98

THIS PROPERTY IS NOT WITHIN ONE MILE FROM SHORE LINE ALL PLUMBING WORK SHALL COMPLY TO THE RESIDENTIAL CODE OF IEW YORK STATE AND ALL OTHER APPLICABLE CODES, LAWS

RULES, REGULATIONS AND HEALTH DEPARTMENT REQUIREMENTS.

ALL PLUMBING FIXTURES SHALL BE INDIVIDUALLY TRAPPED AND VENTED AS REQUIRED BY THE NYS CODE. CAST IRON PIPE SHALL CONFORM WILL LOCAL CODE REQUIREMENTS AND HAVE APPROVED CLEAN OUTS AND JOINTS.

ALL ELECTRICAL OUTLETS, SWITCHES, LIGHTS AND WIRING SHALL BE U.L. CERTIFIED AND INSTALLED IN COMPLIANCE WITH NEC AND LOCAL ELECTRICAL CODES.

ALL INTERIOR DOORS ARE TO CONFORM WITH THE RESIDENTIAL

CODE OF NEW YORK STATE. ALL HEATING AND COOLING DESIGNS SHALL CONFORM WITH

A.S.H.R.A.E.

EGRESS WINDOW CODE:

R310.1.1. MINIMUM OPENING AREA. ALL EMERGENCY ESCAPE AND RESCUE OPENINGS SHALL HAVE A MINIMUM NET CLEAR OPENING OF 5.7 SQUARE FEET. (SECOND FLOOR)

EXCEPTION GRADE FLOOR OPENINGS SHALL HAVE A MINIMUM NET CLEAR OPENING OF 5.0 SQUARE FEET.

R310.12 MINIMUM OPENING HEIGHT. THE MINIMUM OPENING HEIGHT SHALL BE 24 INCHES. R310.13 MINIMUM OPENING WIDTH. THE MINIMUM NET CLEAR OPENING

WIDTH SHALL BE 20 INCHES. R310.1.4 OPERATIONAL CONSTRAINTS. EMERGENCY ESCAPE AND

RESCUE OPENINGS SHALL BE OPERATIONAL FROM THE INSIDE OF THE ROOM WITHOUT THE USE OF KEYS OR TOOLS. **GENERAL BUILDING NOTES**

ALL FINISH MATERIALS TO HAVE CLASS "A" FLAME SPREAD RATING WINDOWS AND DOORS SHALL BE PROPERLY FLASHED AT HEADS AND PROPERLY SEALED AND WEATHER -STRIPPED.

ALL GYPSUM SHALL BE TAPED AND SPACKLED (3 COATS) READY FOR PAINT. 1/2 INCH SHEETROCK FOR ALL WALLS & CEILING'S . 5/8 TYPE X FOR ALL GARAGE AND MECHANICAL ROOMS. 1/2 INCH M/R GREENBOARD FOR ALL BATHROOMS.

ALL STRUCTURAL STEEL TO BE ASTM A36

AT LEAST ONE SINGLE STATION SMOKE DETECTING ALARM DEVICE INSTALLED IN CONFORMITY WITH SECTION R 317 IN EACH SLEEPING ROOM AND OUTSIDE EACH SLEEPING AREA AND ON EACH STORY -INTERCONNECTED.

INSTALL ALL WINDOWS NOT MORE THAN 44" ABOVE FLOOR. AREA OF WINDOWS AND SKYLITES SHALL BE 8% OF EXTERIOR WALL

GLAZING IN DOORS, SHOWER DOORS AND ENCLOSURES SHALL BE SIZED AND CONSTRUCTED OF MATERIALS AS TO MINIMIZE THE POSSIBILITY OF INJURY TO PERSONS IN THE EVENT THAT THE GLAZING IS BROKEN OR DAMAGED.

ROOF RAFTERS AND CRAWL SPACES TO BE VENTED AS PER N.Y.S.

ALL STAIRS SHALL HAVE HANDRAILS IN ACCORDANCE WITH IBC R

PROVIDE FIRE STOPS TO CUT OFF ALL CONCEALED DRAFT OPENINGS (BOTH VERTICAL & HORIZONTAL) AND TO FORM AN EFFECTIVE FIRE BARRIER BETWEEN STORIES, AND BETWEEN TOP STORY AND THE ROOF SPACE.

NO SLEEPING OR COOKING ROOMS PERMITTED IN CELLAR

SCOPE: PROPOSED FIRST FLOOR REAR ADDITION, INTERIOR ALTERATIONS AND RENOVATONS ALL FIRST FLOOR, NEW KITCHEN, NEW 1.5 BATH, FINISH BASMT W/NEW BATH, NEW GAS BOILER, CAC, FULL SECOND FLOOR WITH TWO FULL BATHS .DRYWELL.DETACHED GARAGE

NYS IECC 2018 NOTES

1. MINIMUM DOOR U-RATING: U-.40

2. MINUMUM WINDOW, SLIDING GLASS DOORS:

GRADE 60 LOW E GLASS U-.58

3. ALL DOMESTIC HOT WATER 140 DEGREES MAXIMUM SETTING.

4. INSULATE ALL PIPING AS REQUIRED BY CODE. 5. DOORS, FRONT, SIDE, INSIDE TO GARAGE -U-40 MAXIMUM

6. WINDOWS, GLASS DOORS, ALL GLASS - U-.32 MAXIMUM

7. INSULATE ALL DUCTS AND PIPING AS REQUIRED BY IPC 2015 8. ALL FIREPLACES TO BE PROVIDED WITH DAMPER FOR OUTSIDE COMBUSTION

AIR 150-200 CFM. FLUE TO HAVE TIGHT SEATED DAMPER TO MAINTAIN MINIMUM AIR LEAKAGE TO 20 CFM 0.3 INCHES WATER GAUGE. INTERIOR OPENING TO BE PROVIDED WITH HEAT RESISTANT GLASS DOORS (SEE **SECTION 1813.5)**

9. CALCULATIONS ARE VALID UP TO 5999 DEGREE DAYS.

10. WOOD FRAMED FLOORS, WALLS AND CEILINGS SHALL HAVE AN APPROVED VAPOR BARRIER (PERMEANCE RATING OF 1.0 PERM) INSTALLED ON THE "WARM IN WINTER" SIDE OF THERMAL INSULATION.

11. WINDOWS AND SLIDING DOORS SHALL HAVE A MAX. AIR INFILTRATION RATING OF 0.3 CFM PER SQUARE FOOT OF WINDOW AREA. SWINGING DOORS SHALL HAVE A MAX. AIR INFILTRATION RATE OF 0.5 CFM PER SQUARE FOOT OF DOOR AREA.

12. SKYLIGHT SHAFTS SHALL HAVE A MINIMUM INSULATION VALUE OF R-19.

13. GARAGES - FRONT, SIDES, DOORS, INTERIOR SHALL HAVE MAX. U=.40. 14. ALL FIREPLACES HALL BE PROVIDED WITH A DAMPER FOR OUTSIDE COMBUSTION AIR 150-200 CFM. ALL FLUES SHALL HAVE TIGHT SEATED DAMPER WITH A MAX. AIR LEAKAGE OF 20 CFM.

MECHANICAL SYSTEMS WHICH WILL BE USED, IN SUFFICIENT DETAIL, AS REQUIRED BY THE BUILDING DEPARTMENT.

15. THE CONTRACTOR SHALL SUBMIT THE DESIGN. SIZE AND TYPE OF

16. ALL THERMOSTATS SHALL BE ADJUSTABLE FROM 55 DEGREES TO 85 DEGREES FAHRENHEIT.

17. ALL DUCTS AND PIPES SHALL BE INSULATED AS REQUIRED BY CODE. 18. H.V.A.C. CONTRACTOR SHALL VERIFY HEAT LOSS CALCULATIONS. **INSULATION NOTES:**

1. G.C. IS RESPONSIBLE TO FOLLOW NEW ENERGY CODE REQUIREMENTS SET BY NYS IECC 2015 AND 2016 SUPPLEMENT FOR IECC 2015 AUGUST 2016 EDITION (e.g. "NYS 2015 ENERGY CODE").

2. REFER TO PROVIDED RES-CHECK FROM CONSTRUCTION DOCUMENTS FOR ALL INSULATION SIZES AND RATINGS OTHERWISE FOLLOW IECC TABLE R402.1.2 FOR GUIDELINES ON INSULATION REQUIREMENTS FOR VARIOUS BUILDING THERMAL ENVELOPE ELEMENTS.

3. G.C.AND OWNER ARE RESPONSIBLE TO MAKE SURE THAT ALL OF THE LISTED ELEMENTS BELOW MEET OR EXCEED NEW NYS 2015 ENERGY CODE

a. ALL THERMAL ENVELOPE PERIMETER WALLS TO BE COVERED BY SHOWER OR TUB FIXTURES OR THEIR ENCLOSURES TO BE FULLY INSULATED AND VAPOR BARRIERS INSTALLED (PRIOR TO THEIR

b. CONTINUOUS FOUNDATION INSULATION AS REQUIRED WITHOUT BREAKS IN CONTINUITY IS PROVIDED. IF APPLIED TO EXTERIOR OF SLAB/FOUNDATION PROVIDE SUFFICIENT PROTECTION FROM PHYSICAL DAMAGE AND ELEMENTS.

c. ALL FENESTRATION OPENINGS ARE AIR-SEALED WITH SPRAY FOAM OR EQUAL. DO NOT USE AIR-PERMEABLE INSULATION.

d. ALL EXTERIOR DOOR AND WINDOW HEADERS ARE PROPERLY INSULATED WITH R-3 RIGID INSULATION OR EQUAL.

e. RIM JOISTS BETWEEN FLOORS TO RECEIVE APPROPRIATE WALL

FLOORS IN ROOMS ABOVE UNCONDITIONED OR EXTERIOR SPACE TO HAVE APPROPRIATE INSULATION ATTACHED TO BOTTOM OF SUBLECOR. OTHERWISE FLOOR JOIST SPACE HAS TO BE AIR-SEALED FROM ANY

g. RECESSED LIGHTING INSIDE THERMAL ENVELOPE CEILINGS TO BE AIR-TIGHT BY MEANS OF SEALANTS, GASKETS OR ADHESIVES.

h. ATTIC ACCESS PANELS AND PULL-DOWN STAIRS TO RECEIVE SAME INSULATION AS THE REST OF THE CEILING. PROVIDE AIR-TIGHT GASKETS AND FILL IN GAPS IN INSULATION

i. WOOD BURNING FIREPLACES MUST HAVE TIGHT-FITTING FLUE DAMPENER OR DOORS

4. G.C. TO FOLLOW STRICT INSULATION INSTALLATION PRACTICES AS NOTED **BELOW:** a. AVOID ANY COMPRESSION, ESPECIALLY BEHIND UTILITIES, LIGHTING AND

IN TIGHT STUD SPACES. PROVIDE FOAM INSULATION BEHIND UTILITIES INSIDE INSULATED WALLS, FLOORS OR CEILINGS.

b. DO NOT CUT OR PENETRATE VAPOR BARRIERS

c. INSULATION AROUND ELECTRICAL BOXES MUST BE TIGHTLY CUT AROUND. DO NOT TUCK OR COMPRESS INSULATION.

d. INTERIOR CELLAR AND BASEMENT INSULATION TO RECEIVE FULL-HEIGHT INSULATION - DO NOT TRIM OFF BOTTOM.

5. G.C. IS RESPONSIBLE TO CONDUCT "DOOR BLOWER TEST" FOR H.E.R.S. COMPLIANCE ONCE ALL HOUSE ELEMENTS ARE PROPERLY INSULATED BUT BEFORE WALL—COVERINGS ARE INSTALLED AS PER NYS IECC 2015 ENERGY

HVAC REQUIREMENTS:

1. HVAC CONTRACTOR TO COORDINATE WITH ARCHITECT AND HOMEOWNER LOCATION OF ALL HVAC DUCTS AND VERIFY IF ANY PORTIONS OF THE DUCTS ARE NOT WITHIN A BUILDING THERMAL ENVELOPE.

2. HVAC CONTRACTOR IS REQUIRED TO CONDUCT DUCT "AIR LEAKAGE TEST" IF ANY HVAC DUCTS ARE FOUND TO BE OUTSIDE BUILDING THERMAL

3. HVAC CONTRACTOR TO PROPERLY SIZE HEATING AND COOLING EQUIPMENT USING ACCA MANUALS J AND S

MECHANICAL VENTILATION: 1. NEW BUILDINGS TO BE CONSTRUCTED MUST MEET MECHANICAL VENTILATION REQUIREMENTS BASED ON 3 ACH50 H.E.R.S. RATING: ANY HOUSE UNDER 5 ACH50 MUST PROVIDE "WHOLE HOUSE MECHANICAL

VENTILATION". 2. TO MEET MECHANICAL VENTILATION REQUIREMENTS MECHANICAL CONTRACTOR MAY USE "EXHAUST ONLY" METHOD BY PROVIDING HALLWAY AND BATHROOM VENTS WITH TIMERS SET TO FOLLOW CODE-REQUIRED

MECHANICAL CONTRACTOR TO FOLLOW NYS IECC 2015 R403.6 AS WELL AS INTERNATIONAL MECHANICAL CODE AS TO INSTALLATION OF VENTS. DAMPENERS, MAKE-UP AIR AND VENTILATION REQUIREMENTS

LIGHTING NOTES:

G.C. TO PROVIDE HIGH-EFFICIACY LIGHTING (75%+) THROUGHOUT: USE CFL, LED, OR FLUORESCENT LIGHTING

FRAMING NOTES

ALL WOOD FRAMING, INCLUDING JOISTS, BEAMS, POSTS, STUDS ETC. TO BE DOUGLAS FIR GRADE #2 OR BETTER.

ALL MICROLAM LUMBER IS TO BE MANUFACTURED BY GEORGIA PACIFIC ENGINEERED LUMBER OR APPROVED EQUAL.

WINDOWS AND DOORS HAVE TO BE AT LEAST 6" FROM GYPSUM-BOARD OF THE ROOM CORNERS TO ALLOW FOR MOLDINGS AND TRIM

LINE UP ALL POSTS AND ENGINEERING COLUMNS IN WALLS WITH WALL STUDS DOUBLE ALL FLOOR JOISTS UNDER ALL JACUZZIS

ALL PLUMBING ("WET") WALLS TO BE FRAMED WITH 2x6 FRAME OR WIDER ALLOW A MINIMUM OF 18' BETWEEN BOTTOM OF FLOOR JOIST AND TOP OF SCREED COAT OR

PROVIDE CCA. LUMBER. PROVIDE DOUBLE HEADERS AT ALL FLOOR CEILING, STAIR AND ROOF OPENINGS ALL HEADERS TO BE A MINIMUM OF (2) 2 X 8 OPENING UP TO 36 INCHES ,2-2X10 UP TO 6FT OPENING , UNLESS OTHERWISE NOTED ON PLANS.

FLOOR JOISTS SHALL BE DOUBLED BENEATH ALL PARALLEL PARTITIONS.

WOOD SILLS ON SLAB TO BE 2 2" X 4" PT LUMBER WITH 5/8" DIA. ANCHOR BOLTS MAX. 3' O.C. 12" FROM CORNER.

ALL HEADERS TO BE SUPPORTED BY (2) 2x4 POSTS TYPICAL U.O.N. PROVIDE DOUBLE HEADER AND TRIMMERS AT ALL STAIR AND FLOOR OPENINGS AND UNDER ALL

POSTS AND PARTITIONS RUNNING PARALLEL TO SAME. BRIDGING TO BE EITHER SOLID OR 18 ga. CROSS BRIDGING NOT EXCEEDING 8' O.C.

THE TOP AND BOTTOM OF JOISTS MAY BE NOTCHED - NOT TO EXCEED 2". NO NOTCHING AT

MIDDLE 3 OF SPAN (D16). JOISTS HANGERS AND OTHER METAL FASTENERS TO BE 'TECO' OR EQUAL.

ALL STRUCTURAL WOOD MEMBERS TO BE KEPT BACK 2" FROM CHIMNEY.

CONCRETE NOTES

ALL CONCRETE WORK SHALL CONFORM TO ACI-318 SPECIFICATIONS FOR STRUCTURAL CONCRETE FOR BUILDINGS AND ACI-301 BUILDING CODE REQUIREMENTS FOR REINFORCED CONCRETE.

ALL CONCRETE CAST IN PLACE SHALL HAVE 3500 PSI MINIMUM 28 DAY COMPRESSIVE

WELDED WIRE FABRIC SHALL CONFORM TO ASTM A-185 WITH A MINIMUM ULTIMATE STRENGTH OF 70,000 PSI, UON.

ALL FOUNDATIONS AND FOOTINGS SIZED FOR BEARING ON VIRGIN SOIL AT MINIMUM BEARING CAPACITY OF 2 TONS PER SQ. FT. MINIMUM OF 3" COVER. MINIMUM CONCRETE COVERING OF REINFORCING STEEL SHALL BE 3" FOR FOOTINGS AND BEAMS

POURED DIRECTLY AGAINST SOIL. PROVIDE PROPER HIGH CHAIRS, SPACERS AND SUPPORTS TO HOLD REINFORCING SECURELY IN

PLACE WHILE PLACING CONCRETE. MAXIMUM DIMENSION OF ANY CONTINUOUS CONCRETE POUR SHALL NOT EXCEED 20 FEET IN ANY DIRECTION. CONSTRUCTION, CONTROL & ISOLATION JOISTS SHALL CONFORM TO ACI

PROVIDE WATERSTOPS AT ALL CONSTRUCTION JOINTS BELOW GRADE LEVEL. CALCIUM CHLORIDE SHALL NOT BE USED IN CONCRETE MIXES.

COLD WEATHER CONCRETING SHALL BE IN ACCORDANCE WITH ACI-306. NO BACKFILL ALLOWED ON CONCRETE FOUNDATION WALLS UNLESS THE WALLS ARE BRACED

THE EXTERIOR SURFACE OF ALL FOUNDATION WALLS BELOW GRADE (EXCLUDING SLABS) SHALL BE DAMPROOFED WITH AN ELASTIC COAL TAR BASE.

FOR ALL 6" POURED CONCRETE SLABS, PROVIDE 6" X 6" HR WWF OVER 6 MIL POLYETHYLENE VAPOR BARRIER OVER 6" WELL COMPACTED FILL.

1280.2 SF

C

PROPOSED LOT COVERAGE

INCLUDING BRICK FACADE

25.0'

24.75

DRAINAGE CALCULATIONS GARAG D &EAVES

COVERAGI

300 SF

A (MAIN DWELLING)=30.92X46.33=1433 SF B (FRONT ADDITION)= 1.5X14.5=21.75 S

A (MAIN DWELLING)=30.92X46.33=1433 SF


B (REAR ADDITION)= 25.0X7.45=186 SF

C (FRONT ADDITION)= 1.5X14.5=21.75 SF

GROSS FLOOR AREA

FIRST FLOOR TOTAL=

EITHER BY FLOOR OR BRACED BY INTERIOR FACE.

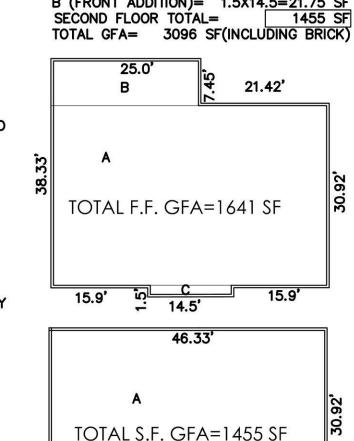

LOT COVERAGE

C (REAR PLATFORM)=

E (FRONT PORTICO)=

TOTAL=

A (MAIN DWELLING)=30.92X46.33=1433 SF

B (REAR ADDITION)= 25.0X7.45=186 SF

D (FRONT ADDITION)= 1.5X14.5=21.75 SF

TOTAL WITH GARAGE= 1736+300=2036 SF

10.0X4.0=40 SF

5.0X11.0=55 SF

WALKWAY DRAINAC DRVEWAY/WALKWAY A=10.5+17+3.8=52.8 SF DRAINAGE AREA IN SF B = 24.75X30 = 742.5 SF359 SF C = 46.75X8.6 = 402.1 SFEXIST: 1334+330=1664 SF D = 8.5X9.75 = 82.8 SF1280.2 SF TOTAL= x 8' 338 C.F. MAIN HOUSE 1893 SF DRVEWAY & WALKWAY

198 SF

48 SF

25 SF

DRIVEWAY &

WALKWAY

D=

TOTAL=1893 ST

TOTAL INCLUDING GARAGE= 2252 SF

SECOND FLOOR

FIRST FLOOR

1" GAS MAIN TO -

VALVE —

GAS METER ---

UNION -

B.U.G. MAIN

BASED ON CONTAINMENT OF 2.5" RAINFALL IN 24 HOUR PERIOD AREA (SF) 2.5"RAINFALL COEF. | CUBIC FEET HOUSE .208 1.0 <u>394.0 CF</u> NEW DRIVEWAY 1280.2 SF .208 266.3 CF 1.0 <u>74.7 CF</u> .208 .208 AL IMPERVIOUS SURFACE al capacity required 735 __ * DRAINAGE AREAS ARE NOT EQUAL TO LOT COVERAGE AREAS DUE TO BUILDING ROOF EAVES USE: (1) 8'-0 ø x 8'-0 H. PRECAST DRYWELL WITH 2'-9" X 8'Ø PRECAST CONRETE DOME COVER 42.24 C.F. PER FOOT HEIGHT =393.0[2 DRYWELLS]=786 CF. PROVIDED= OK

REAR YARD

DRAINAGE CALCULATIONS PROPOSED

PENETRATION INTO ACCEPTABLE LEACHING MATERIAL DRYWELL DETAIL BACKFILL UNDER AND AROUND DRYWELL WITH GRANULAR MATERIAL CONTAINING LESS THAN 15% FINE SAND, SILT & CLAY. (SILT & GLAY FUNCTION NOT TO EXCEED %5

#21580

BRICK UP-AS REQ'D

PRECAST CONC.

3'-0" MIN.

FINISH GRADE-

PROPOSED

GAS RANGE

TYP. SHUT OFF

BOILER

ALL PLUMBING EQUIPMENT AND SYSTEMS SHALL BE

DESIGNED AND INSTALLED IN CONFORMITY WITH THE

CONTRACTOR SHALL VERIFY ALL WASTE, VENT AND

SUBMIT PROPOSED LOCATIONS OF ALL VENTS THRU

GARAGE

300 SF

DRIVEWAY

152SF

REAR YARD COVERAGE 24%

83SF

FRONT YARD COVERAGE 49%

61SF

FRONT YARD

ROOF TO ENGINEER FOR APPROVAL PRIOR TO

SEPTIC SYSTEM TO BE UPGRADED AS REQUIRED

ALL HOT AND COLD WATER PIPING SHALL BE INSULATED

INSTALLATION. VENTS INSTALLED PRIOR TO APPROVAL

GAS RISER DIAGRAM

PLUMBING CODE OF N.Y.S.

SHALL BE RELOCATED.

PIPING SIZES AS PER CODE.

TO PREVENT SWEATING OR FREEZING.

VALVE___

C.I. FRAME WITH GRATE NEENAH NO.2595 OR

NEENAH NO.R1695 OR APPROVED EQUAL

12" MIN.- 24" MAX

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A

360

PROPOSED

DETACHED GARAGE PROPOSED 2 STORY FRAME DWELLING F.F.E 127.93°

> CONC. CURB BREGMAN AV

CONCRETE SIDEWALK

LEGALIZE FENCE HT: 6.

EXISTING

1 STORY FRAME

DWELLING

CONCRETE SIDEWALK

CONC. CURB

F.F.E 127.93'

GARAGE SLAB'

EL.125.88°

15.9'

CURB CUT

SCALE 1"=16'

EXISTING SITE PLAN

TO REMAIN [BE LEGALIZED] VINYL

FENCE HT: 6' 58.7' LENGTH

00

DISAPPROVED

05/14/2024

0

Reyes

PROPOSED SITE PLAN SCALE 1"=16'

> ALL INFORMATION TAKEN FROM LALSA LAND SURVEYING PLLC QUEENS ,NY 11433 PH 347 869 0590 EMPIREGEODRAFTINGLLC@GMAIL.COM

REVISIONS AS PER COMMENTS 2/14/24 AS PER COMMENTS 1/3/24 AS PER COMMENTS 12/18/23 ON 12/15/23 12/14/23 FIRST FILING

BUILDING USE: 1 FAM. RES. ZONING: R-C

CHECKED BY: HELEN 12/14/23 AS NOTED

COPE: PROPOSED FIRST FLOOR REAR ADDITION ,INTERIOR ALTERATIONS AND RENOVATONS ALL FIRST FLOOR .NEW KITCHEN .NEW 1.5 BATH FINISH BASMT W/NEW BATH,NEW GAS BOILER,CAC,FULL SECOND FLOOR WITH TWO FULL BATHS ,2 DRYWELLS, DETACHED GARAGE NEW DRIVEWAY

PROPERTY INFORMATION <u> ADDRESS:</u> 50 BREGMAN AVENUE, NEW HYDE PARK

LEGEND


TAX MAP No: SECTION: 8 BLOCK: 212 LOTS: 110

EXTENSION

DESCRIPTION DRAWING NO.

HELEN BOGDANOS, P.E

DATE

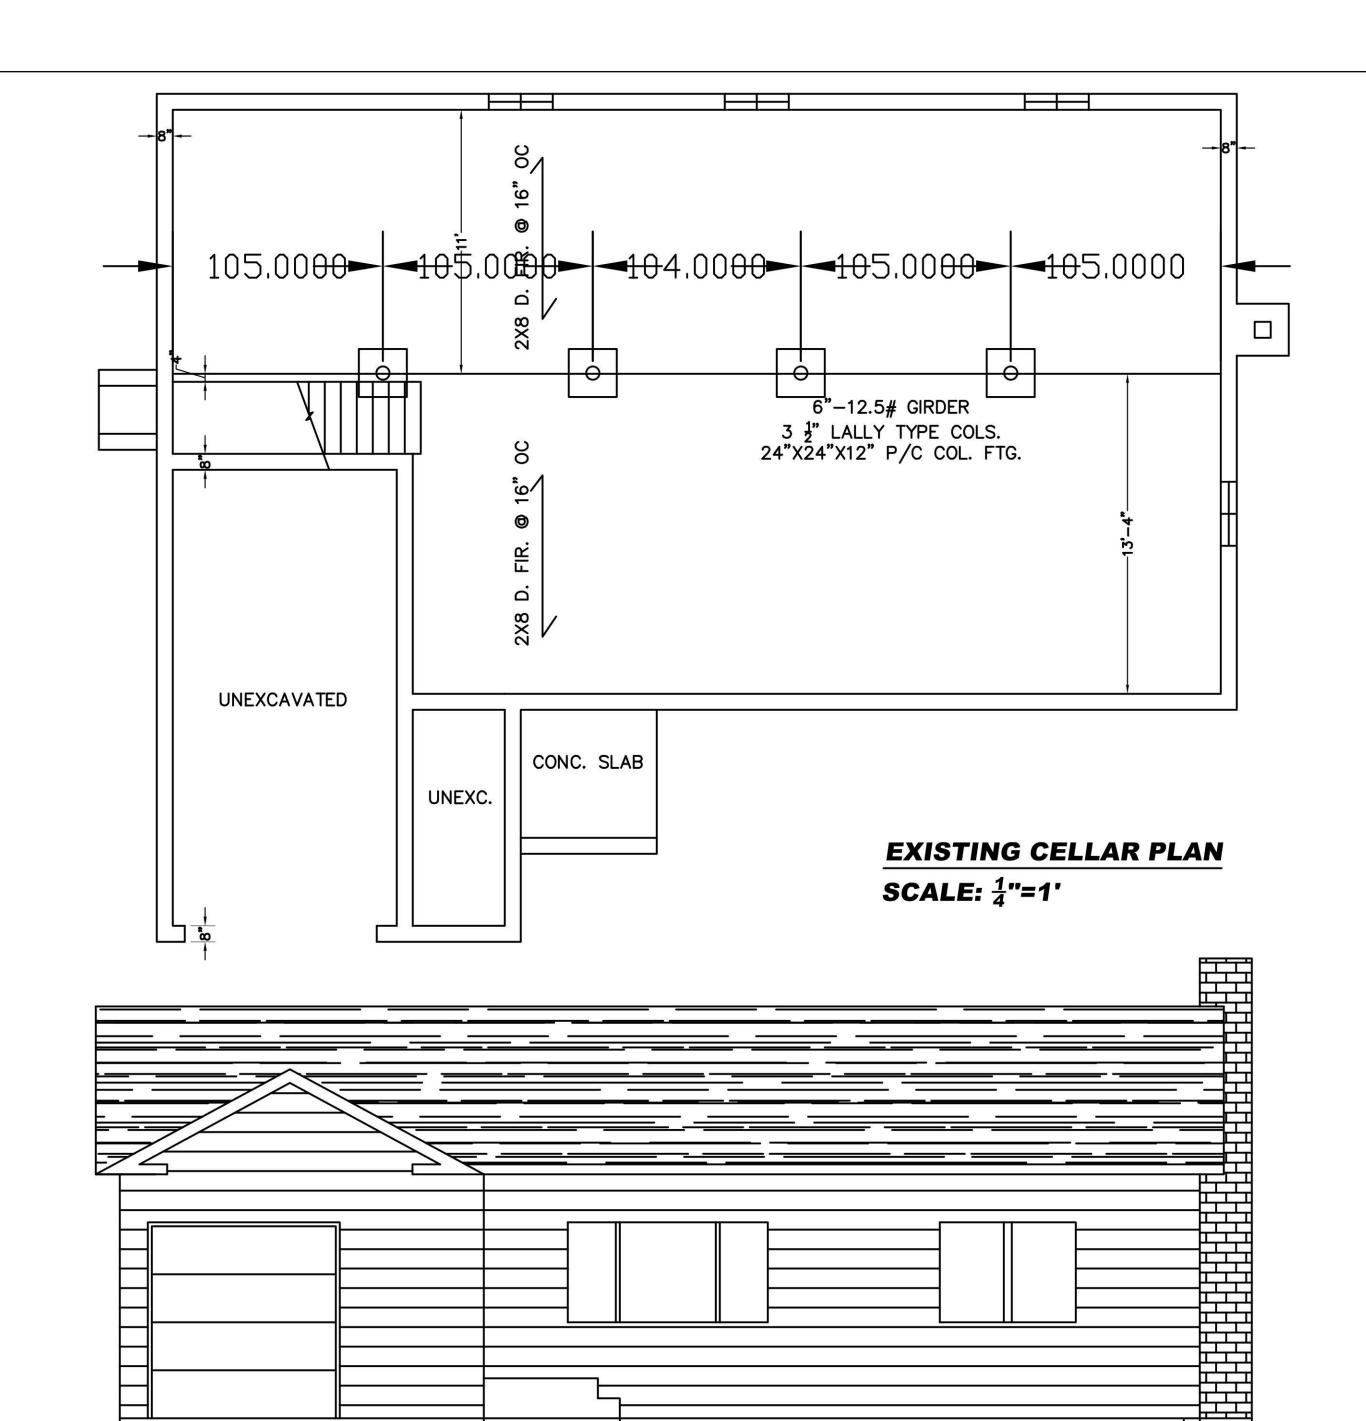



ZONING ANALYSIS * ASTERISC INDICATES VARIANCE ADDRESS: 50 BREGMAN AVENUE, NEW HYDE PARK ** MUNICIPALITY: TOWN OF NORTH HEMPSTEAD ZONE: R-C SECTION: 8 BLOCK: 212 LOT: 110						
ITEM	REQ./PERMITTED	EXISTING	PERMITTED	PROPOSED		
LOT AREA	5,000 S.F.	6,000 S.F.	6,000 S.F.	6,000 S.F.		
LOT WIDTH	40 FT.	60 FT.	60 FT.	60 FT.		
LOT COVERAGE	35% = 1,733 S.F.	22%=1336S.F.	2100 S.F.	2036 S.F.		
MAX. G.F.A.	50% = 2,475 S.F.	1,302 S.F.	2,800 S.F.	3096 S.F * 296 SF OVER		
FRONT YARD	25.0 FT.	25.2 FT.		28.4 FT.		
AVER. FRONT YARD	26.3 FT.	26.3 FT.	26.3 FT.	26.3 FT.		
SIDE YARD	5.00 FT.	5.2 FT.	5.00 FT.	4.75 FT*. W/BRICK*.		
AGG. SIDE YD.	15 FT	14.5 FT.	15 FT.	13.5 FT.		
MIN. REAR YARD	15 FT.	38.8 FT.		31.75 FT.		
MAX. HEIGHT	30 FT.	ONE STORY		29.5 FT.		
MAX. EAVE	22 FT.	ONE STORY		20.1 FT.		
MAX. REAR YD. COVERAGE	40%			2098SF/513SF=24%		
MAX. FRONT YD. COVERAGE	55%			1775SF/869SF=49%		
FIRST FLOOR				1641 S.F		
SECOND FLOOR				1455 S.F		


UNEXCAVATED

scale: 1/4" = 1'-0

EXISTING FRONT ELEVATION

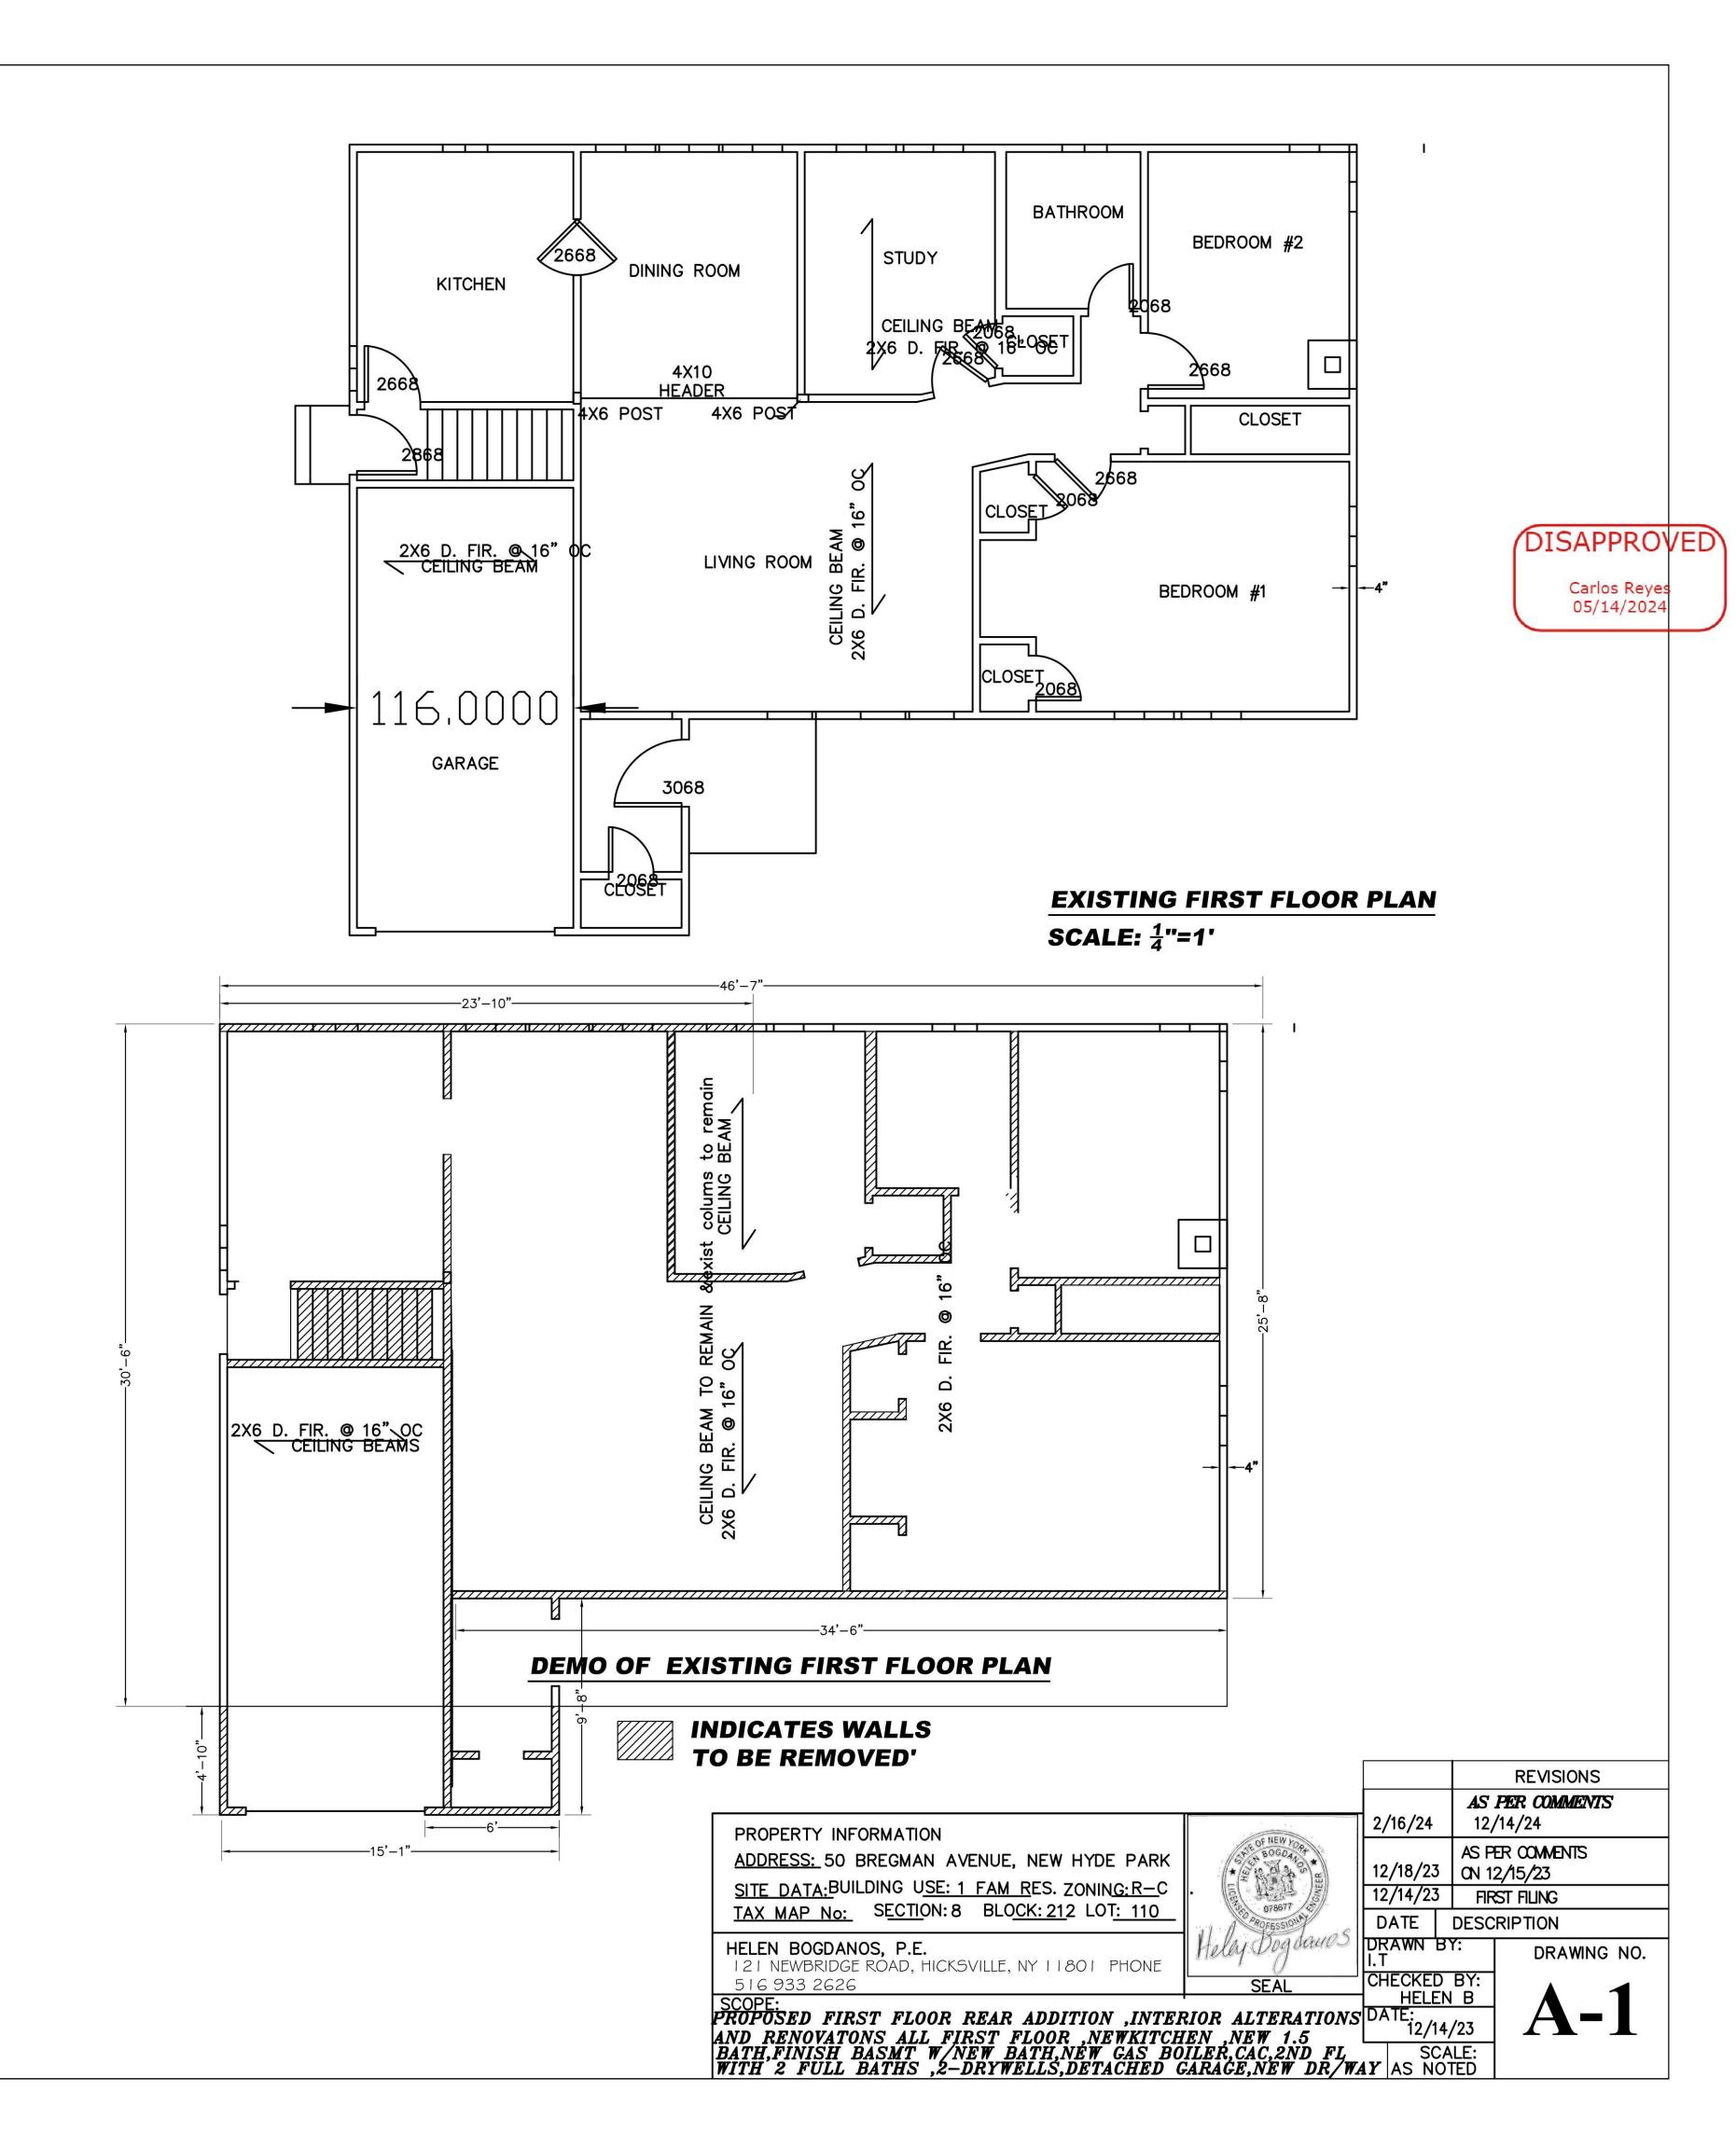

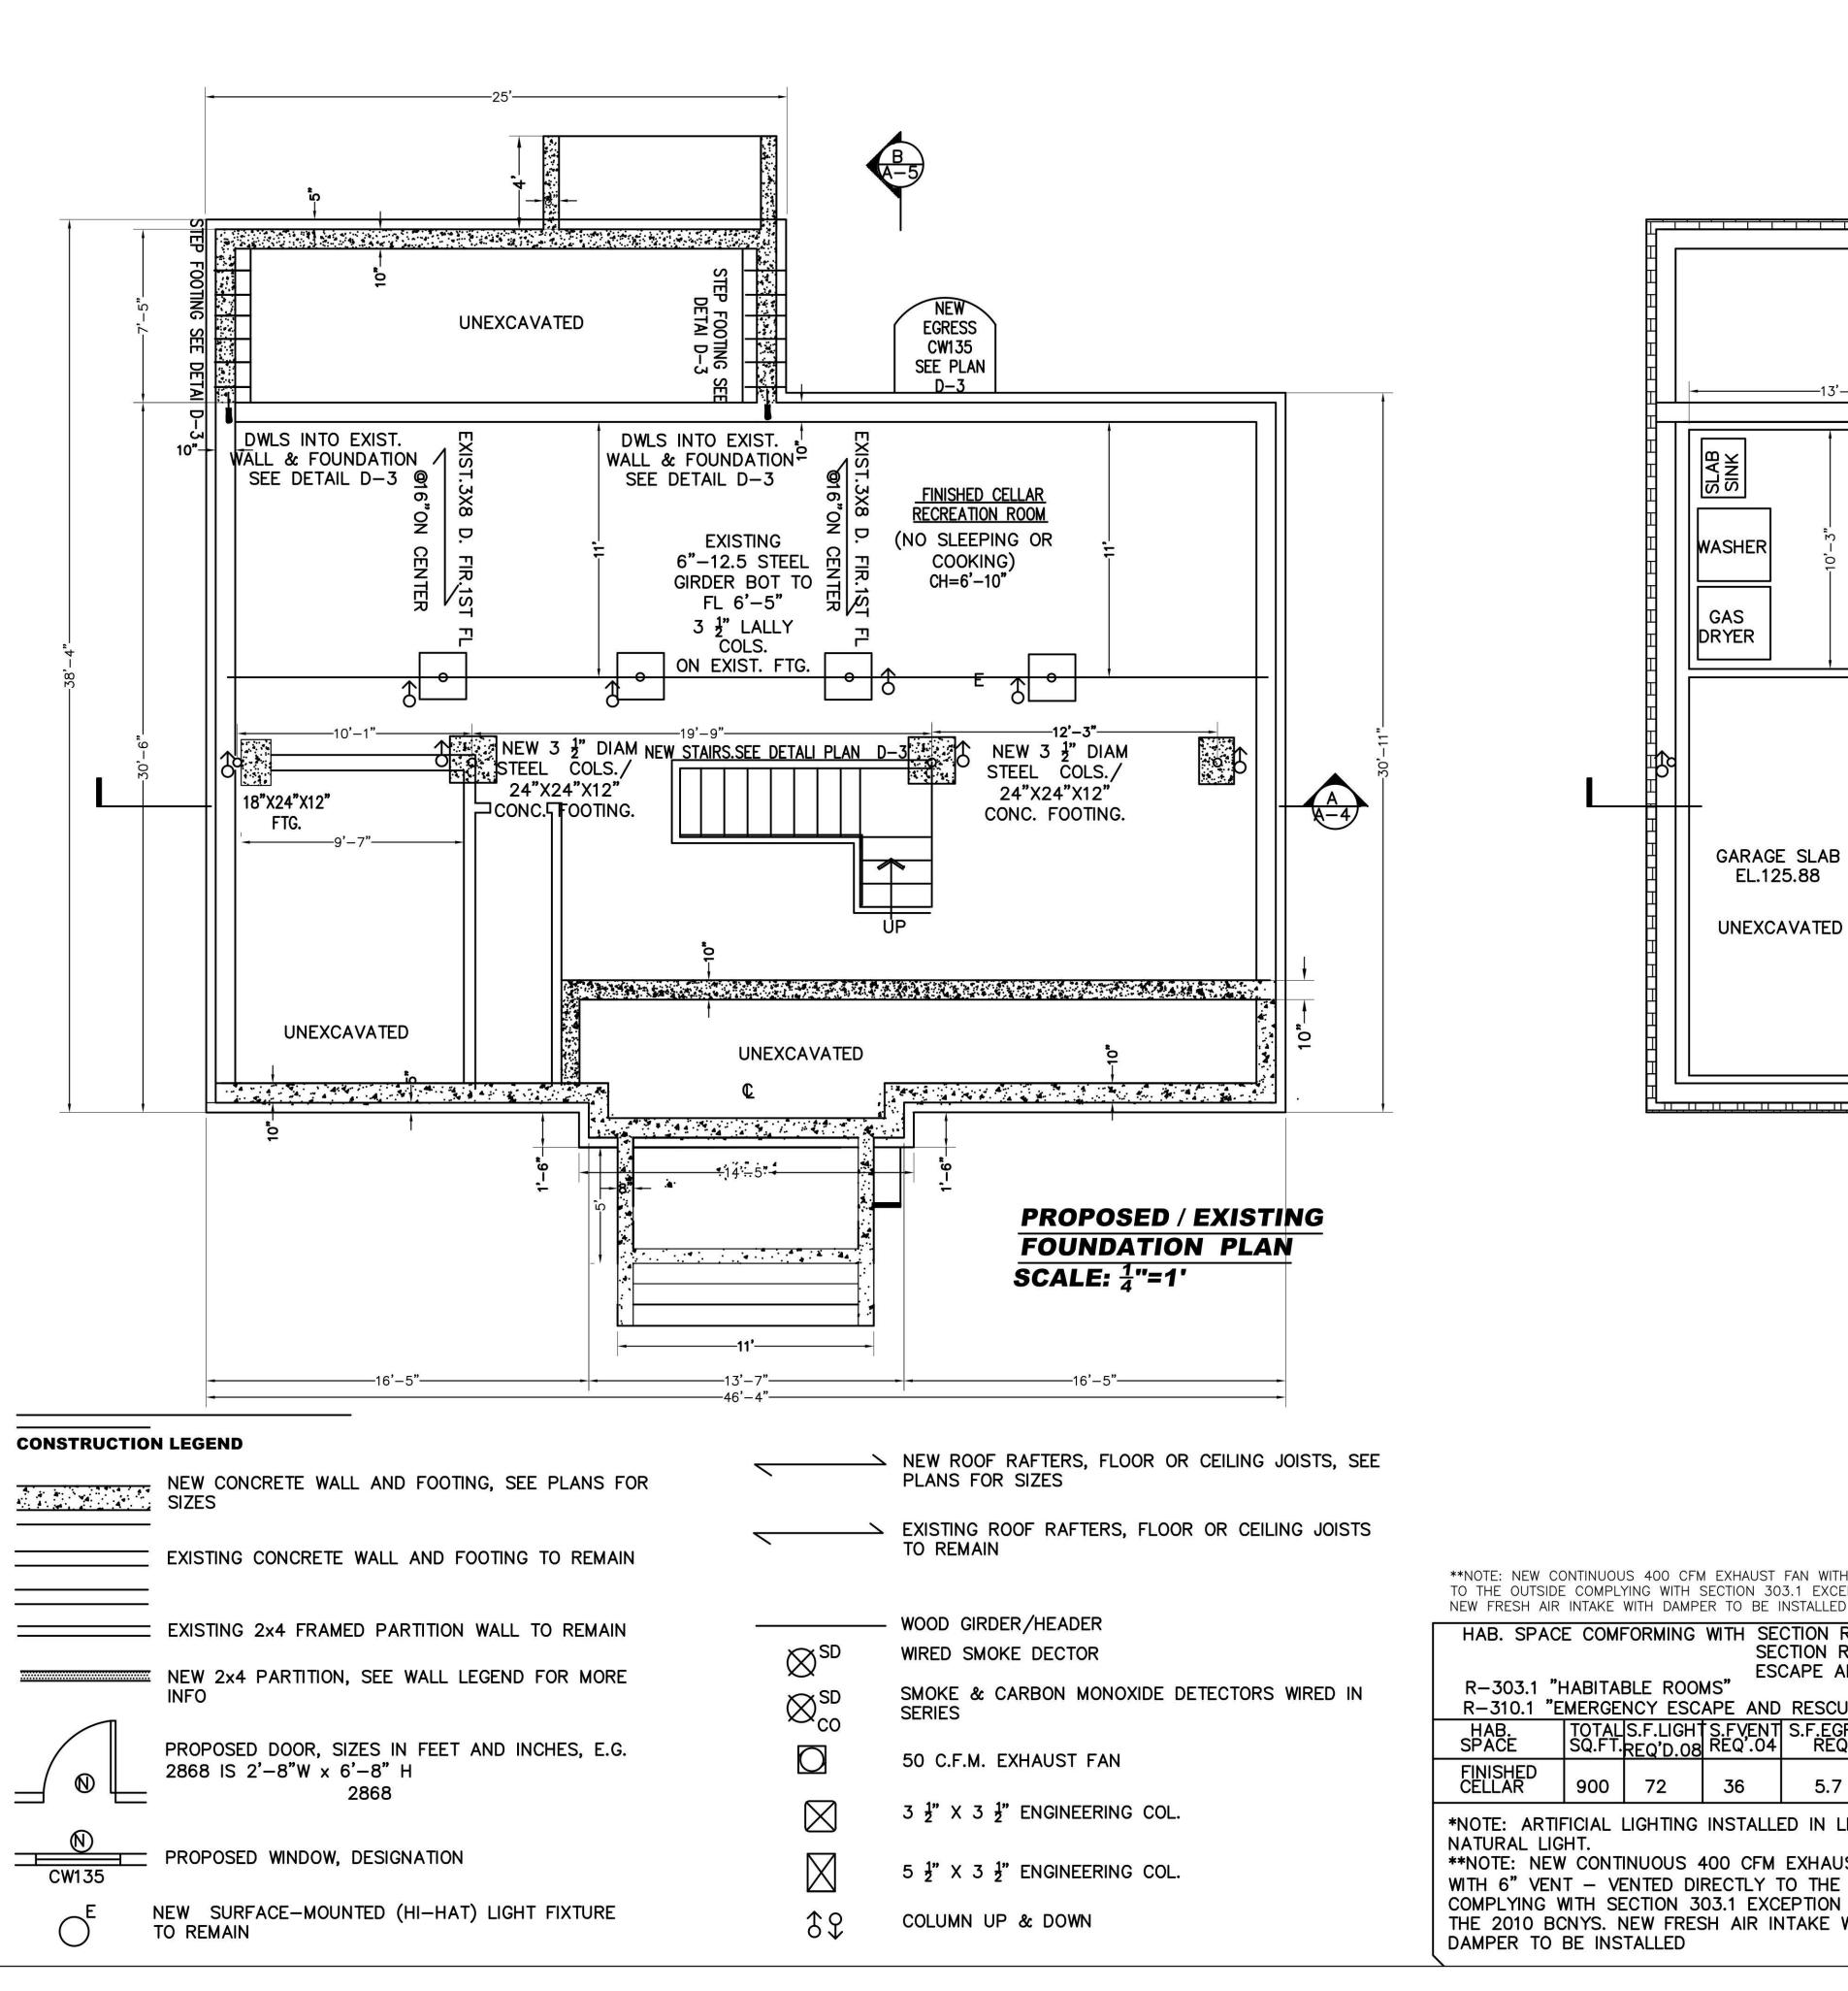

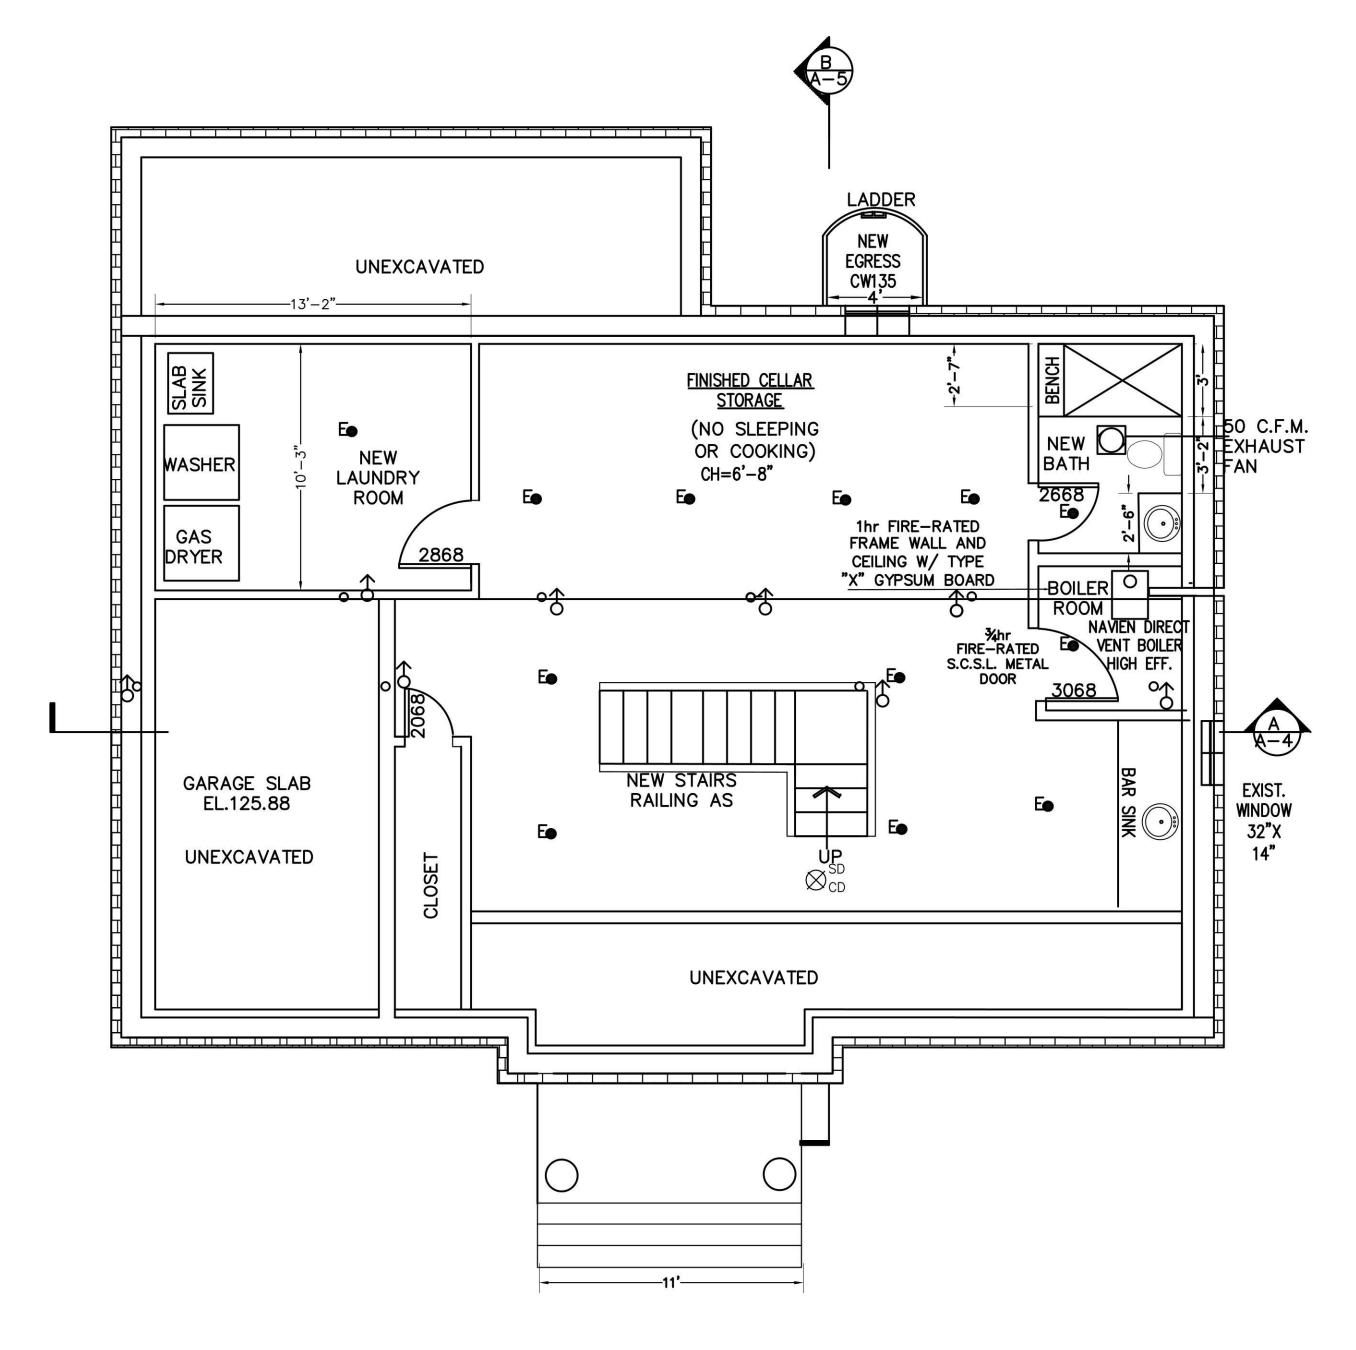

PROPOSED FINISHED CELLAR PLAN SCALE: ¹/₄"=1"

**NOTE: NEW CONTINUOUS 400 CFM EXHAUST FAN WITH 6" VENT - VENTED DIRECTLY TO THE OUTSIDE COMPLYING WITH SECTION 303.1 EXCEPTION 1 OF THE 2010 BCNYS.

HAB. SPAC	E COMF	FORMING	SEC	CTION R-30 CTION R-31 CAPE AND F	O: EMERGEN	ICY	
R-303.1 "HABITABLE ROOMS" R-310.1 "EMERGENCY ESCAPE AND RESCUE OPENINGS REQUIRED"					ſ		
HAB. SPACE	TOTAL SQ.FT.	S.F.LIGH1 REQ'D.08	S.FVENT REQ.04	S.F.EGRESS REQ'D	TOTALLIGHT PROVIDED	TOTALVENT PROVIDED	
FINISHED CELLAR	900	72	36	5.7	9.1 *	7.1**.	
*NOTE: ARTIFICIAL LIGHTING INSTALLED IN LIEU OF						ŀ	

NATURAL LIGHT. **NOTE: NEW CONTINUOUS 400 CFM EXHAUST FAN WITH 6" VENT - VENTED DIRECTLY TO THE OUTSIDE COMPLYING WITH SECTION 303.1 EXCEPTION 1 OF THE 2010 BCNYS. NEW FRESH AIR INTAKE WITH

PROPERTY INFORMATION ADDRESS: 50 BREGMAN AVENUE, NEW HYDE PARK SITE DATA: BUILDING USE: 1 FAM RES. ZONING: R-C TAX MAP No: SECTION: 8 BLOCK: 212 LOT: 110

HELEN BOGDANOS, P.E. 121 NEWBRIDGE ROAD, HICKSVILLE, NY 11801 PHONE 516 933 2626


SCOPE:
PROPOSED FIRST FLOOR REAR ADDITION, INTERIOR ALTERATIONS
12/14/23
AND RENOVATONS ALL FIRST FLOOR, NEWKITCHEN, NEW 1.5
BATH, FINISH BASMT W/NEW BATH, NEW GAS BOILER, CAC, 2ND FL SCALE:
WITH 2 FULL BATHS, 2-DRYWELLS, DETACHED GARAGE, NEW DR/WAY AS NOTED HELEN B

REVISIONS 2/16/24 12/14/24 12/14/23 FIRST FILING DATE DESCRIPTION DRAWN BY: DRAWING NO. CHECKED BY:

DISAPPROVED

Carlos Reyes

05/14/2024

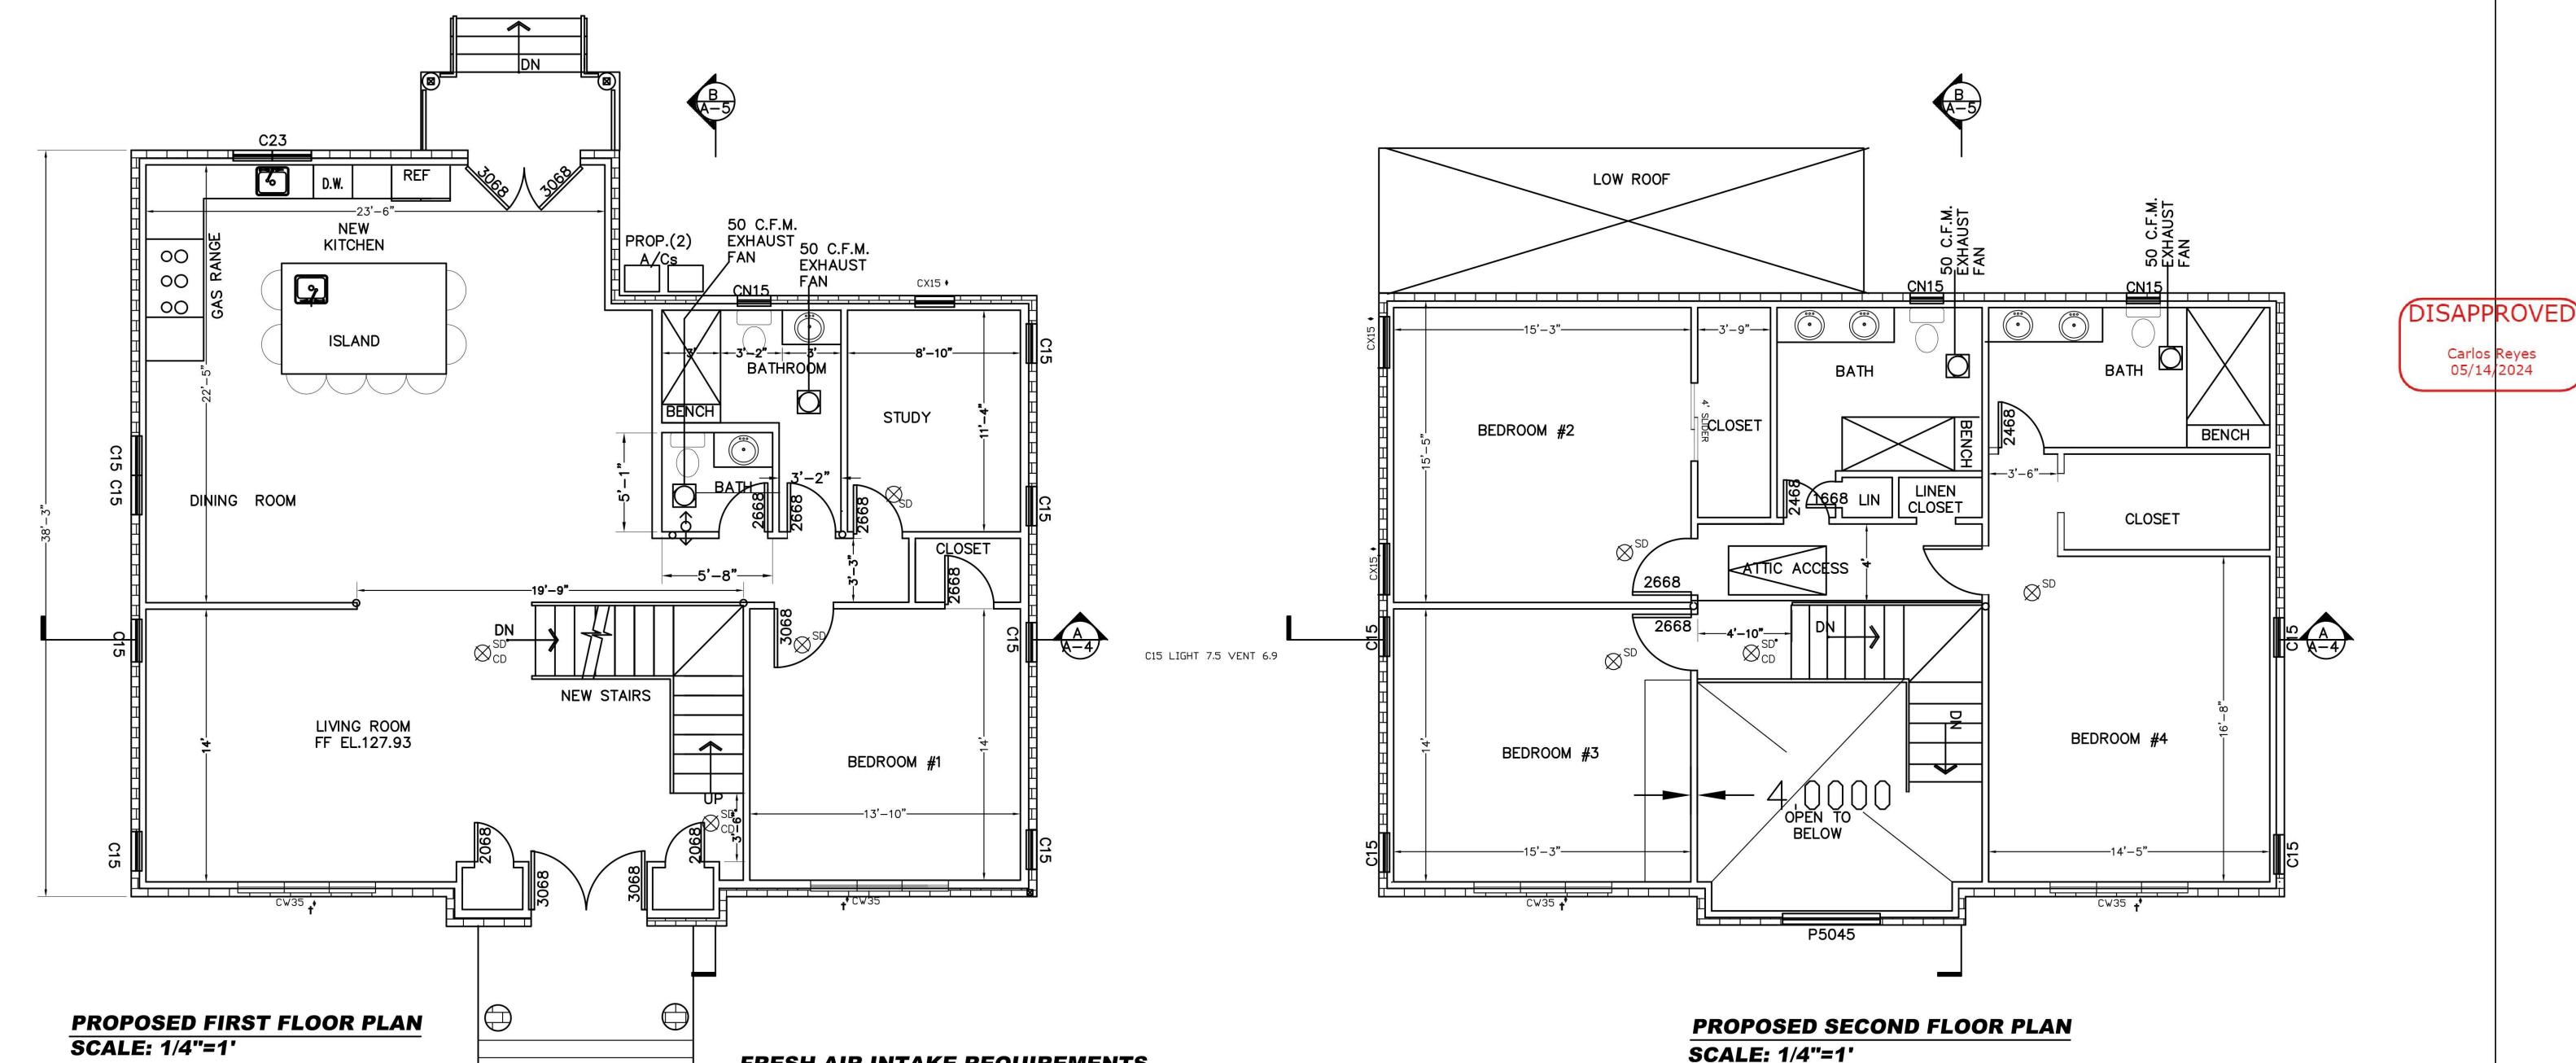

FRESH AIR INTAKE REQUIREMENTS FOR CELLAR MECHANICAL ROOM:

G2407.6.2 (304.6.2) ONE—PERMANENT—OPENING METHOD.
ONE PERMANENT OPENING, COMMENCING WITHIN 12 INCHES
(305 MM) OF THE TOP OF THE ENCLOSURE, SHALL BE
PROVIDED. THE APPLIANCE SHALL HAVE CLEARANCES OF
AT LEAST 1 INCH (25 MM) FROM THE SIDES AND BACK
AND 6 INCHES (152 MM) FROM THE FRONT OF THE
APPLIANCE. THE OPENING SHALL DIRECTLY COMMUNICATE
WITH THE OUTDOORS OR THROUGH A VERTICAL OR
HORIZONTAL DUCT TO THE OUTDOORS, OR SPACES THAT
FREELY COMMUNICATE WITH THE OUTDOORS (SEE FIGURE
G2407.6.2) AND SHALL HAVE A MINIMUM FREE AREA OF 1
SQUARE INCH PER 3.000 BTU/H (734 MM2/KW) OF THE
TOTAL INPUT RATING OF ALL APPLIANCES LOCATED IN THE
ENCLOSURE AND NOT LESS THAN THE SUM OF THE AREAS
OF ALL VENT CONNECTORS IN THE SPACE.

BOILER: WATER HEATER:

175 BTU/H 40,000 BTU

TOTAL BTU/H IN MECHANICAL ROOM: 180,000 BTU/H GROSS AREA OF VENTING REQUIRED: 1 SQ.IN. * 180,000 BTU/H / 3,000 BTU/H = 60 SQ.IN.

ASSUMING 50% ACTUAL VENT DUE TO VENT LOUVERS

NET VENTING REQUIRED: 71.6*2= 144 SQ.IN. PROVIDE VENTS: 12"x12" VENT

ARTIFICIAL LIGHT REQUIREMENTS FOR FINISHED CELLAR:

TOTAL FIN. CELLAR. S.F.= 900s.f.
REQUIRED LIGHT (8%)= 72 s.f.
NATURAL LIGHT = 3s.f. < 72 s.f. - NOT OK

ADDITIONAL MECHANICAL LIGHT PROVIDED:

REQUIRED MECHANICAL LIGHT CALCULATION FOR EXISTING FINISHED CELLAR AS PER SECTION R303 (RCNYS): R303.1(2) REQUIRED 6 FOOT—CANDLES OVER THE AREA OF THE ROOM AT A HEIGHT OF 30" ABOVE THE FLOOR LEVEL


CELLAR AREA = 900 SF.


6 LUMEN/S.F. X 900 S.F. = 5400 TOTAL LUMEN REQUIRED 11x 500 = 5,500 TOTAL LUMENS PROVIDED — OK

REVISIONS PROPERTY INFORMATION ADDRESS: 50 BREGMAN AVENUE, NEW HYDE PARK 2/16/24 12/14/24 SITE DATA: BUILDING USE: 1 FAM RES. ZONING: R-C 12/14/23 FIRST FILING TAX MAP No: SECTION: 8 BLOCK: 212 LOT: 110 **DESCRIPTION** DATE DRAWN BY: HELEN BOGDANOS, P.E. DRAWING NO. 121 NEWBRIDGE ROAD, HICKSVILLE, NY 11801 PHONE CHECKED BY: 516 933 2626 HELEN B PROPOSED FIRST FLOOR REAR ADDITION, INTERIOR ALTERATIONS

AND RENOVATONS ALL FIRST FLOOR, NEWKITCHEN, NEW 1.5

BATH, FINISH BASMT W/NEW BATH, NEW GAS BOILER, CAC, 2ND FL
WITH 2 FULL BATHS, 2-DRYWELLS, DETACHED GARAGE, NEW DR/WAY AS NOTED

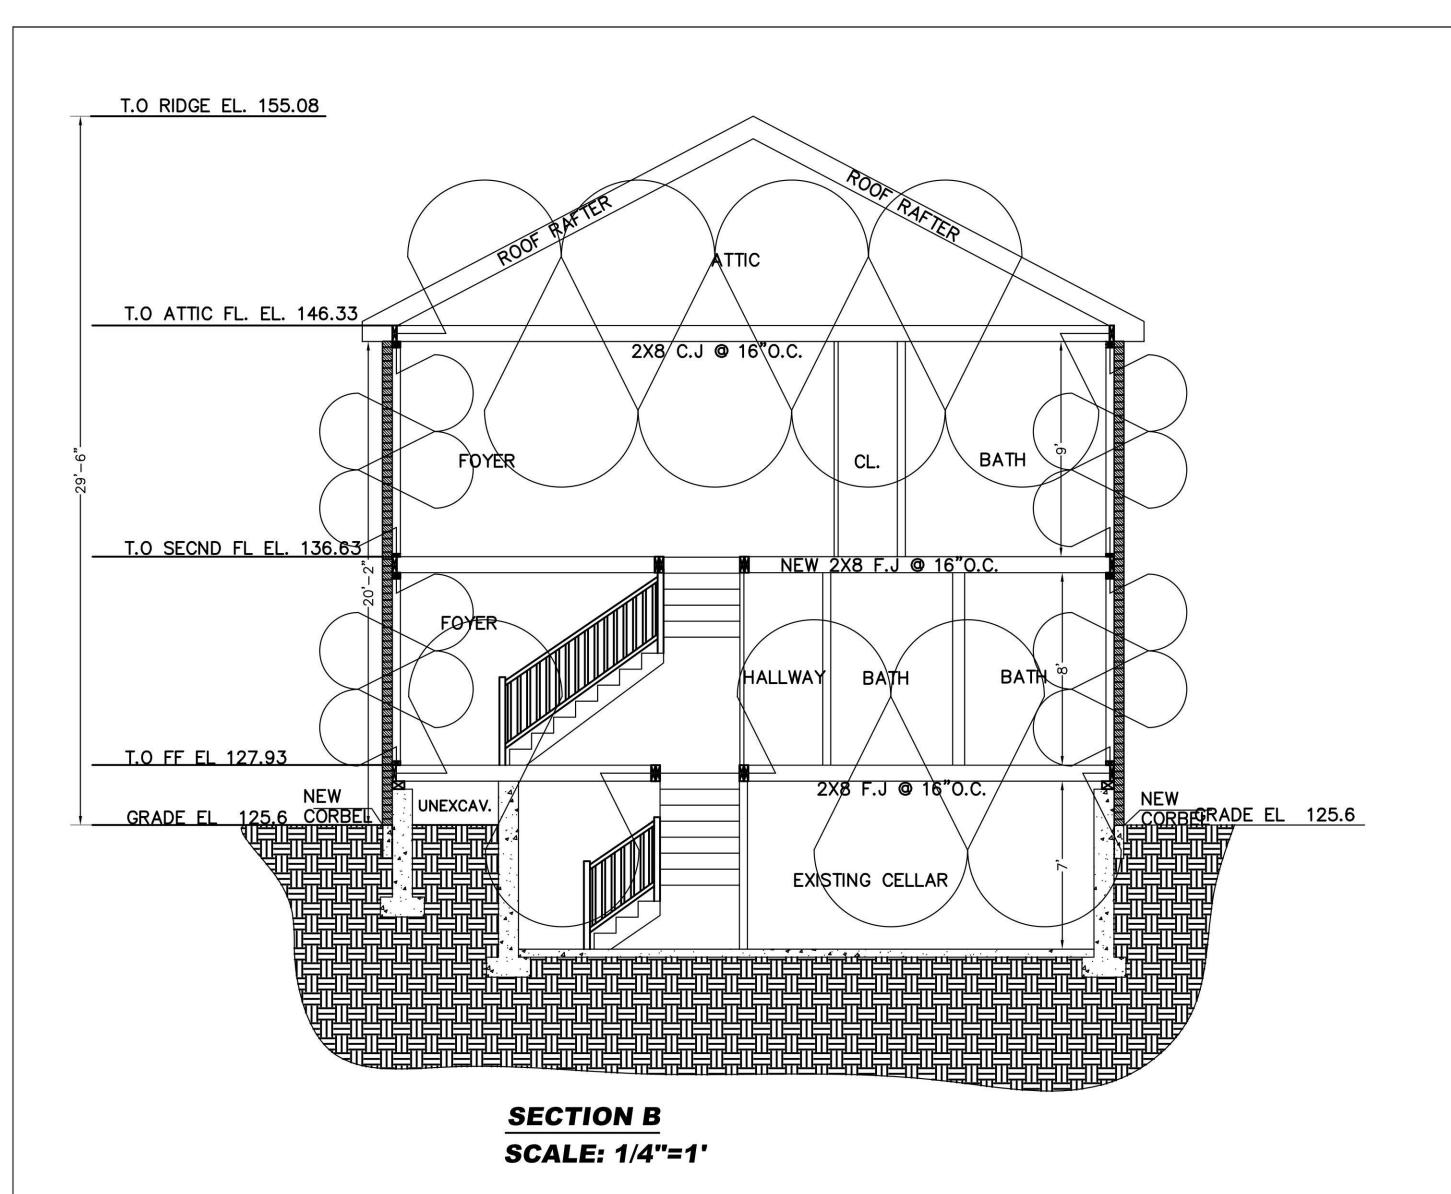

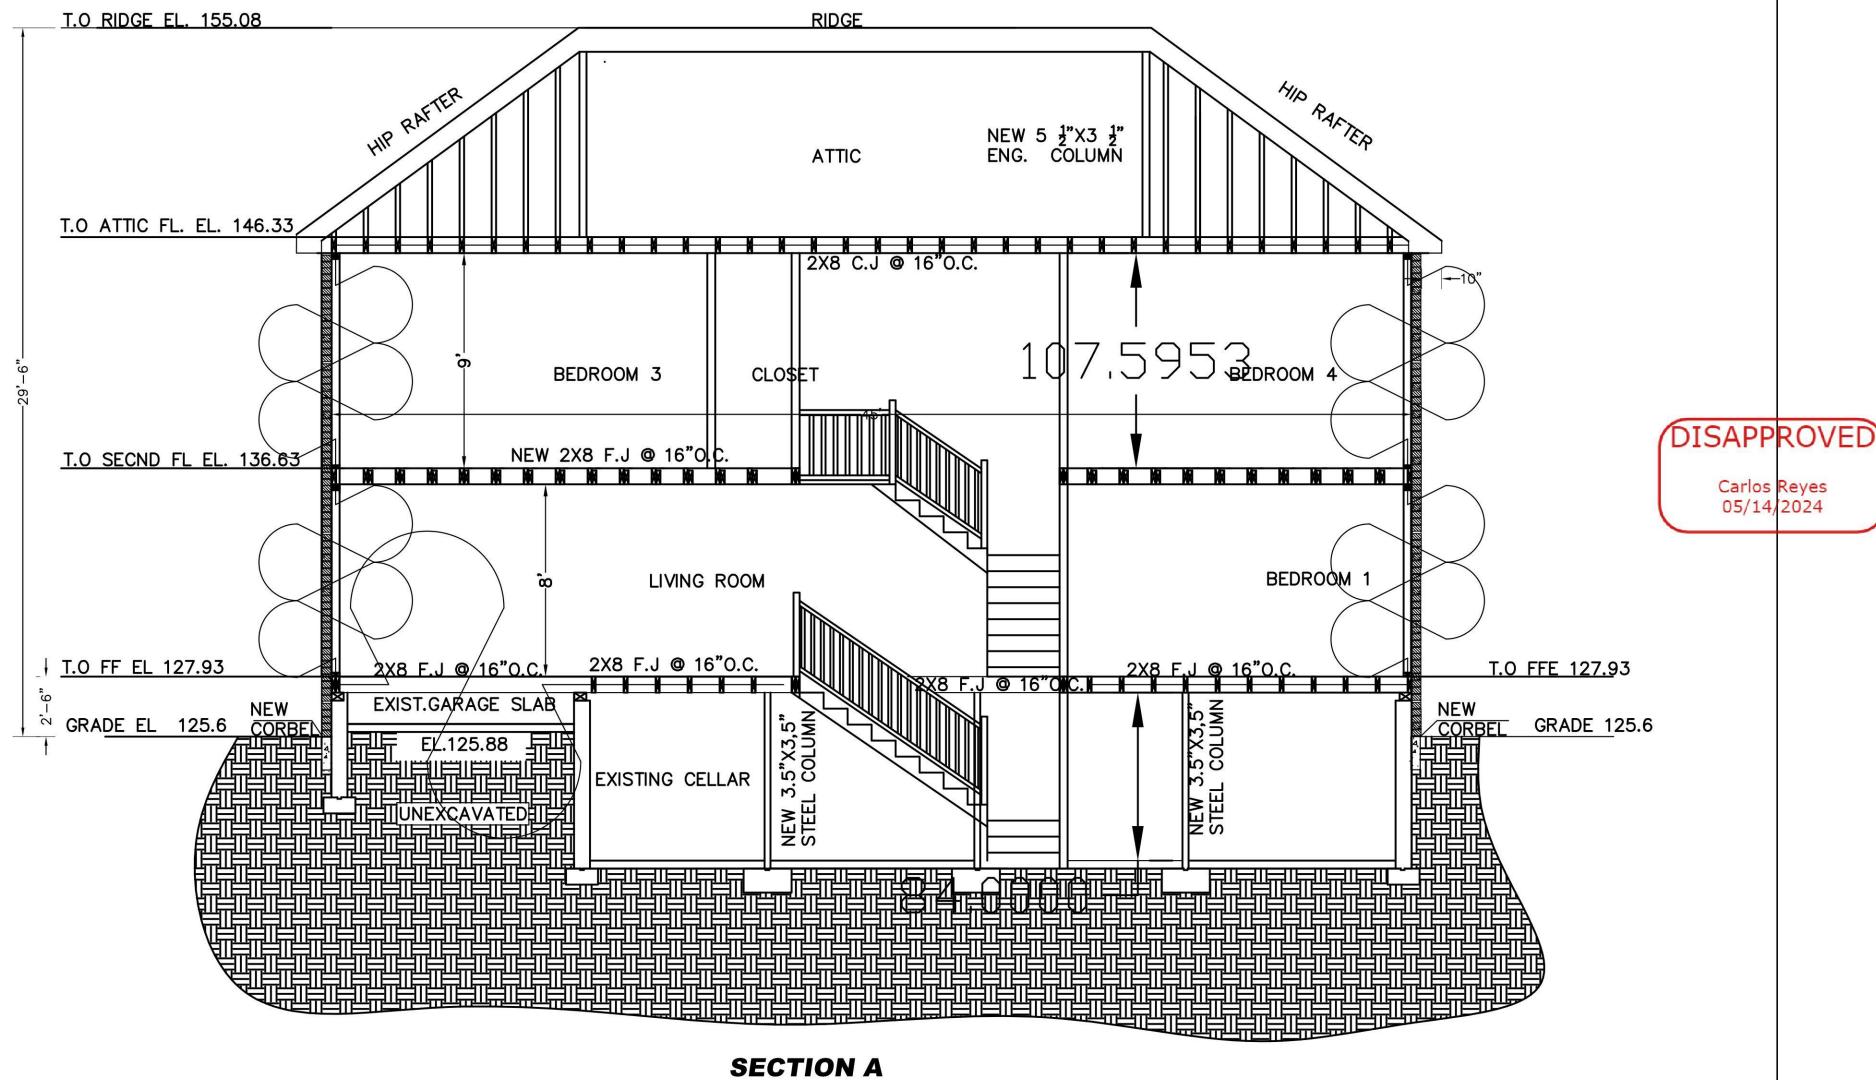

SCALE: 1/4"=1"

LIGHTING & VENTING CALCS.

HAB. SPACE COMFORMING WITH PART: 712 SECTION: 712.1 " LIGHT & VENTILATION USE " PART: 714 SECTION: 714.1 " OPENING FOR EMERGENCY USE " TOTAL S.FLIGHT S.FVENTS.F.EGRESS TOTAL LIGHT TOTALVENT SQ. FT. '.08 REQ'D.04REQ'D REQ'D PROVIDED PROVIDED FIRST FLOOR BEDROOM#1 192 SF 15.4 SF 7.7 SF 5.0 SF 42.6 SF 30.5 SF SECOND FLOOR 5.7 SF BEDROOM#2 230 SF 18.4 SF 9.2SF 48.4 SF 36.1 SF BEDROOM#3 226 SF 18.0 SF 9.0 SF 5.7 SF 48.4 SF 36.4 SF BEDROOM#4 238 SF 19.0 SF 9.5 SF 5.7 SF 36.4 SF 48.4 SF

*AGG. 3.0 S.F. GLAZING IN BATHROOMS, WATER CLOSETS, AND SIMILAR COMPARTMENTS AND HALF OF THAT (1.5 S.F. VENT) HAS TO BE OPENABLE AS PER R303.3 (IRC 2015).

**EXCEPTION: GLAZING SHALL NOT BE REQUIRED IN BATHROOMS WHERE SUFFICIENT ARTIFICIAL LIGHT AND MECHANICAL VENTILATION ARE PROVIDED

PROPERTY INFORMATION

ADDRESS: 50 BREGMAN AVENUE, NEW HYDE PARK

SITE DATA:BUILDING USE: 1 FAM RES. ZONING: R—C

TAX MAP No: SECTION: 8 BLOCK: 212 LOT: 110

HELEN BOGDANOS, P.E.

121 NEWBRIDGE ROAD, HICKSVILLE, NY 11801 PHONE
516 933 2626

2/16/24 12/14/24

AS PER COMMENTS
12/18/23 ON 12/15/23
12/14/23 FIRST FILING
DATE DESCRIPTION
DRAWN BY: DRAWIN
I.T
CHECKED BY:


SCOPE:
PROPOSED FIRST FLOOR REAR ADDITION, INTERIOR ALTERATIONS DATE:
AND RENOVATONS ALL FIRST FLOOR, NEWKITCHEN, NEW 1.5
BATH, FINISH BASMT W/NEW BATH, NEW GAS BOILER, CAC, 2ND FL
WITH 2 FULL BATHS, 2-DRYWELLS, DETACHED GARAGE, NEW DR/WAY
AS NOTED


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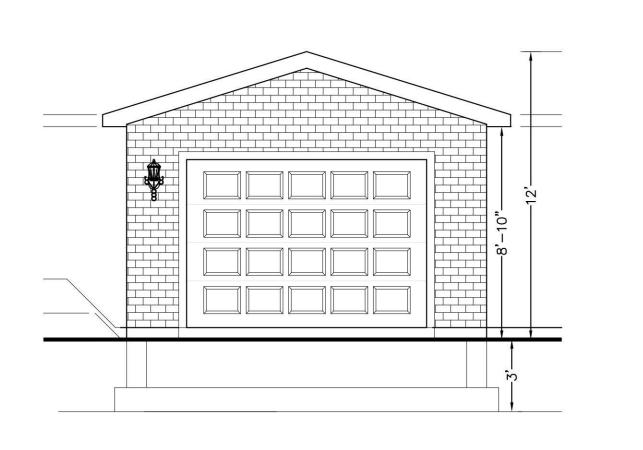
CKED BY:
HELEN B

12/14/23

REVISIONS




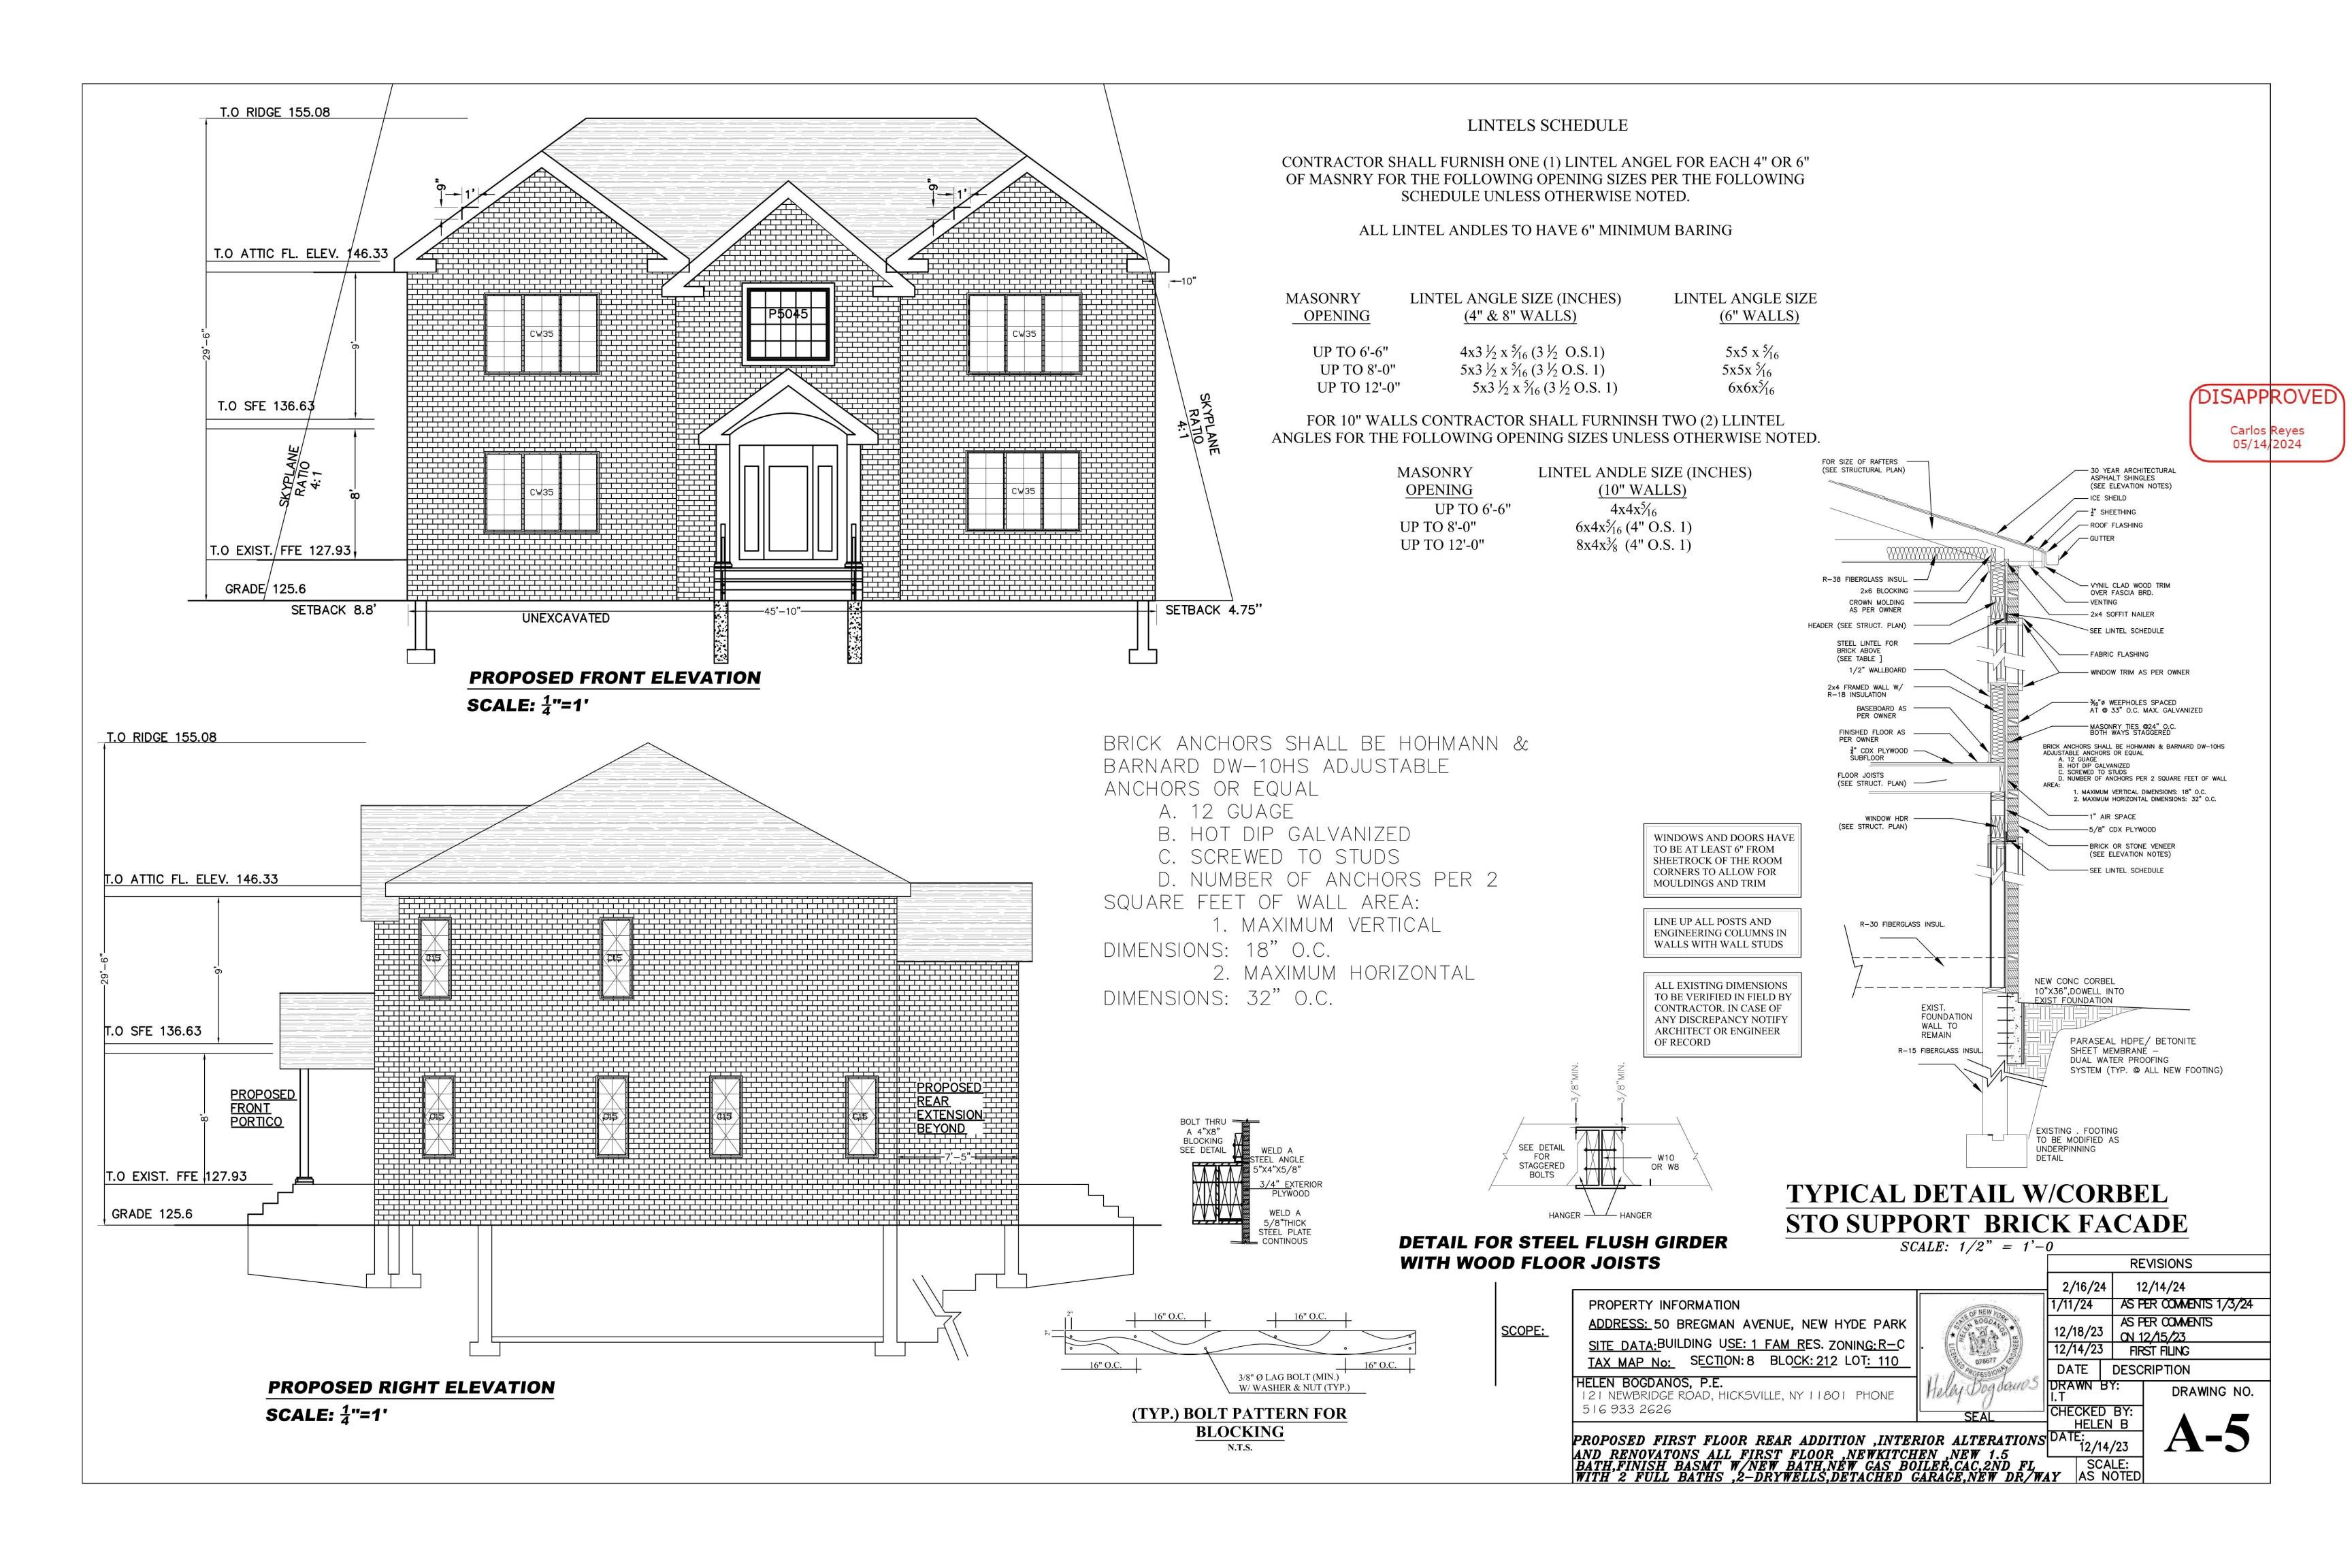

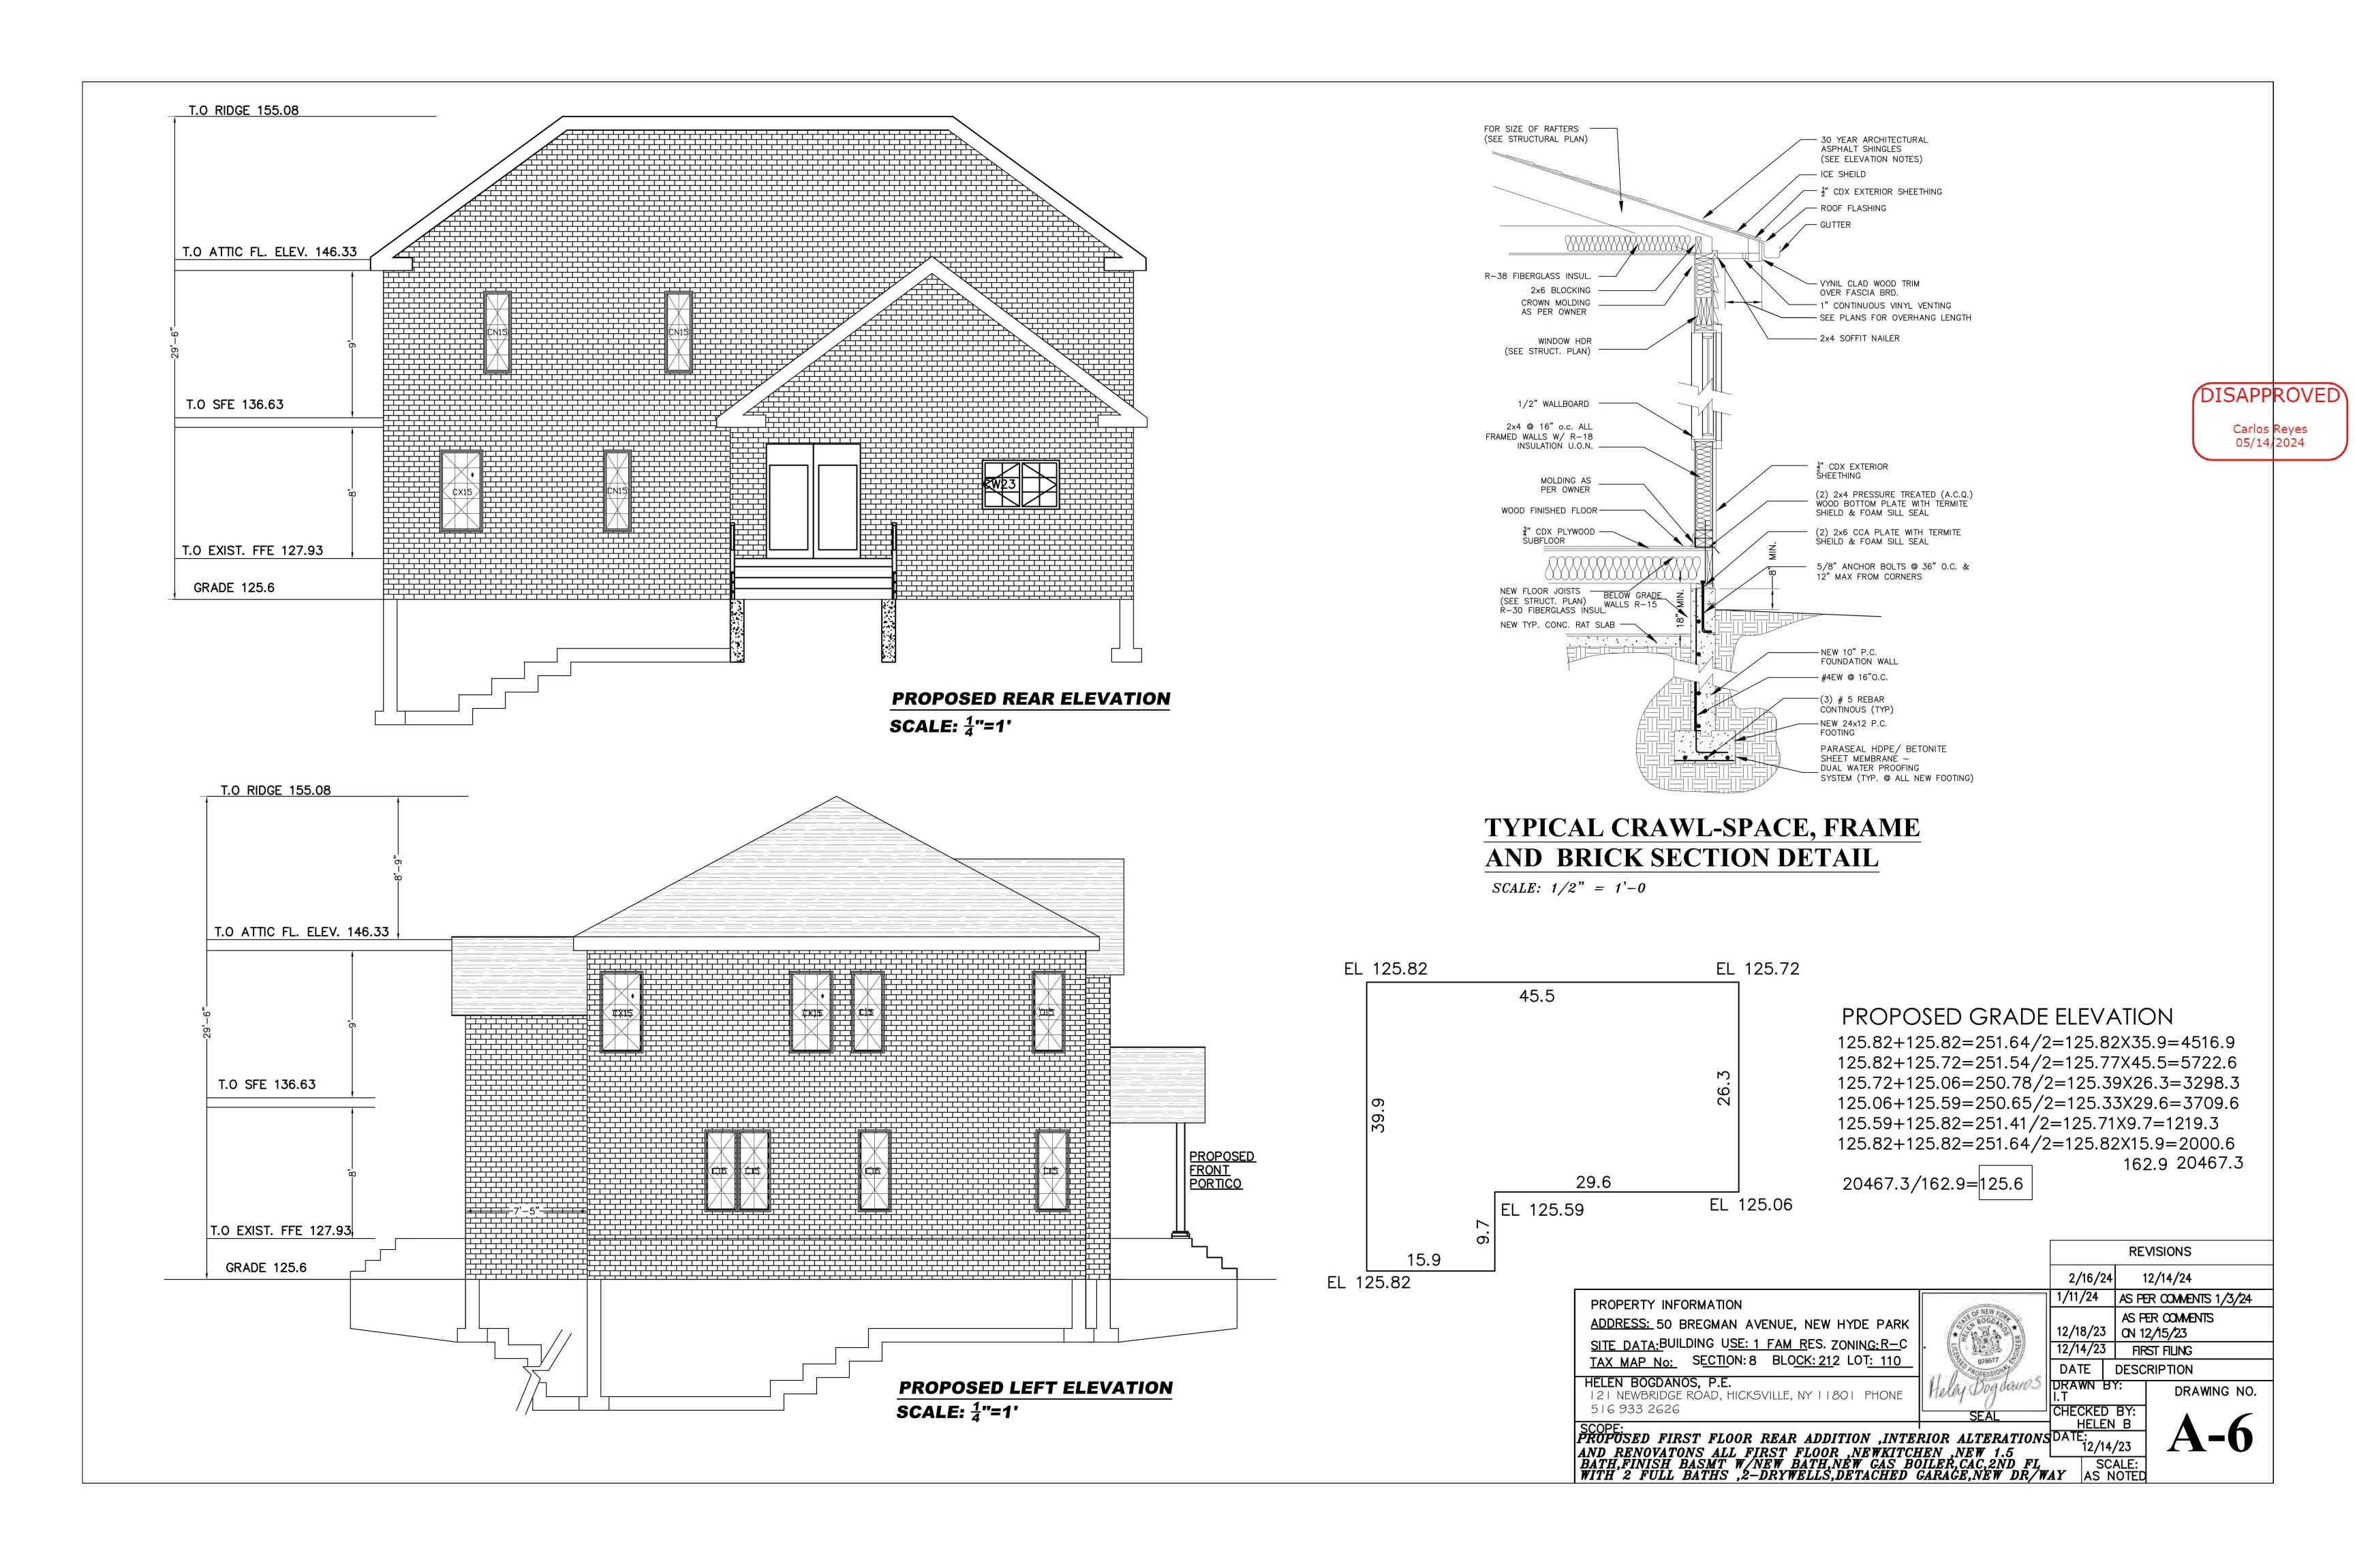


FRONT ELEVATION

SCALE: 1/4" = 1'-0

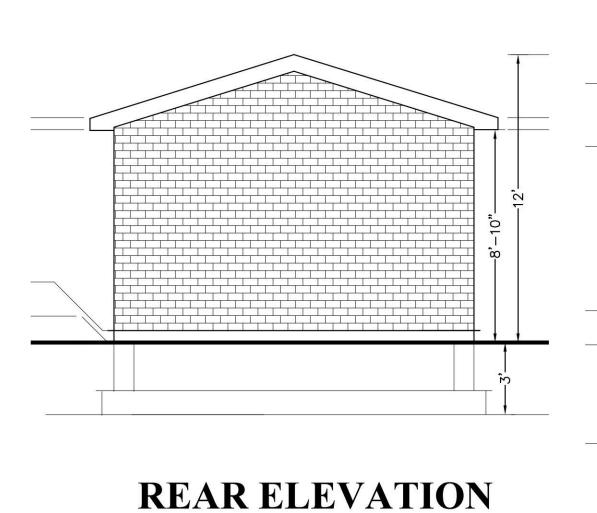



SCALE: 1/4" = 1'-0

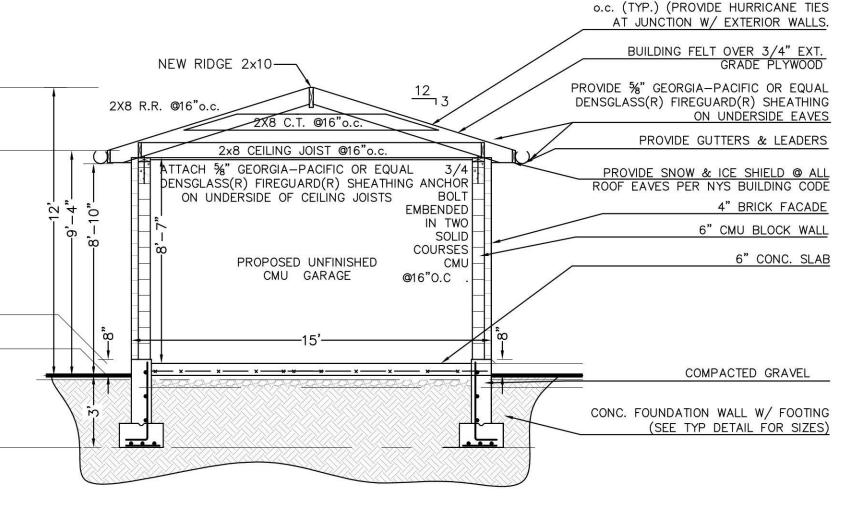


ASPHALT SHINGLES 1/2" CDX PLWD. SHEATHING, AND ROOF RAFTERS @ 16"

SECTION C $\overline{SCALE: 1/4" = 1'-0}$

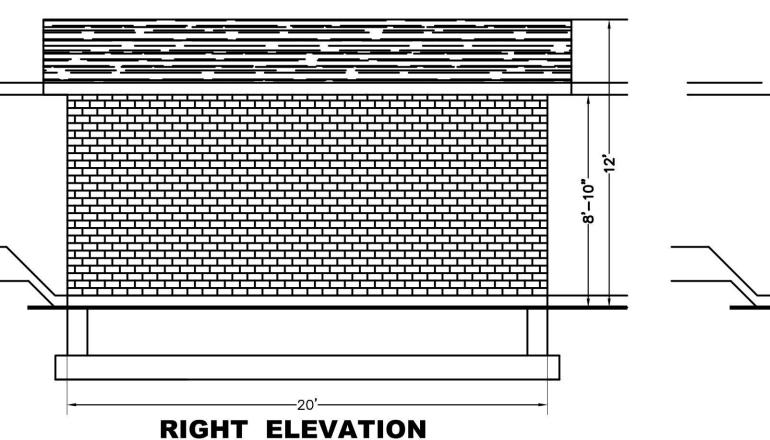


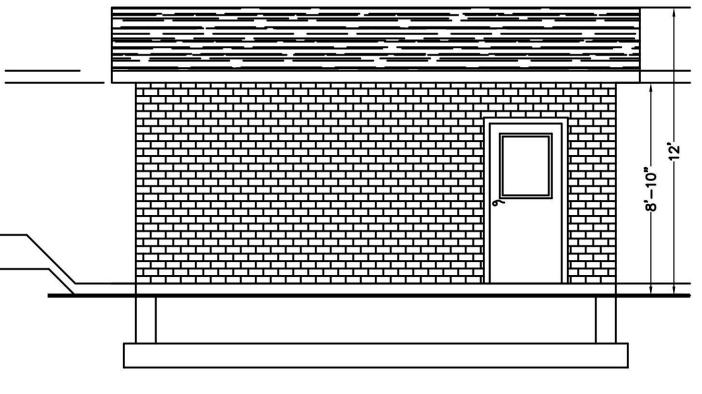


LEFT ELEVATION SCALE: 1/4" = 1'-0

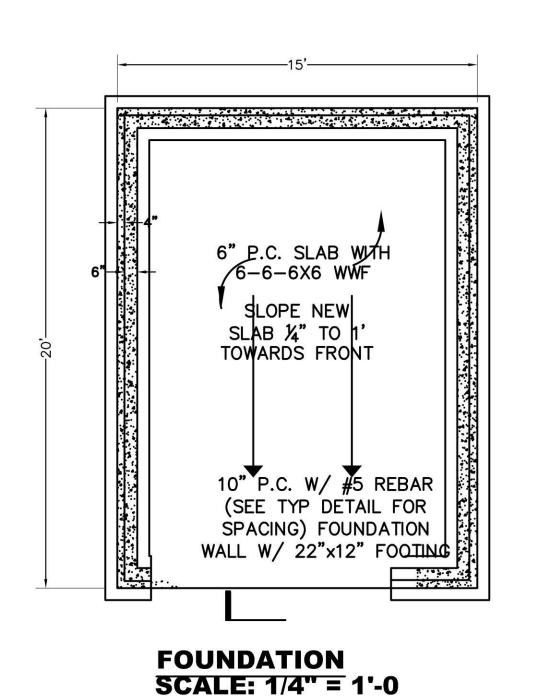

SCALE: 1/4" = 1'-0

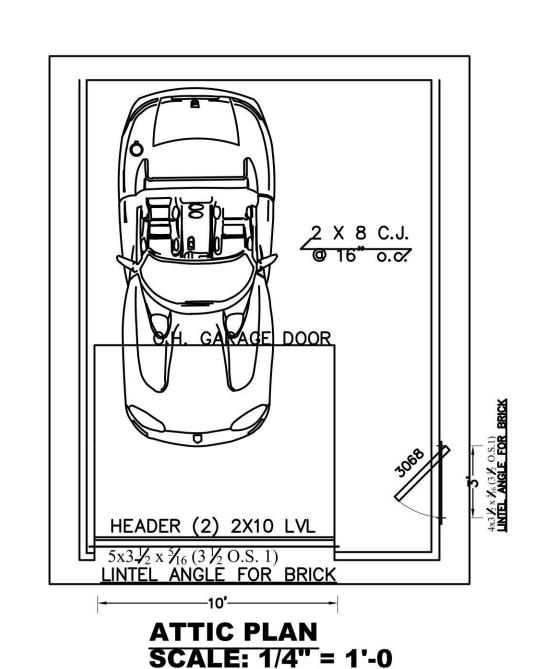

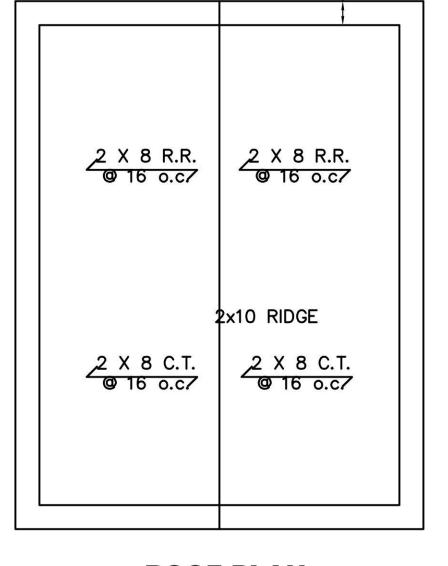

ROOF PLAN SCALE: 1/4" = 1'-0

** ALL STRAPPING TO BE 1 1/4" X 20 GAUGE STL. ** "SIMPSON "EQUIVALENT - CS20 (COILED STRAP)

AT RAFTER TO RIDGE CONNECTION.

FOR STRAP - 3 8d COMMON NAILS @ EA. END OF STRAP FOR NOTED COLLAR / CLG. TIE - 3 10d COMMON NAILS @ EA.

AT RAFTER TO TOP PLATE TO STUD CONNECTION.

FOR STRAP - 3 8d COMMON NAILS @ EA. END OF STRAP FOR TOENAILING - 5 8d COMMON NAILS.

FOR C.J. TO R.R. - 11 16d COMMON NAILS (FOR 5 PITCH) 9 16d COMMON NAILS (FOR 8 PITCH)


FOR C OF EA. PLATE TO PLATFORM ABOVE - 1 16d COMMON NAILS @ 48" O.C.

ROOF FRAMING Rafter to Top Plate (Toe-nailed) Ceiling Joist to Top Plate (Toe-nailed) Cenailed) ROOF FRAMING 3- 8d per rafter 3- 8d per joist 3- 16d each lap 3- 16d each lap		
ROOF FRAMING Rafter to Top Plate (Toe-nailed) Ceiling Joist to Top Plate (Toe-nailed) Toe-nailed) ROOF FRAMING 3- 8d per rafter 3- 8d per joist 3- 16d each lap 3- 16d each lap	TABLE 3.1 (NAILI	NG SCHDULE)
Rafter to Top Plate (Toe-nailed) Ceiling Joist to Top Plate (Toe-nailed) 3- 8d per rafter 3- 8d per joist 3- 16d each lap 3- 16d each lap	JOINT DESCRIPTION	# OF NANLSIL SPACIN
(Toe-nailed) Ceiling Joist to Top Plate (Toe-nailed) 3- 8d per joist 3- 16d each lap 3- 16d each lap	ROOF FRAMI	ING
Ceiling Joist to Top Plate (Toe-nailed) 3- 16d each lap 3- 16d each lap		
(Toe-nailed) 3- 16d each lap	Toe-nailed)	3- 8d per joist
(Toe-nailed) 3- 16d each lap	Ceiling Joist to Top Plate	3- 16d each Iap
		3- 16d each lap
looming color to raiding	Ceiling Joist to Parallel	3- 10d per tie
Rafter (Face-nailed) OF SHEATHING a each end	Rafter (Face—naile€)OF SHEA	THING Ba each end
Ceiling Joist Lans over	Ceiling Joist Laps over	Z roquadii dila
Structural Panels nailed) Bartitions (Face snailed) Liagonal Board Sheathing Collar tie to Railer or or 2 8d per support	artitions (Face - nailed)	1.2 5.5.
I/Eggs nailed) I XO or 2 Od per Suppor	Eggs nailed) I XO Of	2- 8d per support
	3188king to RafterCEILING SHE	l 3 - 8d lper support ATHING
Georgia Pacific or Equal 5d 7" edge /10	Toe-nailed) in a Fauct	
	Region Fuel III Control	/ Ougo/10
Denseglass to Rafter coolers field (End-nailed)	Jensegiass End-nailed)	coolers field
(Line indired)	Lita Halloa)	


OTHERWISE STATED B. NAILS SPACED AT 6" OC AT EDGES, 12" AT INTERMEDIATE SUPPORTS EXCEPT 6" AT SUPPORTS WHERE SPANS ARE 48" OR MORE. FOR NAILING OF WOOD STRUCTURAL PANEL AND PARTICLE BOARD DIAGRAMS AND SHEAR WALLS, REFER TO SECTION 2305. NAILS FOR WALL SHEATHING ARE PERMITTED TO BE COMMON, BOX OR CASING. C. COMMON OR DEFORMED SHANK. D. COMMON. E. DEFORMED SHANK. F. CORROSION RESISTANT SIDING OR CASING NAILS. G. FASTENERS SPACED 3" OC AT EXTERIOR EDGES AND 6" OC AT INTERMEDIATE SUPPORT. H. CORROSION RESISTANTICO POPED NAILS WITH $\frac{7}{16}$ " DIA HEAD AND $1\frac{1}{2}$ " LENGTH FOR $\frac{1}{2}$ " SHEATHING AND $1\frac{3}{4}$ " LENGTH FOR 32 SHEATHING. Carlos Reyes I. CORROSION RESISTANT STATE/14/2024 WITH NOMINAL $\frac{7}{16}$ " CROWN AND 1 $\frac{1}{8}$ " LENGTH FOR $\frac{1}{2}$ " SHEATHING AND $1\frac{1}{2}$ " LENGTH FOR $\frac{25}{32}$ " SHEATHING. PANEL SUPPORTS AT 16" (20" OF STRENGTH AXIS IN THE LONG DIRECTION OF THE PANEL UNLESS OTHERWISE MARKED) R.90 A STANGA STRENIERSH NAILS SPACED 6" ON PANEL EDGES, 12" AT FNSERMERS AFOR SUSPPORT. SHINGLES SCHARANBIE SCHAPPOARNISZAID SATEETA, SING OR STAISHLES SISSISPACED 6" ON PANEL ADGMSNL2WAORNCORPHIRIAOEING SUPPEORATION. 12 GAGE SHANK W/ A MIN. #! FICE BOOF SHEATHING APPLICATIONS, ALS TWANT LOGA, ROPETANE INVIOLENT REPORT FOR PREDICTOR ATTRICTURE OF ATTRIC MASTERPAES SANADLL HAVE MIN. CROWN AVMOTHOR 31/4 INTO THE ROOF SHEARHOOF WHEREHING ROOF SAPPEATICHANIONSSI, ESISTEMBR²⁵ SPACED 4" CHICAR. HIDIEHSA STANTHNS BRIMEDIATE **BENEORAS**E THROUGH THE SHEASTHENGERS SP. 20CTESP4TAUCTAT EDGES ROOF SHINGTERS WHO LAIT HE SUMP OF MISSIFOR OF BEX O'ARTAINDERS APER SHIENGHENG AND 3" OC AT EDGES, 6" AT INTERMEDIATE SUPPORTS FOR ROOF SHEATHING. P. FASTENERS SPACED 4" OC AT EDGES,


A. COMMON OR BOX NAILS ARE

PERMITTED TO BE USED EXCEPT WHERE

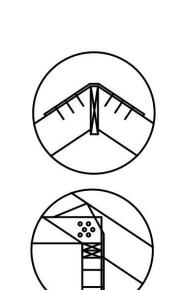

516 933 2626

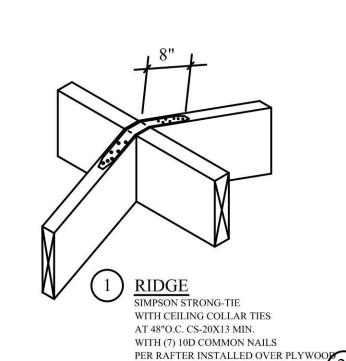

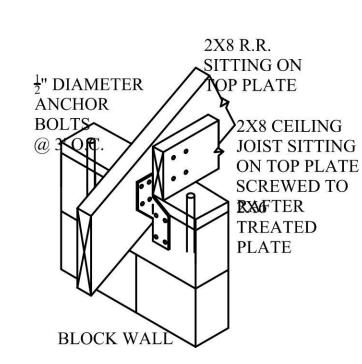

8" AT INTERMEDIATE.

HURRICANE CLIP

PROPERTY INFORMATION ADDRESS: 50 BREGMAN AVENUE, NEW HYDE PARK SITE DATA: BUILDING USE: 1 FAM RES. ZONING: R-C TAX MAP No: SECTION: 8 BLOCK: 212 LOT: 110 HELEN BOGDANOS, P.E.

121 NEWBRIDGE ROAD, HICKSVILLE, NY 11801 PHONE

	S. Contraction of the Contractio	175	6-0			
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20 00			AS PER COMMENTS ON 12/15/23			
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REVISIONS


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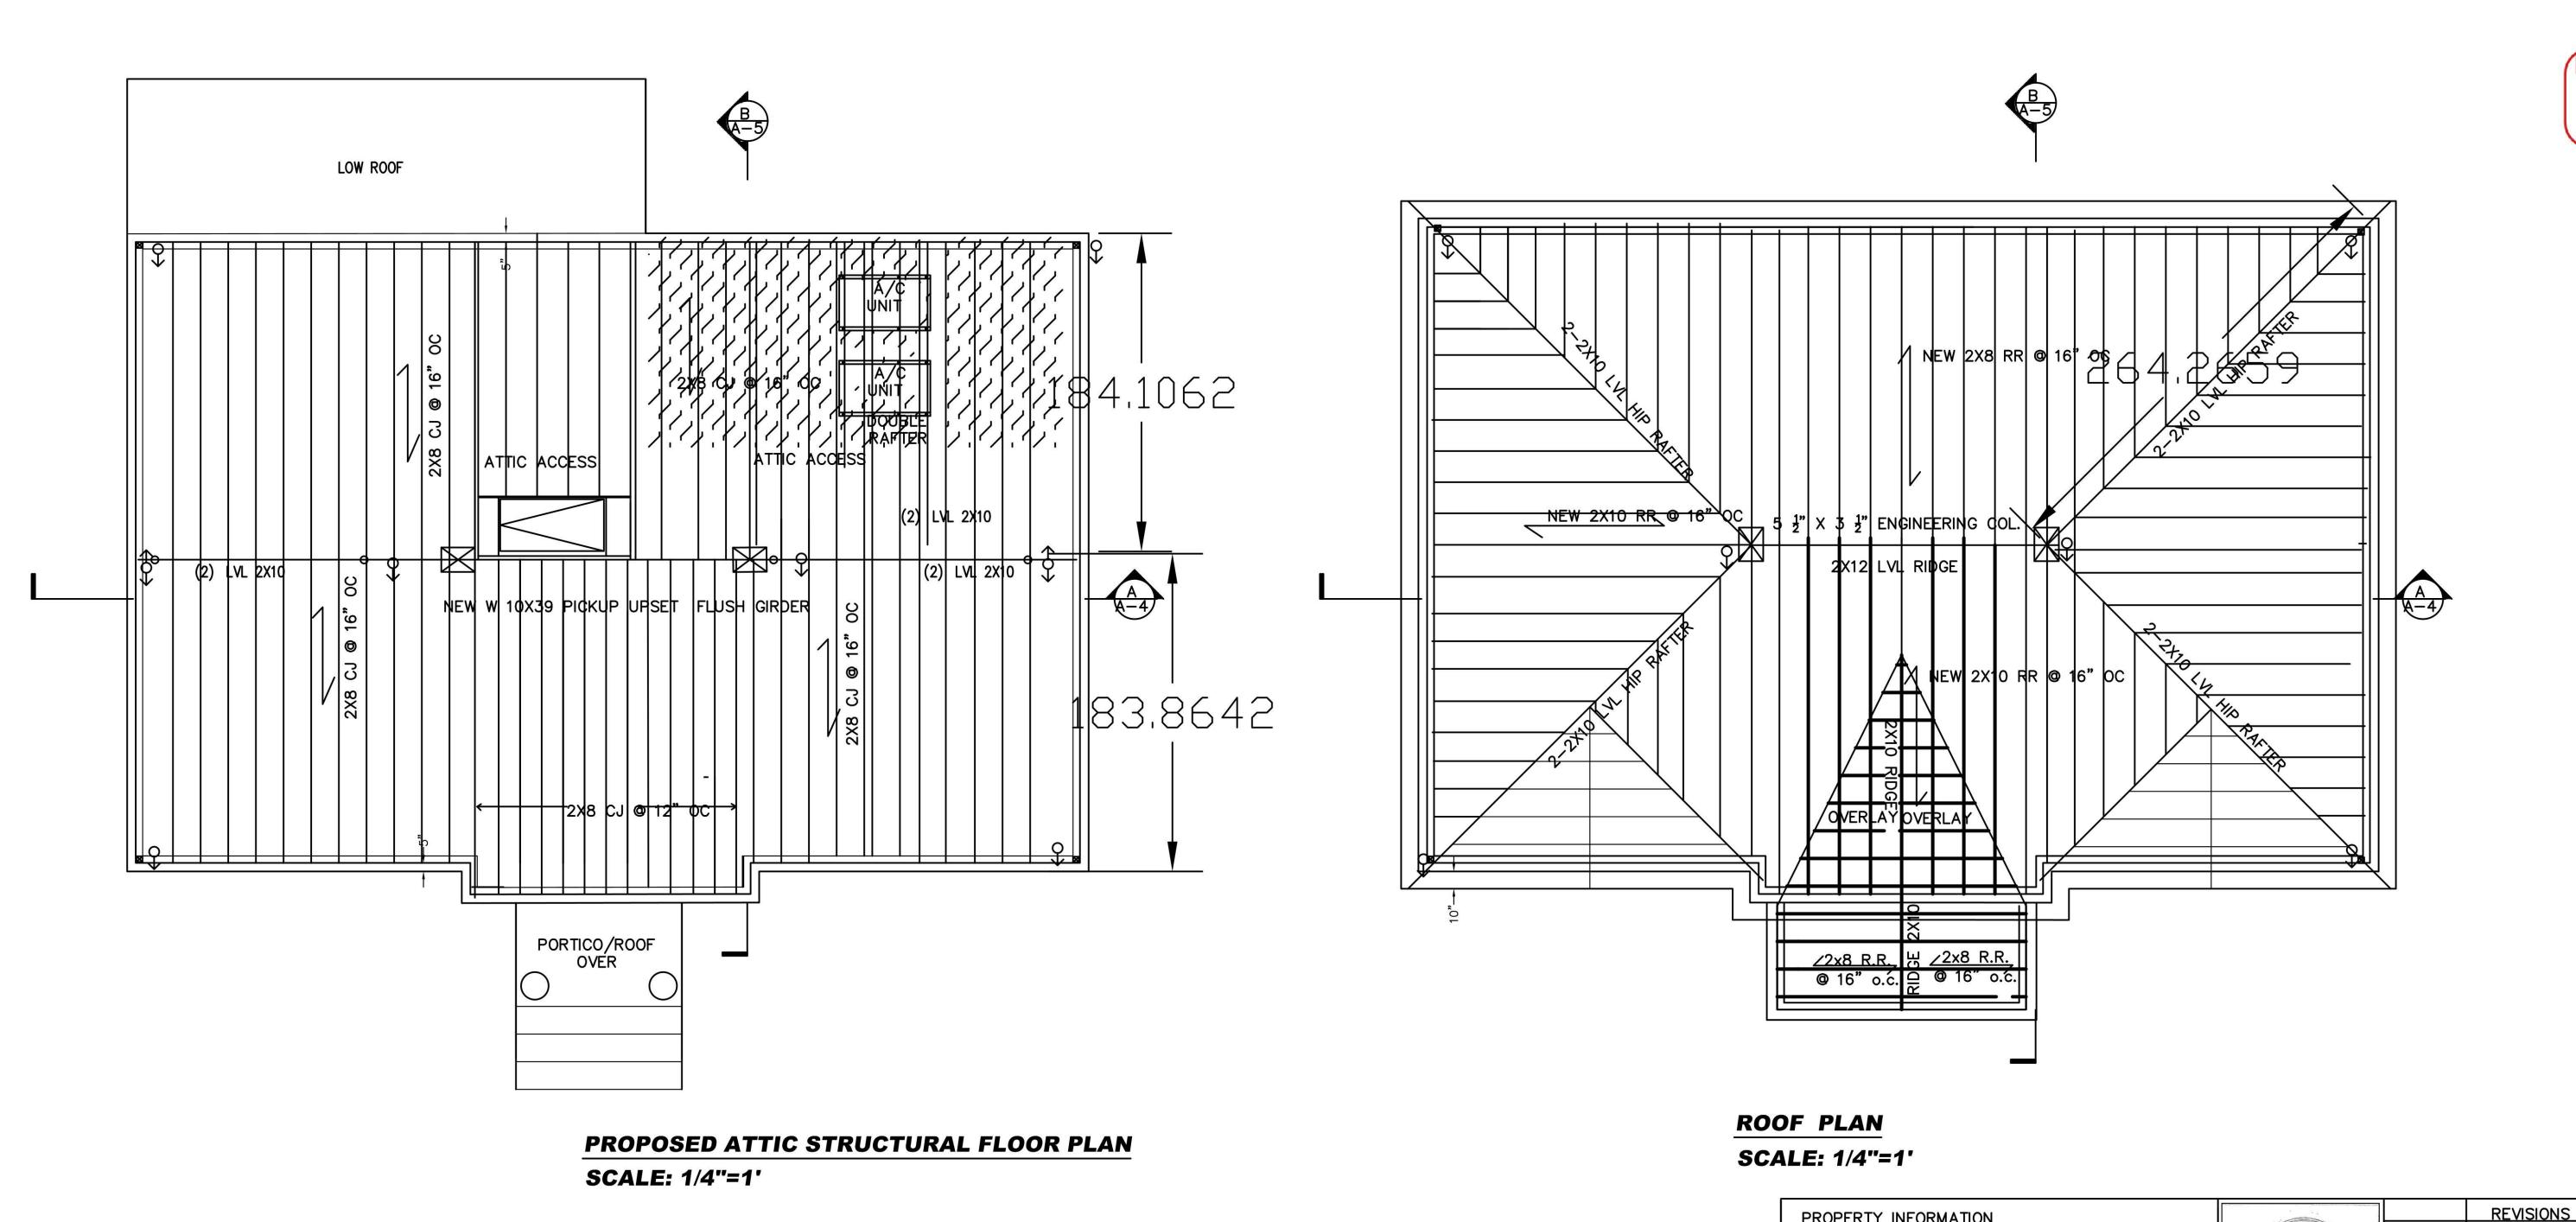
PROPOSED FIRST FLOOR REAR ADDITION, INTERIOR ALTERATIONS

AND RENOVATONS ALL FIRST FLOOR, NEWKITCHEN, NEW 1.5

BATH, FINISH BASMT W/NEW BATH, NEW GAS BOILER, CAC, 2ND FL
WITH 2 FULL BATHS, 2-DRYWELLS, DETACHED GARAGE, NEW DR/WAY

AS NOTED



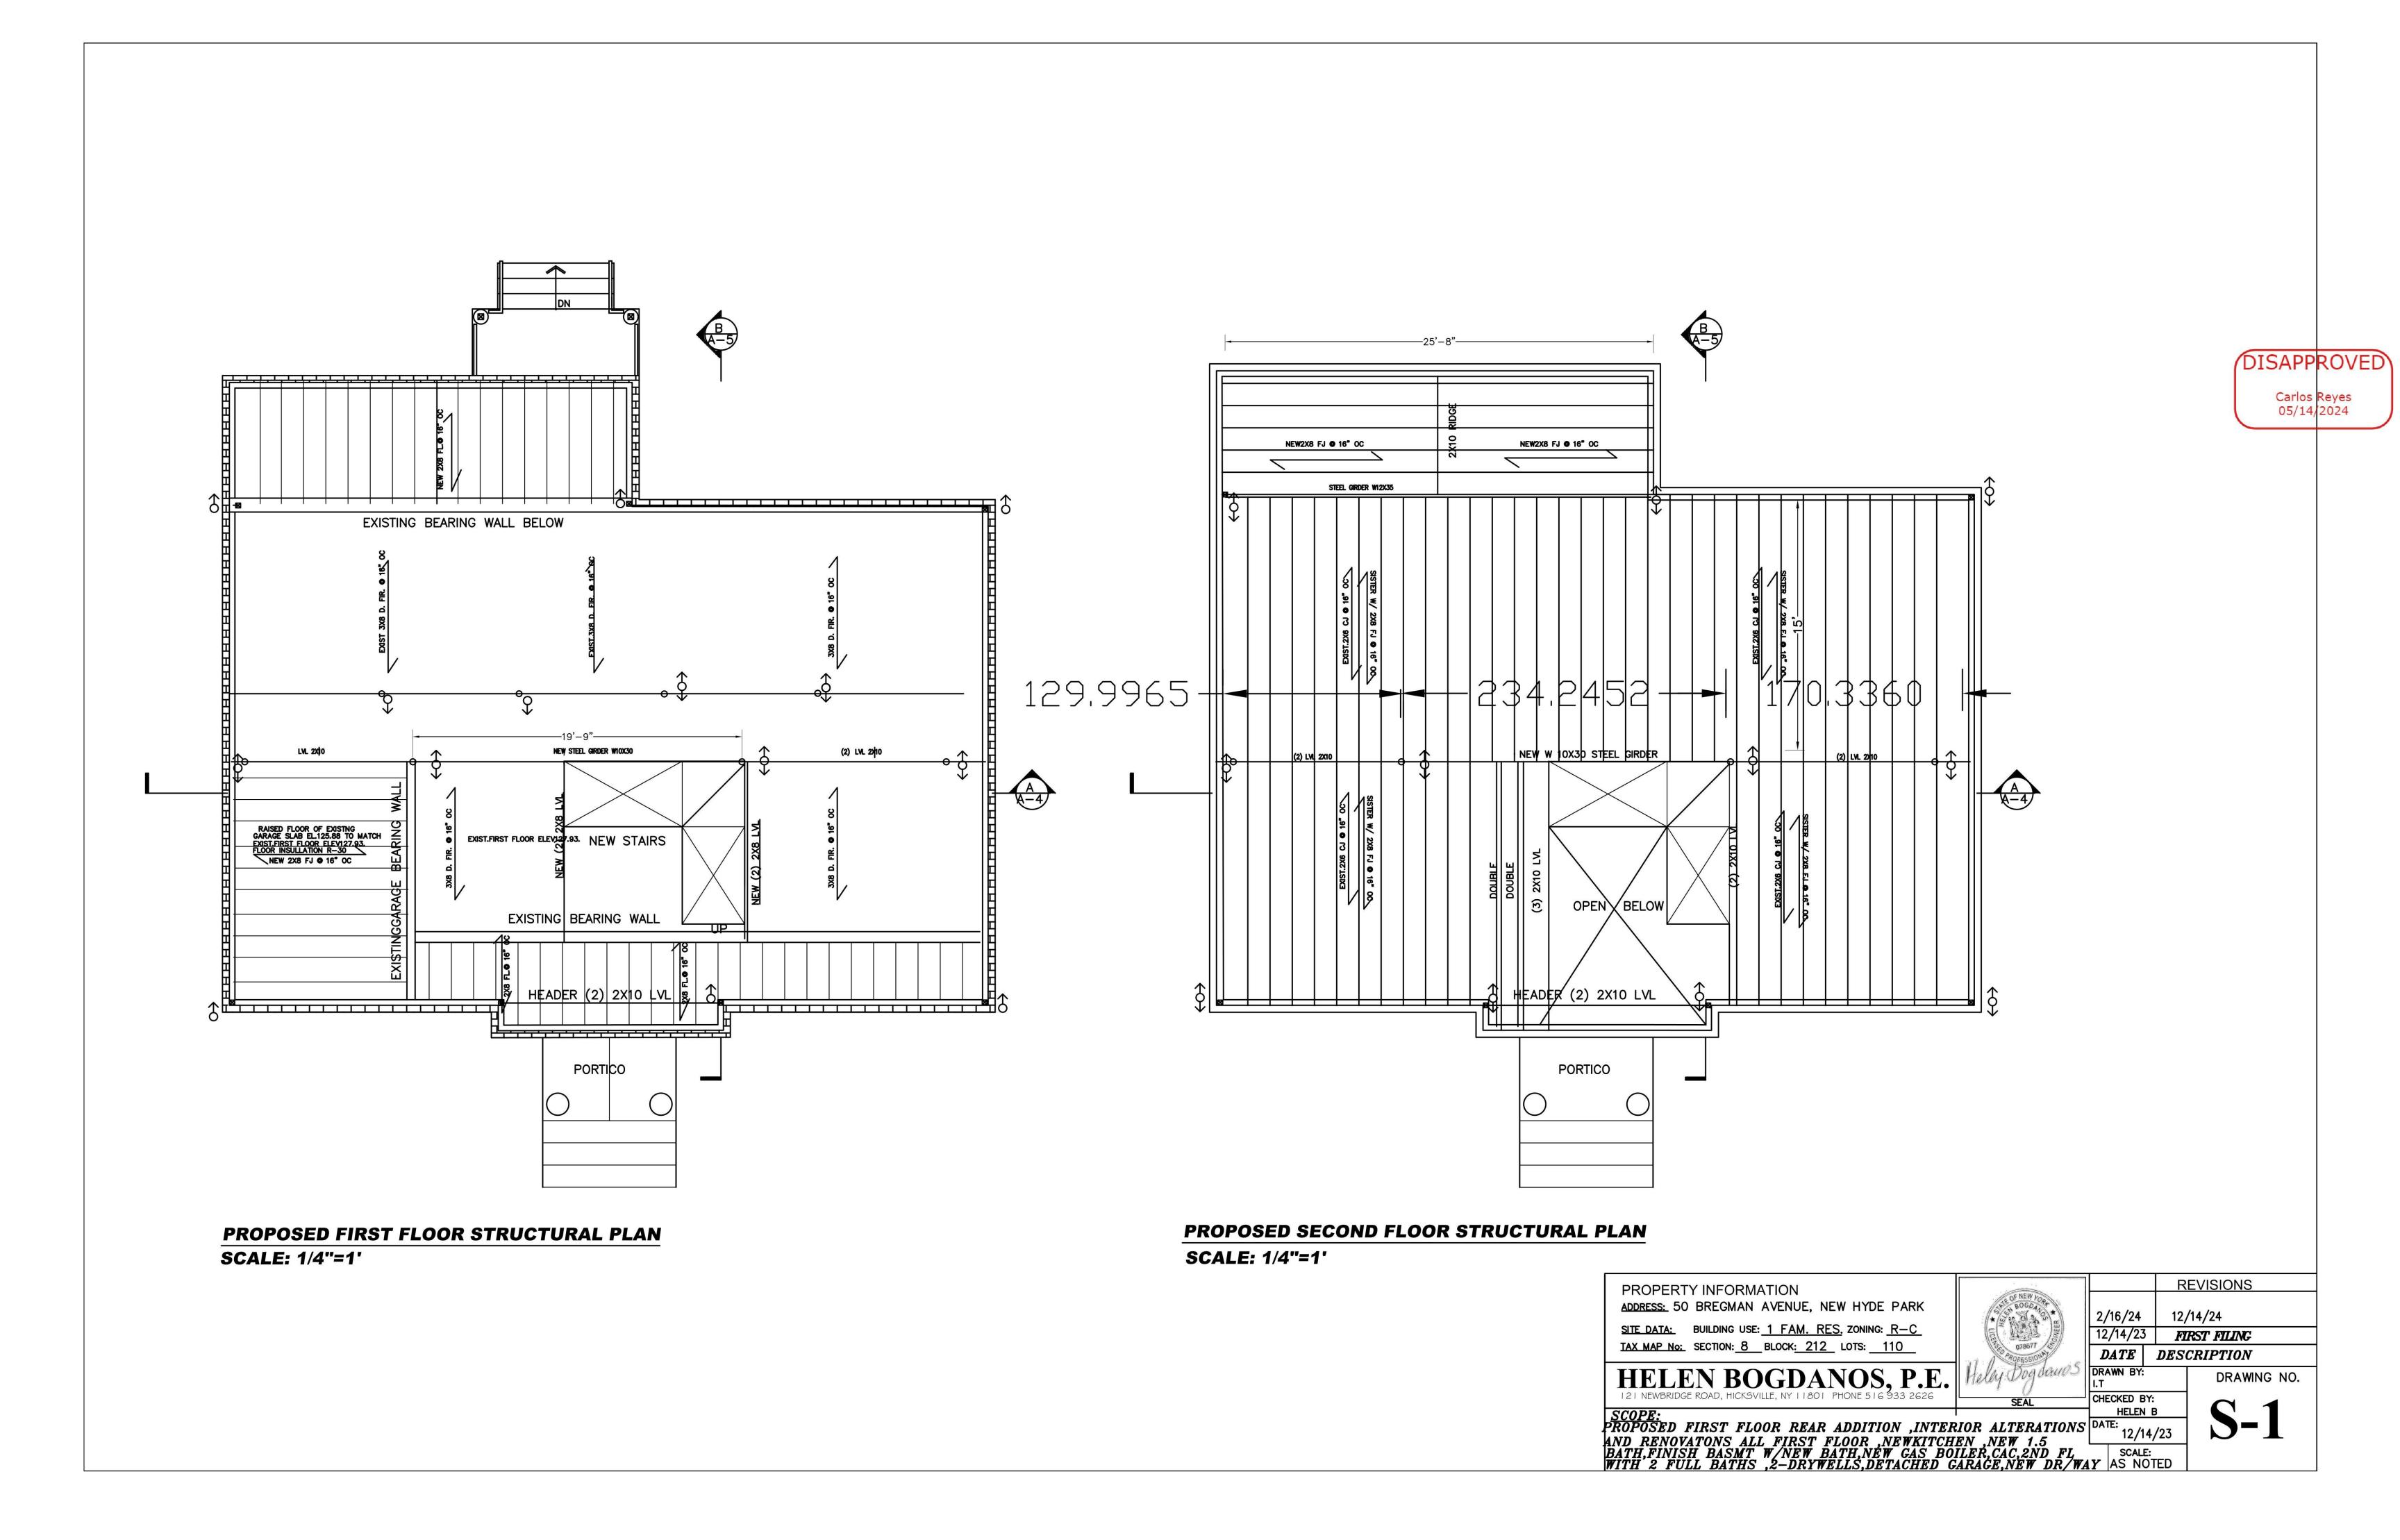

Carlos Reyes 05/14/2024

PROPERTY INFORMATION ADDRESS: 50 BREGMAN AVENUE, NEW HYDE PARK SITE DATA: BUILDING USEFAM. RES. ZONING: R-C TAX MAP NSECTIONS BLOCK212 LOTS: 110

HELEN BOGDANOS, P.E.
121 NEWBRIDGE ROAD, HICKSVILLE, NY 11801 PHONE
516 933 2626

PROPOSED FIRST FLOOR REAR ADDITION, INTERIOR ALTERATIONS


AND RENOVATIONS ALL FIRST FLOOR, NEWKITCHEN, NEW 1.5


BATH, FINISH BASMT W/NEW BATH, NEW GAS BOILER, CAC, 2ND FL
WITH 2 FULL BATHS, 2-DRYWELLS, DETACHED GARAGE, NEW DR/WAY


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y Bog danos	DRAWN I.T		DRAW	ING NO.	
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3-2





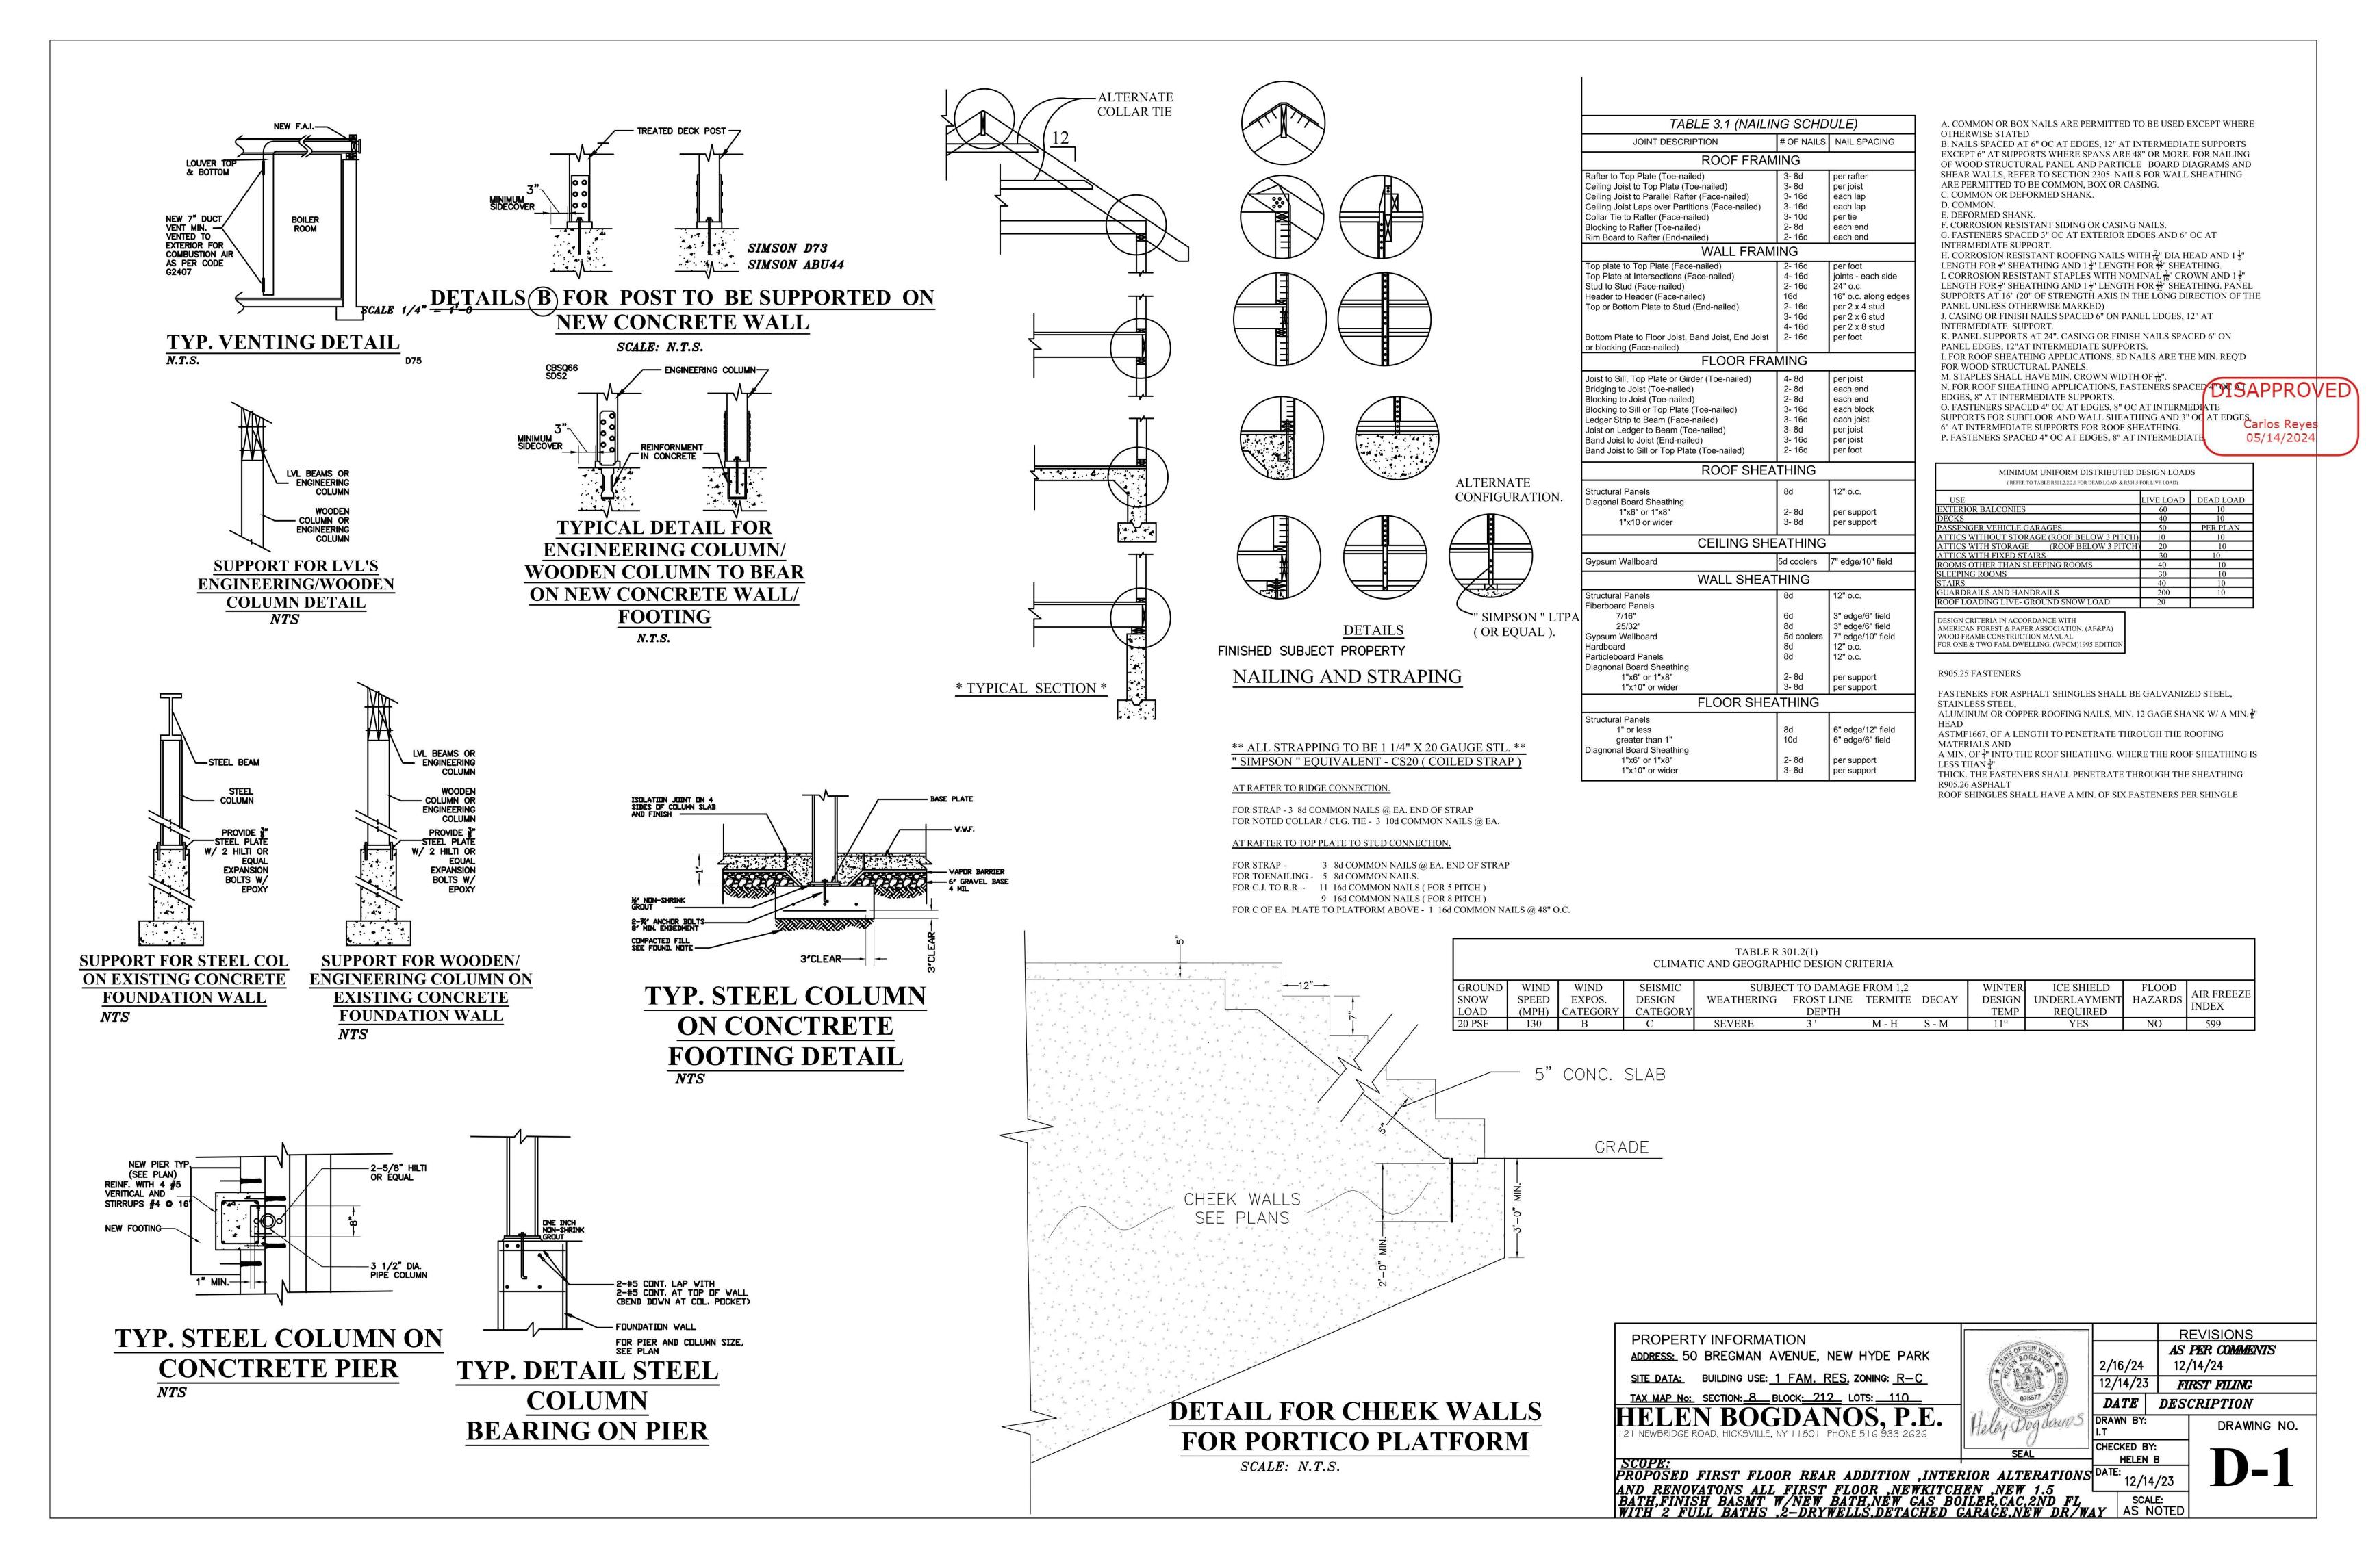

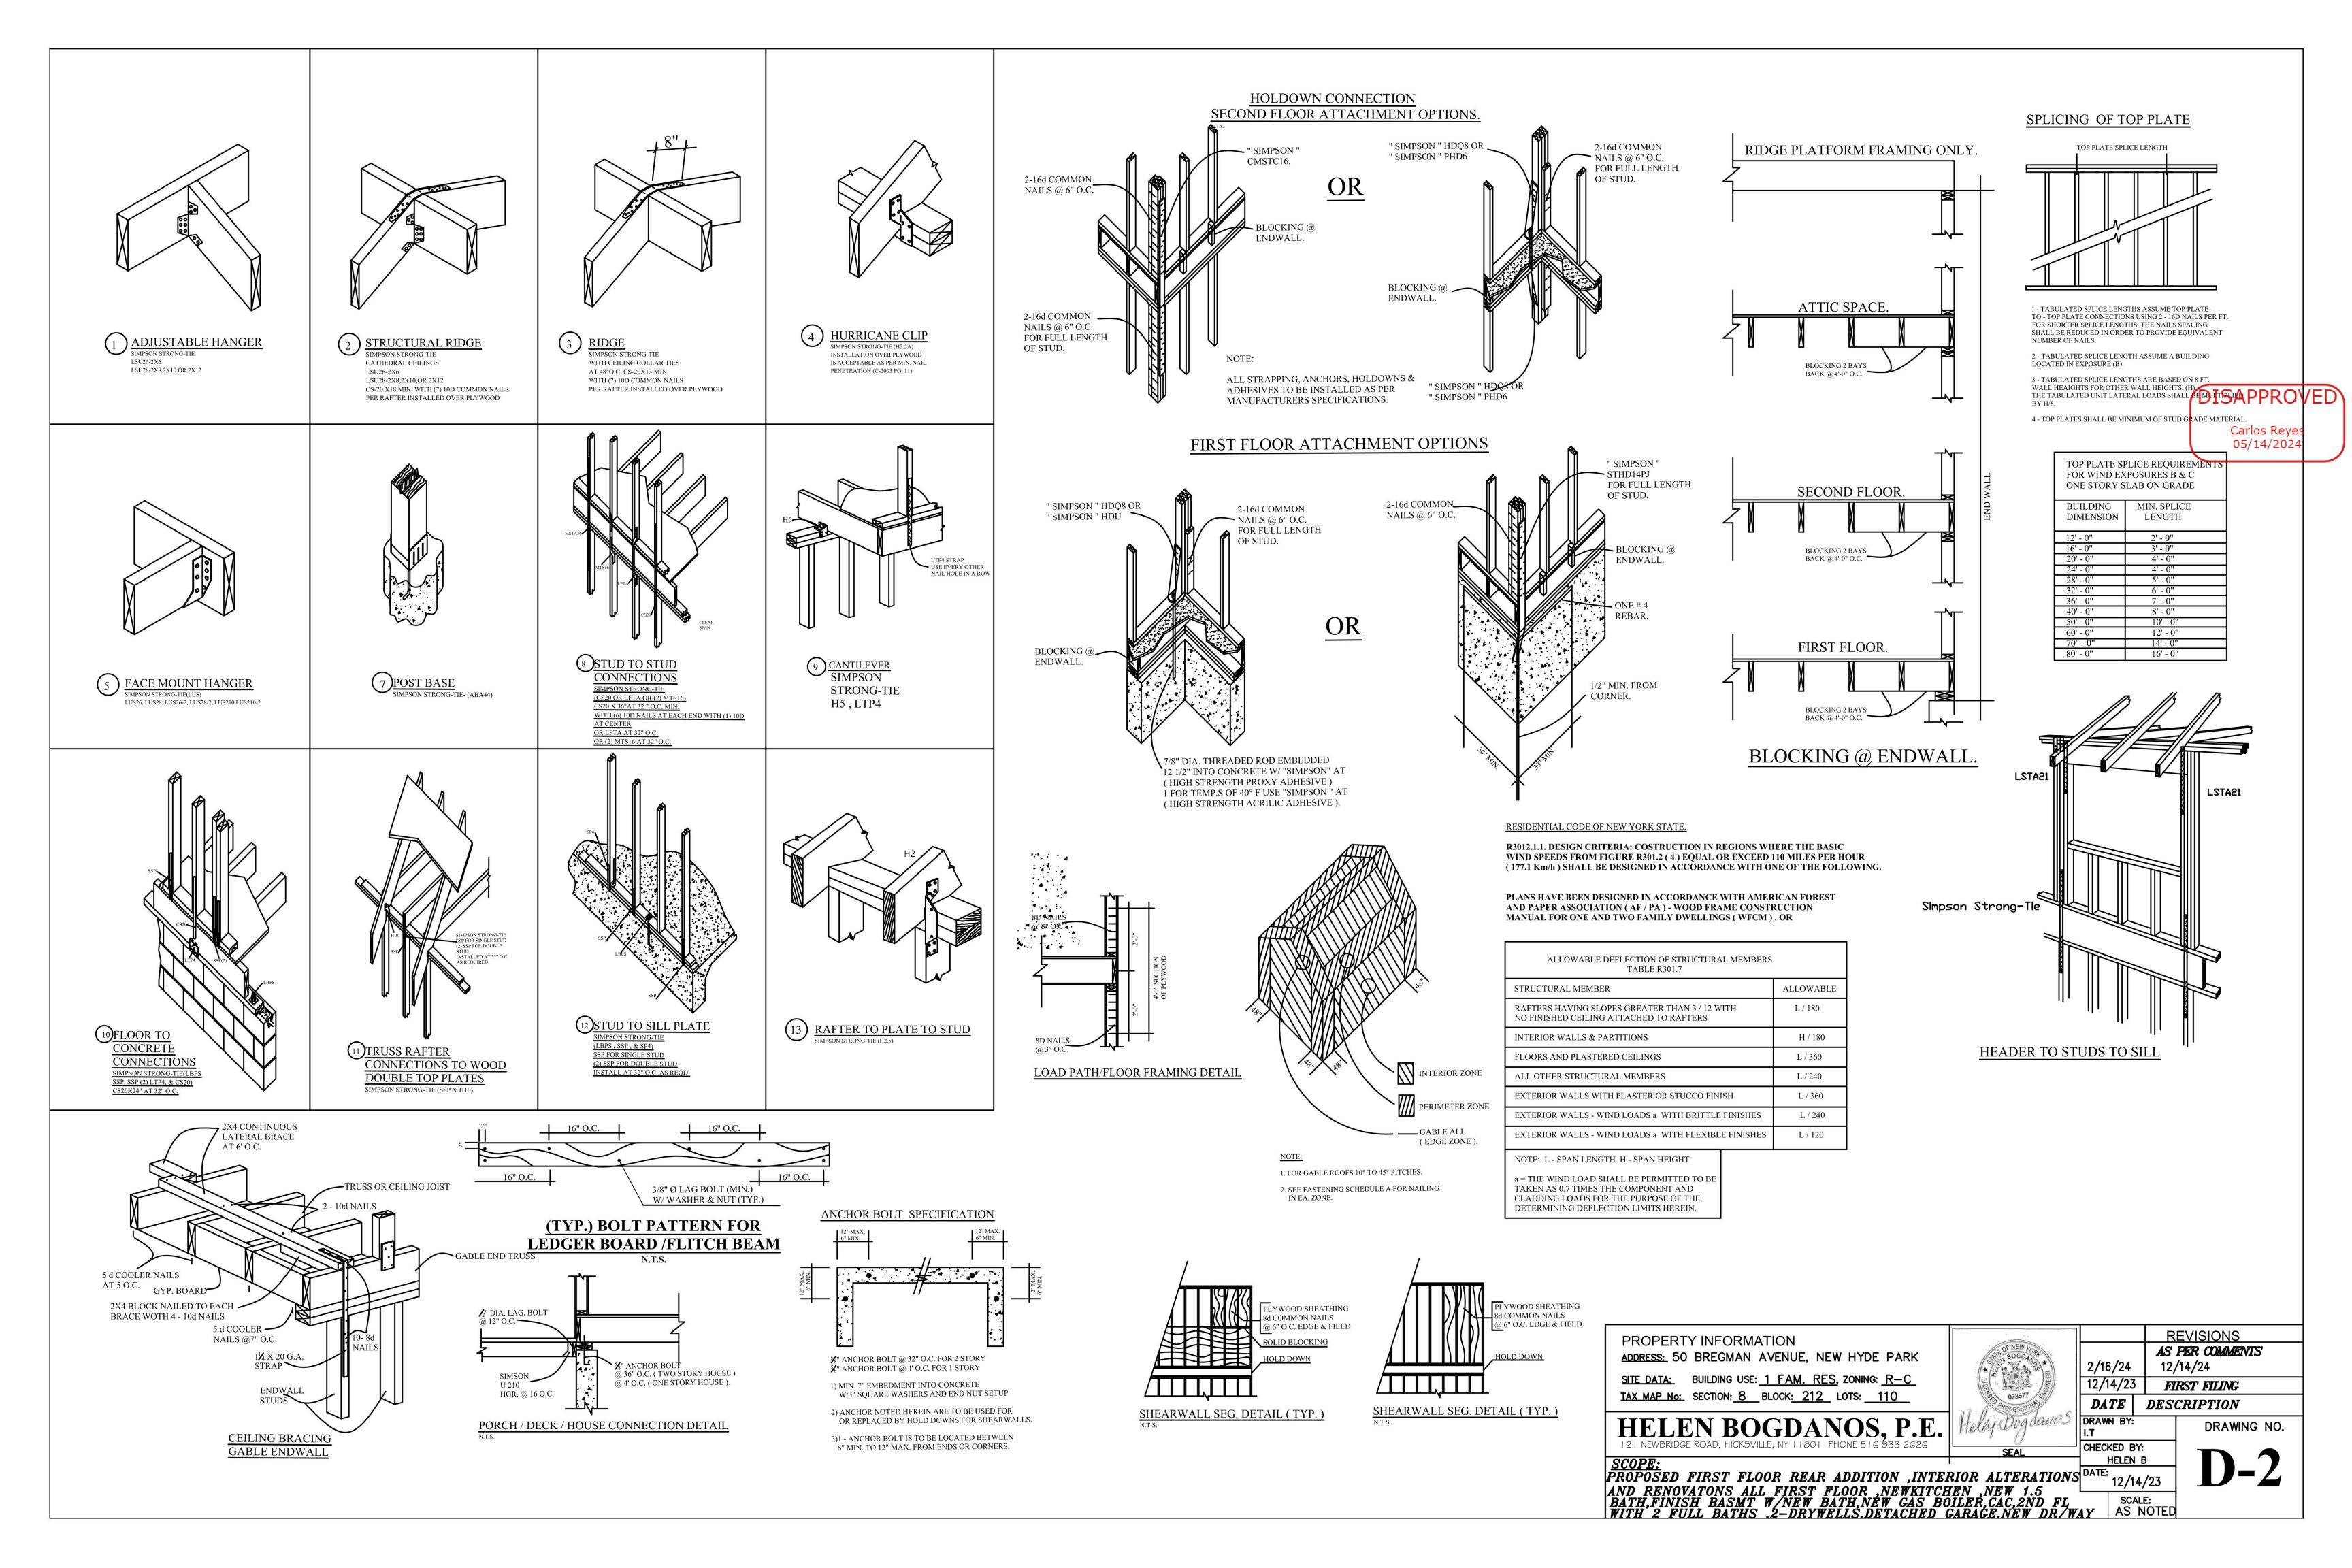DISAPPROVED

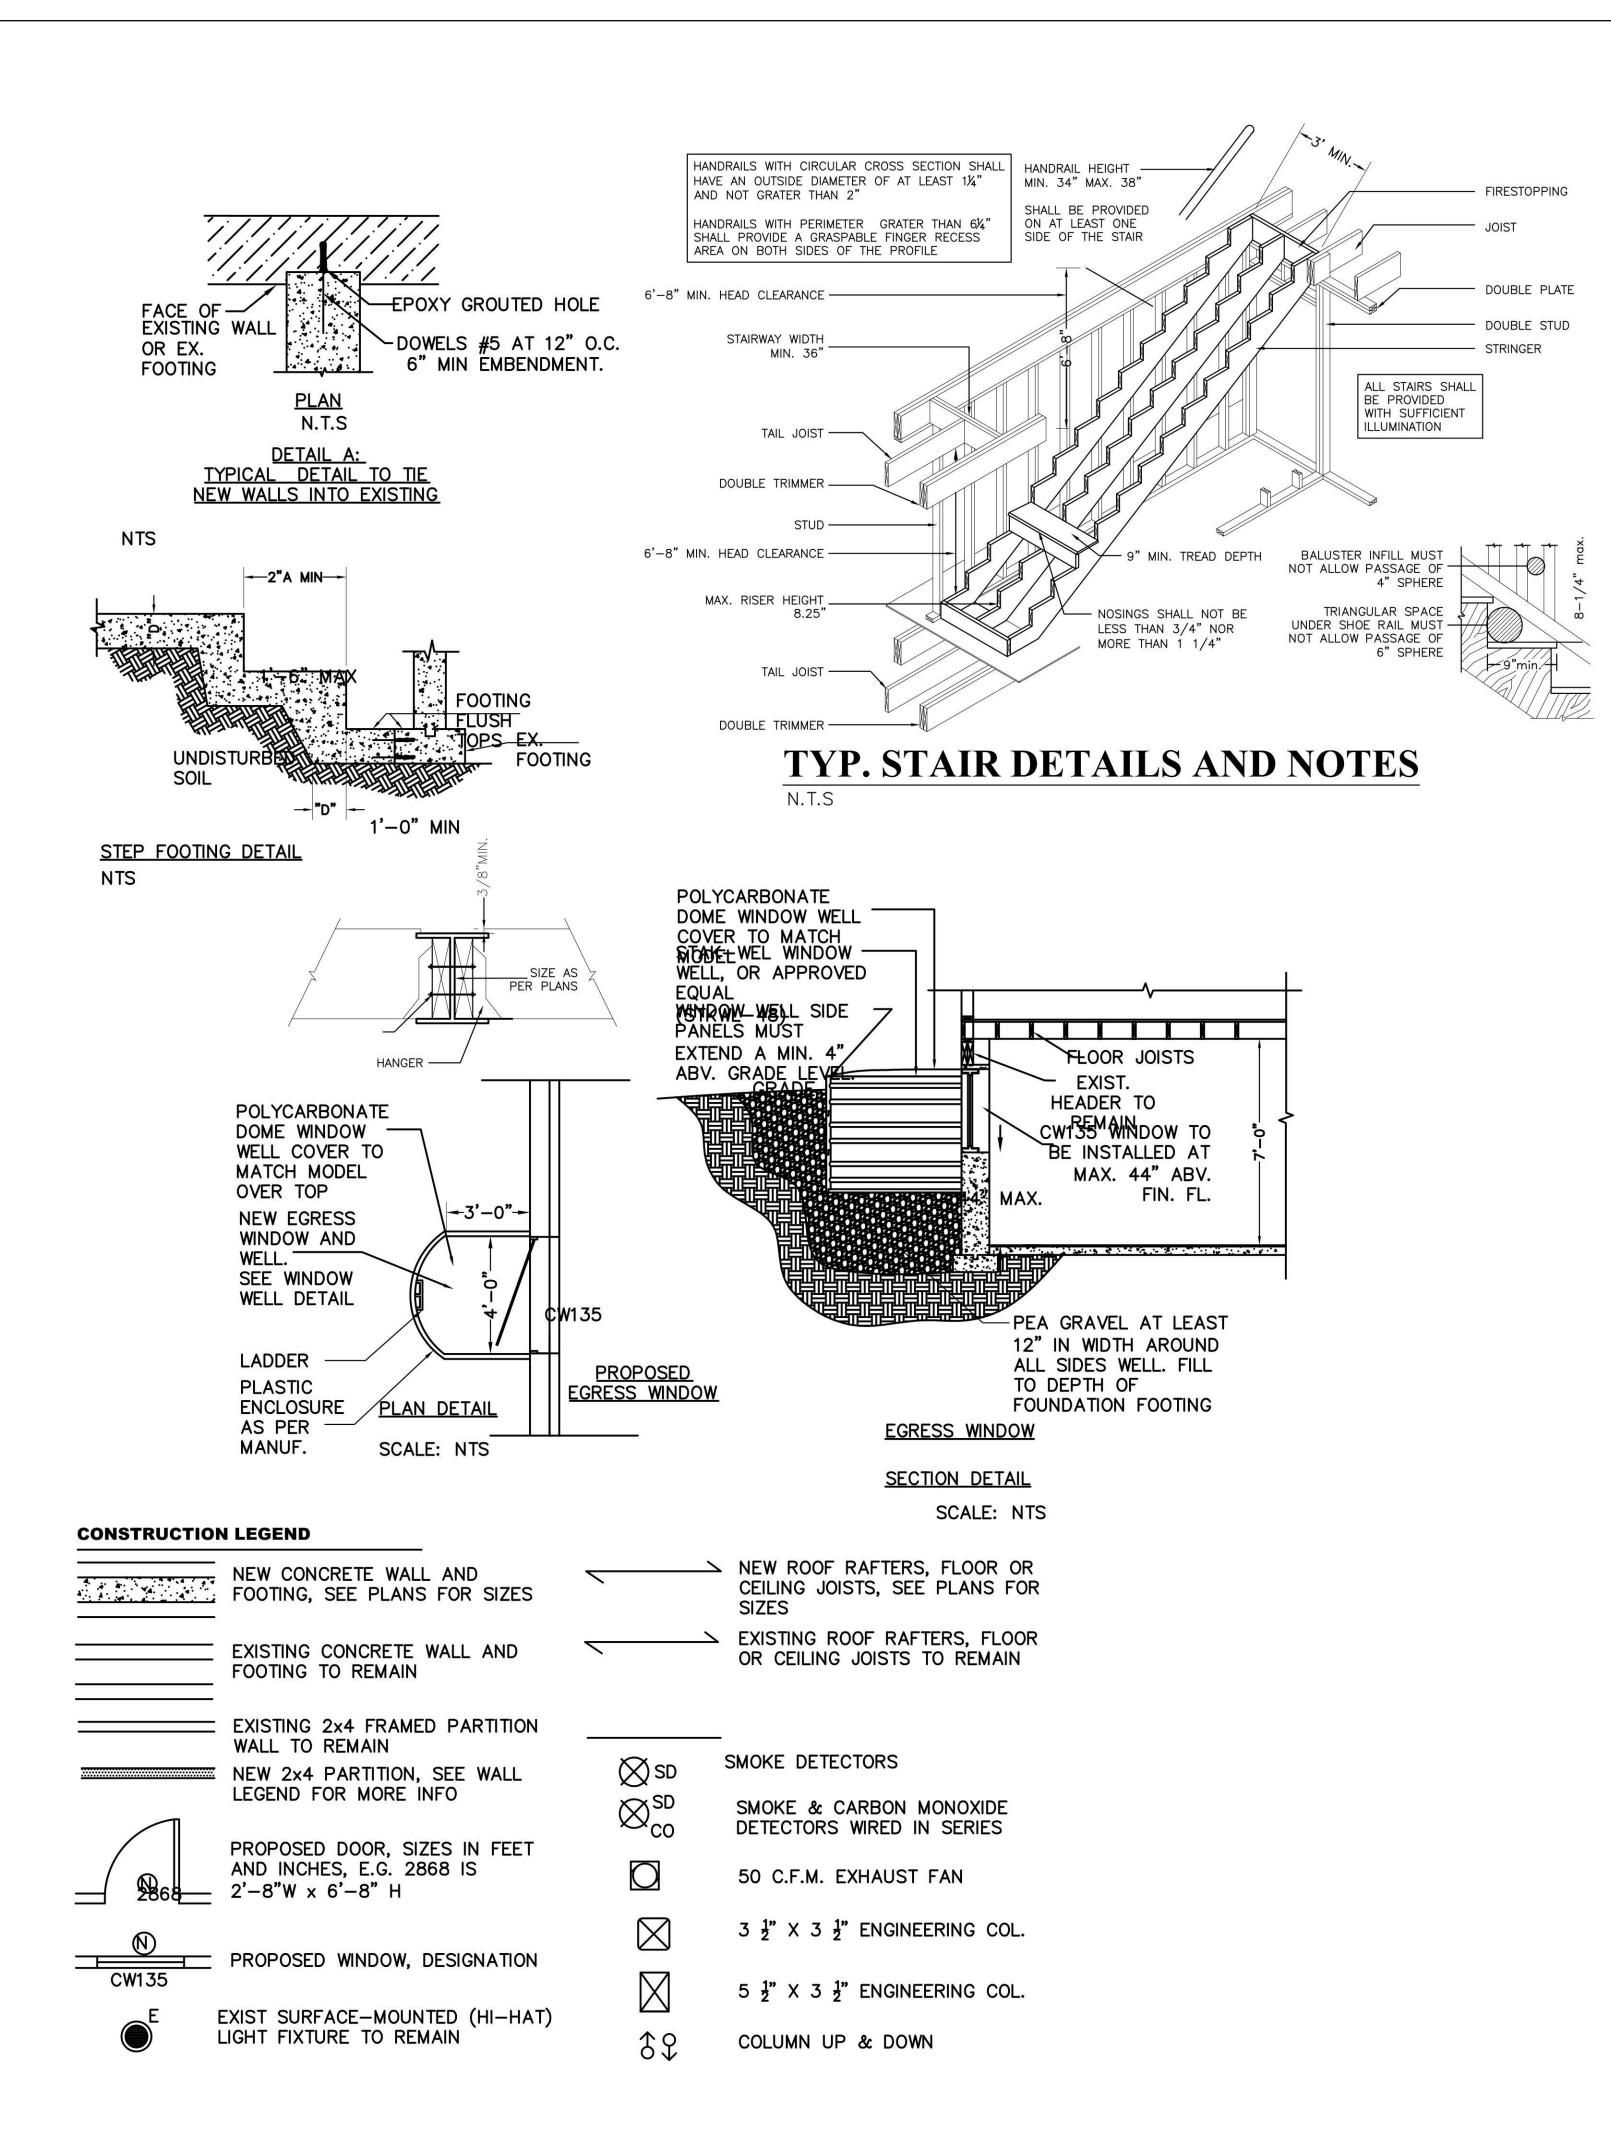Carlos Reyes

05/14/2024

PROPERTY INFORMATION

ADDRESS: 50 BREGMAN AVENUE, NEW HYDE PARK SITE DATA: BUILDING USEFAM. RES. ZONING: R-C TAX MAP NSECTIONS BLOCK212 LOTS: 110

HELEN BOGDANOS, P.E.
121 NEWBRIDGE ROAD, HICKSVILLE, NY 11801 PHONE
510 933 2020

THE OF NEW YORK
Holy Dog days
Hely: Dogowie-

~		RI	EVISIONS
	2/16/24		PER COMMENTS 14/24
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SCOPE:

PROPOSED FIRST FLOOR REAR ADDITION INTERIOR ALT


CHECKED BY:
HELEN B
DATE:
12/14/23
SCALE:
AS NOTED

PROPOSED FIRST FLOOR REAR ADDITION, INTERIOR ALTERATIONS


AND RENOVATONS ALL FIRST FLOOR, NEWKITCHEN, NEW 1.5

BATH, FINISH BASMT W/NEW BATH, NEW GAS BOILER, CAC, 2ND FL
WITH 2 FULL BATHS 2-DRYWELLS, DETACHED GARAGE, NEW DR/WAY

AS NOTED

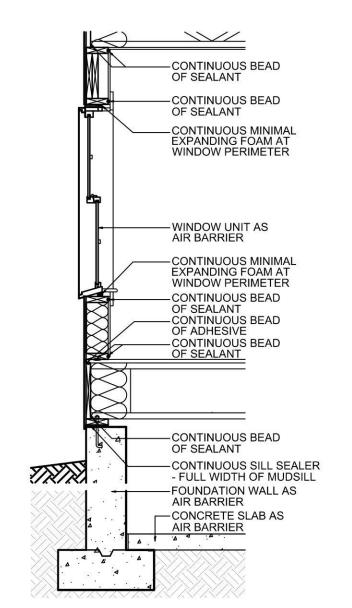

CONCEPTUAL AIR SEALING STRATEGY // LOWER WALL SECTION Scale:NTS

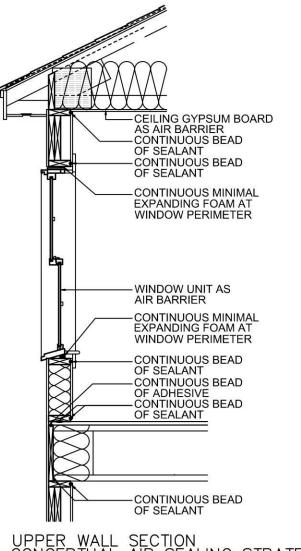


UPPER WALL SECTION CONCEPTUAL AIR SEALING STRATEGY //

—ELECTRICAL WIRE


- EXPANDING FOAM SEALANT

TOP PLATE


--- WALL STUD

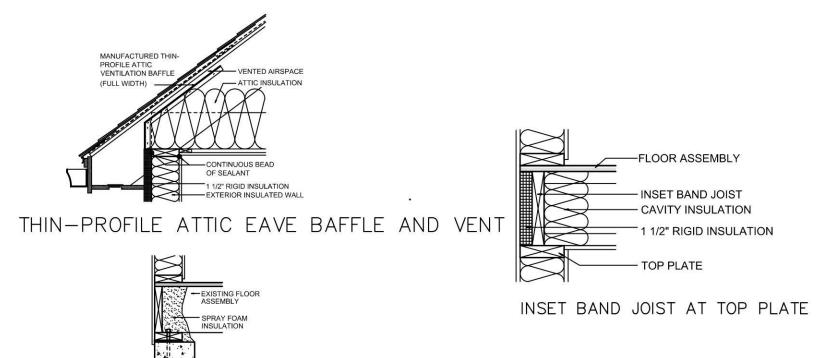


EXISTING BAND JOIST INSULATION RETROFIT WITH SPRAY FOAM

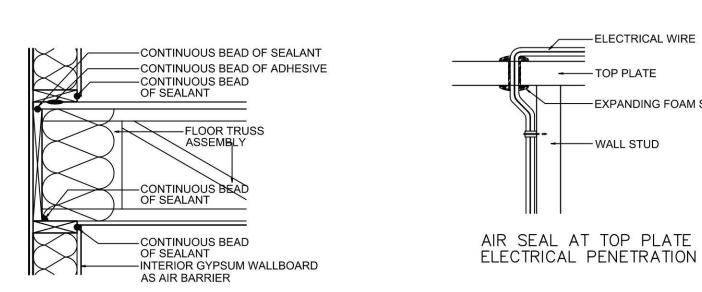

CONCEPTUAL AIR SEALING STRATEGY AT UPPER FLOOR BAND JOIST

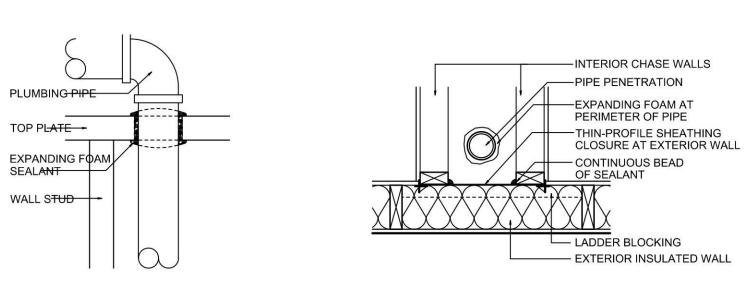


AIR SEAL AT CHASE WALLS // PLAN AIR SEAL AT TOP PLATE PIPE PENETRATION

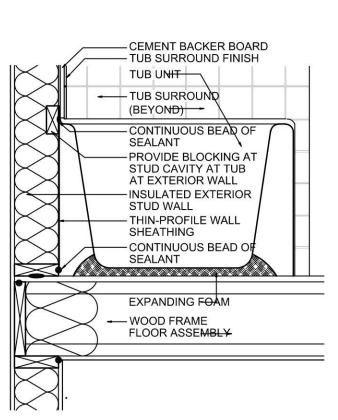

AIR SEALING BEHIND TUB WITH THIN—PROFILE SHEATHING // SECTION

- ATTIC INSULATION - ATTIC FLOOR FRAMING

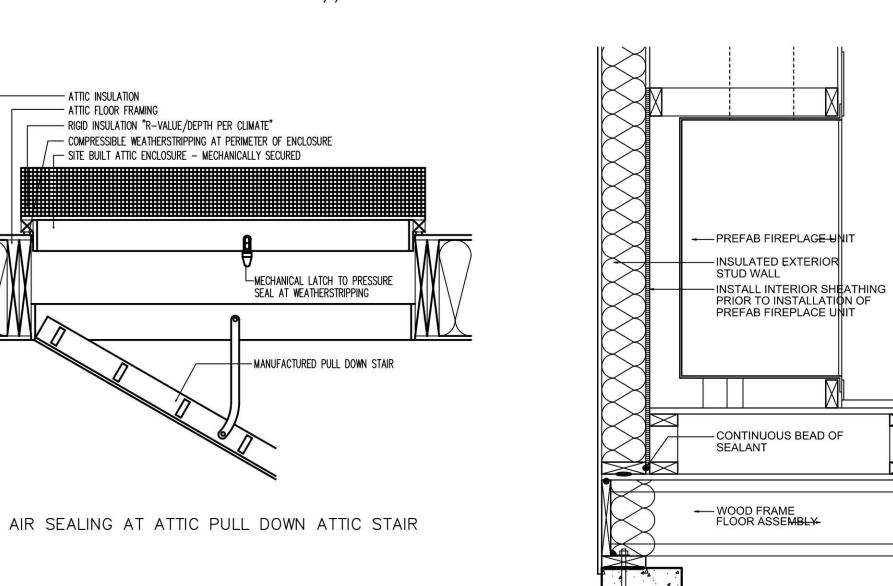

1" RIGID INSULATION CLOSURE

UPPER WALL SECTION

AIR SEALING AT PLATFORM FOR MANUFACTURED FIREPLACE ASSEMBLY

G.C. TO ARRANGE FOR A TEST PRIOR TO CONSTRUCTION ACH 50 AND ADDITIONAL DOOR BLOWER TEST AFTER ALL INSULATION WORK HAS BEEN COMPLETED. G.C. IS RESPONSIBLE FOR RECTIFYING ANY DIFFERENCES (BELOW STATED N.Y.S. APPROVED READINGS)

TABLE R402.1.2: INSULATION AND FENESTRATION REQUIREMENTS BY COMPONENT

CLIMATE ZONE 6 OPTION 1	FENESTRATION U-FACTOR	SKYLIGHT U-FACTOR	GLAZED FENESTRATION SHGC	CEILING R-VALUE	WOOD FRAME WALL R-VALUE	MASS WALL R-VALUE	FLOOR R-VALUE	BASEMENT WALL R-VALUE	SLAB R-VALUE & DEPTH	CRAWLSPACE WALL R-VALUE
	0.32	0.55	0.4	49/38 ^a	20+5 or 13+10 ^e	15/20 ^b	30 ^f	15/19 ^C	10, 4 ft ^d	15/19 ^C


a. R-38 insulation is allowed in lieu of R-49 if entire surface of attic is covered with insulation and it goes over sill plates

b. The second R-value applies when more than half the insulation is on the interior of the mass wall

c. "15/19" means R-15 continuous insulation on the interior or exterior of the home or R-19 cavity insulation at the interior of the basement wall. "15/19" shall be permitted to be met with R-13 cavity insulation on the interior of the basement wall plus R-5 continuous insulation on the interior or exterior of the home. "10/13" means R-10 continuous insulation on the interior or exterior of the home or R-13 cavity insulation at the interior of the basement wall. d. R-5 shall be added to the required slab edge R-values for heated slabs. Insulation depth shall be the depth of the footing or 2 feet, whichever is less in Climate Zones 1 through 3 for heated slabs.

i. The second R-value applies when more than half the insulation is on the interior of the mass wall.

h. The first value is cavity insulation, the second value is continuous insulation, so "13+5" means R-13 cavity insulation plus R-5 continuous insulation.

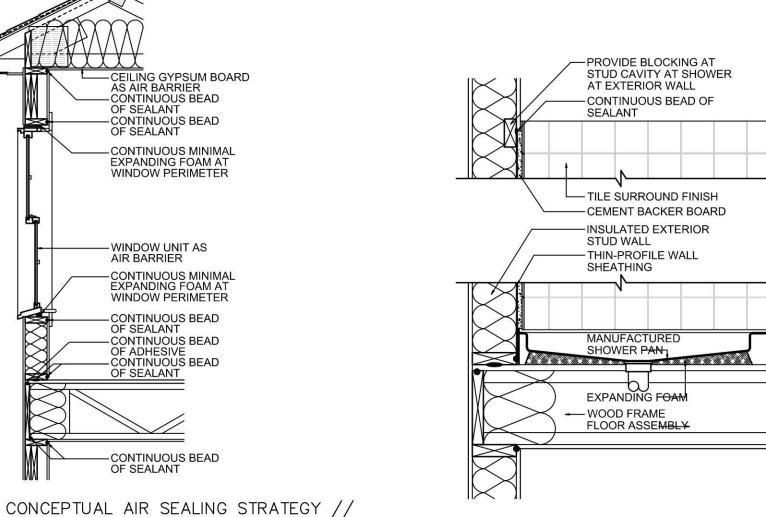



INSTALL EXPANDING

INTENTIONAL GA

CONTINUOUS BEA


1" RIGID INSULATION

SOFFIT CLOSURE

AT 1" RIGID


INSULATION -

FOAM SEALANT

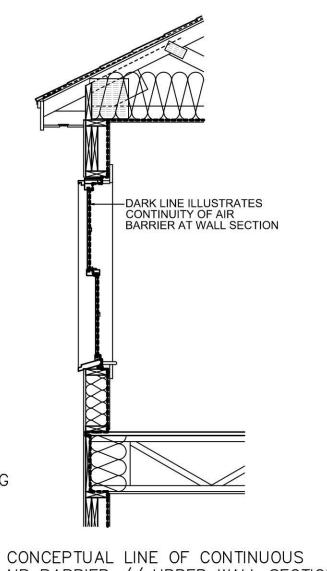


EXISTING FLOOR ASSEMBLY-— OPTIONAL CAVITY INSULATION — EXPANDING FOAM AROUND/ THE PERIMETER OF LOOSE CUT RIGID INSULATION DISAPPROVED EXISTING BAND JOIST INSULATION RETROELT Reves
WITH 1 1/2" RIGID INSULATION 05/14/2024

CONCEPTUAL LINE OF CONTINUOUS AIR BARRIER // UPPER WALL SECTION

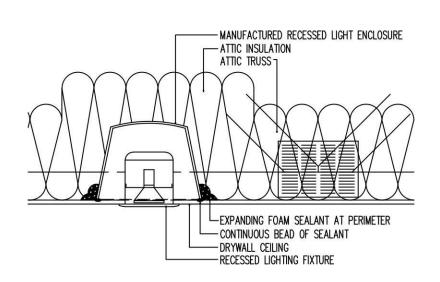

AIR SEALING AT RECESSED LIGHTING IN ATTIC

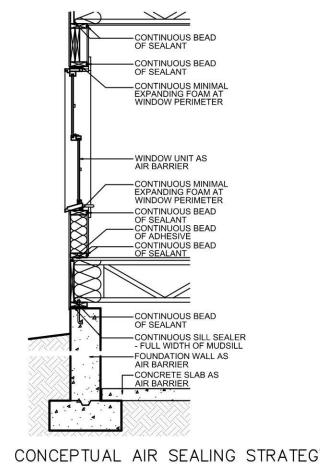

INSTALL 1" RIGID INSULATION AT

BOTH HORIZONTAL AND

VERTICAL POSITIONS

(LEAVE 3/8" GAP FOR

EXPANDING FOAM)

—EXISTING FLOOR

ASSEMBL¥

INSULATED CANTILEVER FLOOR // CAVITY INSULATION WITH

CONCEPTUAL AIR SEALING STRATEGY // LOWER WALL SECTION

PROPERTY INFORMATION		Ó	R	EVISIONS	
ADDRESS: 50 BREGMAN AVENUE, NEW HYDE PARK	STE OF NEW YORK	0 /10 /01		PER COMMENTS	
SITE DATA: BUILDING USE: 1 FAM. RES. ZONING: R-C	HER CSO THE PERSON AND THE PERSON AN	2/16/24 12/14/23		/14/24 RST FILING	
TAX MAP No: SECTION: 8 BLOCK: 212 LOTS: 110	078677 CO PROFESSIONA	DATE		CRIPTION	
HELEN BOGDANOS, P.E. 121 NEWBRIDGE ROAD, HICKSVILLE, NY 11801 PHONE 516 933 2626	Heley Dog danos	DRAWN BY:	1700000	DRAWING NO.	
SCOPE:	SEAL	CHECKED E	H Misself		
PROPOSED FIRST FLOOR REAR ADDITION, INTERIOR ALTERATIONS DATE: 12/14/23					
AND RENOVATONS ALL FIRST FLOOR, NEWKITCH BATH, FINISH BASMT W/NEW BATH, NEW GAS BOWITH 2 FULL BATHS, 2-DRYWELLS, DETACHED (IEN ,NEW 1.5 DILER,CAC,2ND FL GARAGE,NEW DR/W	AY AS	ALE: NOTED		

XU RESIDENCE 3 TWELFTH STREET, CARLE PLACE, NY 11514

LOT: 30

REMOVED MAINTAINED

TO BE

TO BE

- 231 S.F.

- 104 S.F.

ZONE: R-B

TOTAL

7,000 S.F.

1,512 S.F.

1,172 S.F.

235 S.F.

176 S.F.

99 S.F.

BUILDING

1,512 S.F.

51 S.F.

235 S.F.

176 S.F.

1,172 S.F.

99 S.F.

TOTAL:

2,783 S.F.

6'-0" PVC FENCE WITH TO

BE MAINTAINED

(LENGTH=22.32')

6'-0" PVC FENCE WITH TO BE

MAINTAINED AT NEW

LOCATION (LENGTH= 20.65')

PROPOSED 6'-0" PVC FENCE WITH

GATE (GATE TO SWING OUT FROM

YARD WITH SELF CLOSING

HARDWARE, LOCK AND LATCH)

(LENGTH=9.70')

PROPOSED POOL **EQUIPMENT**

SPECIFICATIONS

PLATFORM

SECTION N1102 (R402) BUILDING THERMAL ENVELOPE

TO BE INSTALLED AS

PER MANUFACTURER'S

EXISTING A/C UNITS

TO BE RELOCATED

PROPOSED

34 S.F.

530 S.F.

235 S.F.

176 S.F.

99 S.F.

ARCHITECTURAL PLOT PLAN

BLOCK: 269

7,000 S.F

1,478 S.F.

642 S.F.

231 S.F.

104 S.F.

EXISTING

SECTION: 10

AREAS (S.F.)

TOTAL LOT:

DECK:

PORCH:

PAVILLION:

FIRST FLOOR:

SECOND FLOOR:

DISAPPROVED - Make corrections as noted and resubmit

ZONING / TOWN CODE COMPLIANCE

Anthony Raguseo 05/07/2024

EXISTING

6'-0" PVC FENCE WITH TO

BE MAINTAINED

 $\overline{(LENGTH=70.27')}$

EXISTING 二 WOOD ~!

PLANTER O

PROPOSED 8'x19'

IN-GROUND POOL

PROPOSED

SECOND

STORY

ADDITION

10.00'9

ANY NON-PERMITTED ITEMS ARE THE CLIENTS RESPONSIBILITY UNLESS MARK ANTHONY ARCHITECTS HAS BEEN **RETAINED TO RESOLVE OUTSTANDING ITEMS**

EXISTING ZONING ITEM PERMIT #

TO BE DETERMINED BY D.O.B.

CALCULATION 23.94'+ 32.97'+24.98+28.80+.21.76'+25.19'+27.23'=26.41'

PROPOSED

/11/x/9'/

AWNING

PROPOSED

WOOD

DECK/

PREFABRICATE LOUVERED

AVERAGE FRONT YARD SET BACK

CLIENT RESPONSIBILITY

PLUMBING APPLICATION (IF

TO BE FILED BY LICENSED PLUMBER

- ELECTRICAL APPLICATION (IF REOUIRED) TO BE FILED BY LICENSED **ELECTRICIAN**

- C of O / C of C - CLOSE OUT AND INSPECTIONS (BY OTHERS)

EXISTING 4'-0" WOOD/METAL FENCE &

GATE TO BE REPLACED WITH **PROPOSED**

6'-0" PVC FENCE WITH GATE (GATE TO

SWING OUT FROM YARD WITH SELF

CLOSING HARDWARE, LOCK AND LATCH)

(LENGTH=12.26')

28.80'

PROPOSED 8' Ø x 6' DEEP

PROPOSED -

NO CURB CUT **ALLOWED**

10.00'

26.41'

A.F.Y.S.

SIDE YARD

*****EL 104.56'

SCOPE OF WORK

APPLICATION FOR: -PROPOSED 2ND FLOOR ADDITION -PROPOSED 1st& 2nd FL. INTERIOR **ALTERATIONS** -PROPOSED 8'x19' POOL -PROPOSED 6'-0" PVC POOL ENCLOSURE (LENGTH= 135') -PROPOSED DECK -PROPOSED PREFABRICATED PAVILION -PROPOSED SEMI CIRCULAR DRIVEWAY

No errors, omissions, or oversight on the part

of the Plan Examiner shall release the design

Zoning Laws of the Town of North Hempstead,

of jurisdictions having authority over the work.

#21582

and all other applicable codes and standards

professional, applicant, and/or owner of the

responsibility to comply with all the

S

requirements of the NYS Building Code,


All Drawings, Specifications and the design xpressed therein are the sole property of Mark Anthony Architects. They are to be used only with respect to this Project and are not to be copied or reproduced without written permission of Mark Anthony Architecture P.C. It is a violation of the law for any person, unless acting under the direction of a licensed architect, to alter ar item in any way, If an item bearing the seal of an architect is altered, the altering architect shall affix to his item the seal and notation "altered by" followed by his signature and the date of such alteration and a specific description of the alteration

ALL DIMENSIONS ARE TO BE FIELD VERIFIED

ISSUED FOR	
PRELIMINARY DRAWING	
FOR OWNERS REVIEW	
FOR BIDDING PURPOSES	
FOR BUILDING DEPT.	
FOR CONSTRUCTION	
AS BUILT DRAWINGS	

NO.	DATE 02/14/23	DESCRIPTION
	00/11/03	2 22 22 20 20 20 20 20 20 20 20 20 20 20
	02/14/23	CABINET LAYOUT UPDATI
	01/16/24	D.O.B. RESBMISSION
	01/23/24	D.O.B. RESBMISSION
	03/14/24	D.O.B. RESBMISSION

	867	
PR	OJECT NO.	2022220
DA	TE	03/14/24
50	CALE	AS NOTED
DR	AWN BY	M.Z S.D S.V.

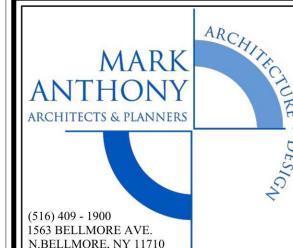



ZONING & PLOT PLAN

RESIDENCE

3 TWELFTH STREET CARLE PLACE, NY 11514

D.O.B. I.D#

RBP22-001079 F.A.R. **FOOTPRINT** 1,512 S.F.

STATION TO BE

19

REMOVED

PROPOSED BBQ GRILL

GRESS

WINDOW

FLOOR

CANTILEVER

EXISTING

2 STORY FRAME

DWELLING

PRE-EXST AVR GRADE: EL 104.65


EXST & PRO 1st F.F.: EL 106.35

PRO EAVE.: EL 121.59 PRO RIDGE: EL 133.18

WELL

100.0

EXISTING 4'-0" PVC FENCE TO BE REPLACED WITH 6'-0" PVC FENCE

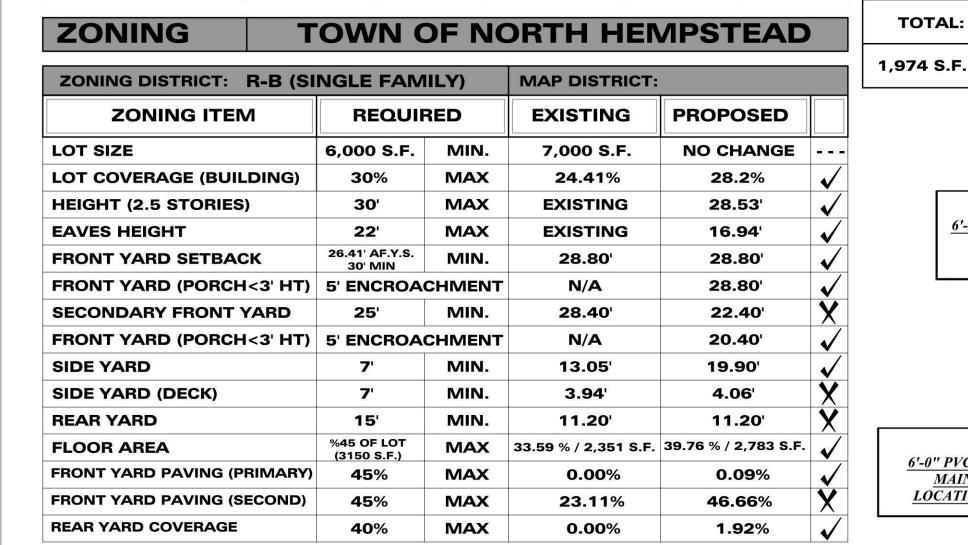

ZONING DISTRICT: RES-B	PROPOSED BBQ					
ZONING ITEM	REQU	IIRED	EXISTING	PROPOSED		
SIDE YARD	10'	MIN.	N/A	7.39'	X	

ZONING DISTRICT: RES-B	POOL EQUIPMENT					
ZONING ITEM	REQU	JIRED	EXISTING	PROPOSED		
REAR YARD	15'	MIN.	N/A	8.20'	X	

ZONING DISTRICT: RES-B	ACCESSORY:POOL						
ZONING ITEM	REQUIF	RED	EXISTING	PROPOSED			
NO POOL ALLOW IN		!	X				
SIDE YARD	10' MIN.		N/A	9.21'	X		
REAR YARD	15' MIN.		N/A	10.00'	X		
FENCE	6' HEIGHT	MIN	N/A	6' HEIGHT	√		

ZONING DISTRICT: RES-B			A/C UNITS					
ZONING ITEM	REQUI	RED	EXISTING	PROPOSED				
SIDE YARD	3'	MIN.	N/A	8.20'	√			
SIDE YARD	3'	MIN.	N/A	8.20'	√			
SIDE YARD	3'	MIN	N/A	8.20'	4			

PLOT PLAN INFORMATION AS PER:

SURVEY DRAWN: JULY 7, 2021

PETER J. BRABAZON PLS, P.C. PROFESSIONAL LAND SURVEYORS PETER J. BRABAZON (SURVEYOR)

430 WEST OLD COUNTRY ROAD HICKSVILLE, NY 11801 TEL: (516) 822-5111

THIS PROJECT HAS BEEN DESIGNED IN ACCORDANCE WITH THE RESIDENTIAL CODE OF NEW YORK STATE (2020)

"TO THE BEST OF MY KNOWLEDGE, BELIEF AND PROFESSIONAL JUDGMENT, THESE PLANS AND/OR SPECIFICATIONS ARE IN COMPLIANCE WITH THE "ENERGY CONSERVATION CONSTRUCTION CODE

(2020)" (N1102.1.2 (R402.1.2)) AND CHAPTER 11 RESIDENTIAL CODE OF NEW YORK STATE (2020)

TABLE R301.2(1)

CLIMATIC AND GEOGRAPHIC DESIGN CRITERIA

GROUND		WIND DESIGN			SEISMIC	SUBJECT	SUBJECT TO DAMAGE FROM V			ICE	FLOOD	AIR	DAE ANI ANIMILAI
SNOW LOAD	Speed (mph)	Topographic effects	Special wind region	borne	DESIGN CATEGORY	Weathering	frost line depth	Termite	DESIGN TEMP.	BARRIER UNDERLAYMENT REQUIRED	HAZARDS	FREEZING INDEX	MEAN ANNUAL TEMP
20 PSF	130	NO	NO	1 mi.	В	Severe	3'-4'	Moderate to Heavy	15	YES	9-11-09	496	52.9°F

Setbacks.

(a) An inground swimming pool and any mechanical equipment shall be no closer to the rear and side property lines than 10 feet or the minimum side yard setback requirements for a residential structure in a residential district, whichever is the more restrictive.

front yard where the main entrance is established.

§ 70-40. On a corner lot, a front yard shall be required on each street and, unless the building is controlled by § 70-40C, the front yard on the narrower street frontage shall be not less than 30 feet in depth and the other front yard shall be not less than 25 feet in depth; and if the street frontages are equal, a minimum front yard of 30 feet shall be required on each street

The minimum front yard depth for detached dwellings shall be the same as the average front yard depth of the existing primary buildings used as dwellings within 200 feet on each side of the lot on the same side of the street and within the same zoning district, or 30 feet, whichever is greater. No front yard shall be required to have a depth greater than 45 feet. On a lot with multiple street fronts, the average front yard setback shall only apply to the primary front yard

§ 70-42. .C. On a corner lot, a single-family dwelling shall have only one side yard. Said yard shall be on the side adjoining the interior lot opposite the front yard having the greater street frontage. Said side yard shall have a minimum width of seven feet. The two yards fronting on streets shall be considered front yards as provided under § 70-39B. The remaining yard shall be considered the rear yard and shall conform to the provisions of

EXISTING PROPOSED PROPOSED FOYER MASONRY STOOP -28.80' AND PLANTER **PAVEMENT** PROPOSED 10.00' 18' Ø x 6' DEEP **\DRYWELL** DRYWELL **EXISTING ASPHALT** PROPOSED SEMI CIRCULAR DRIVEWAY **DRIVEWAY ★**EL 104.35 PROPOSED LAWN 100.0°

1 STORY

10.00'


SECONDARY FRONT YARD EXISTING STONE CURB EXISTING 18' CURB CUT

CURB CUT SECOND FRONT YARD

TWELFTH STREET [Amended 7-9-1991 by L.L. No. 10-1991; 4-1-1997 by L.L. No. 8-1997

31.83'

Primary Front yard The front yard with the narrower street frontage. For lots having equal street frontage, the primary front yard shall be the

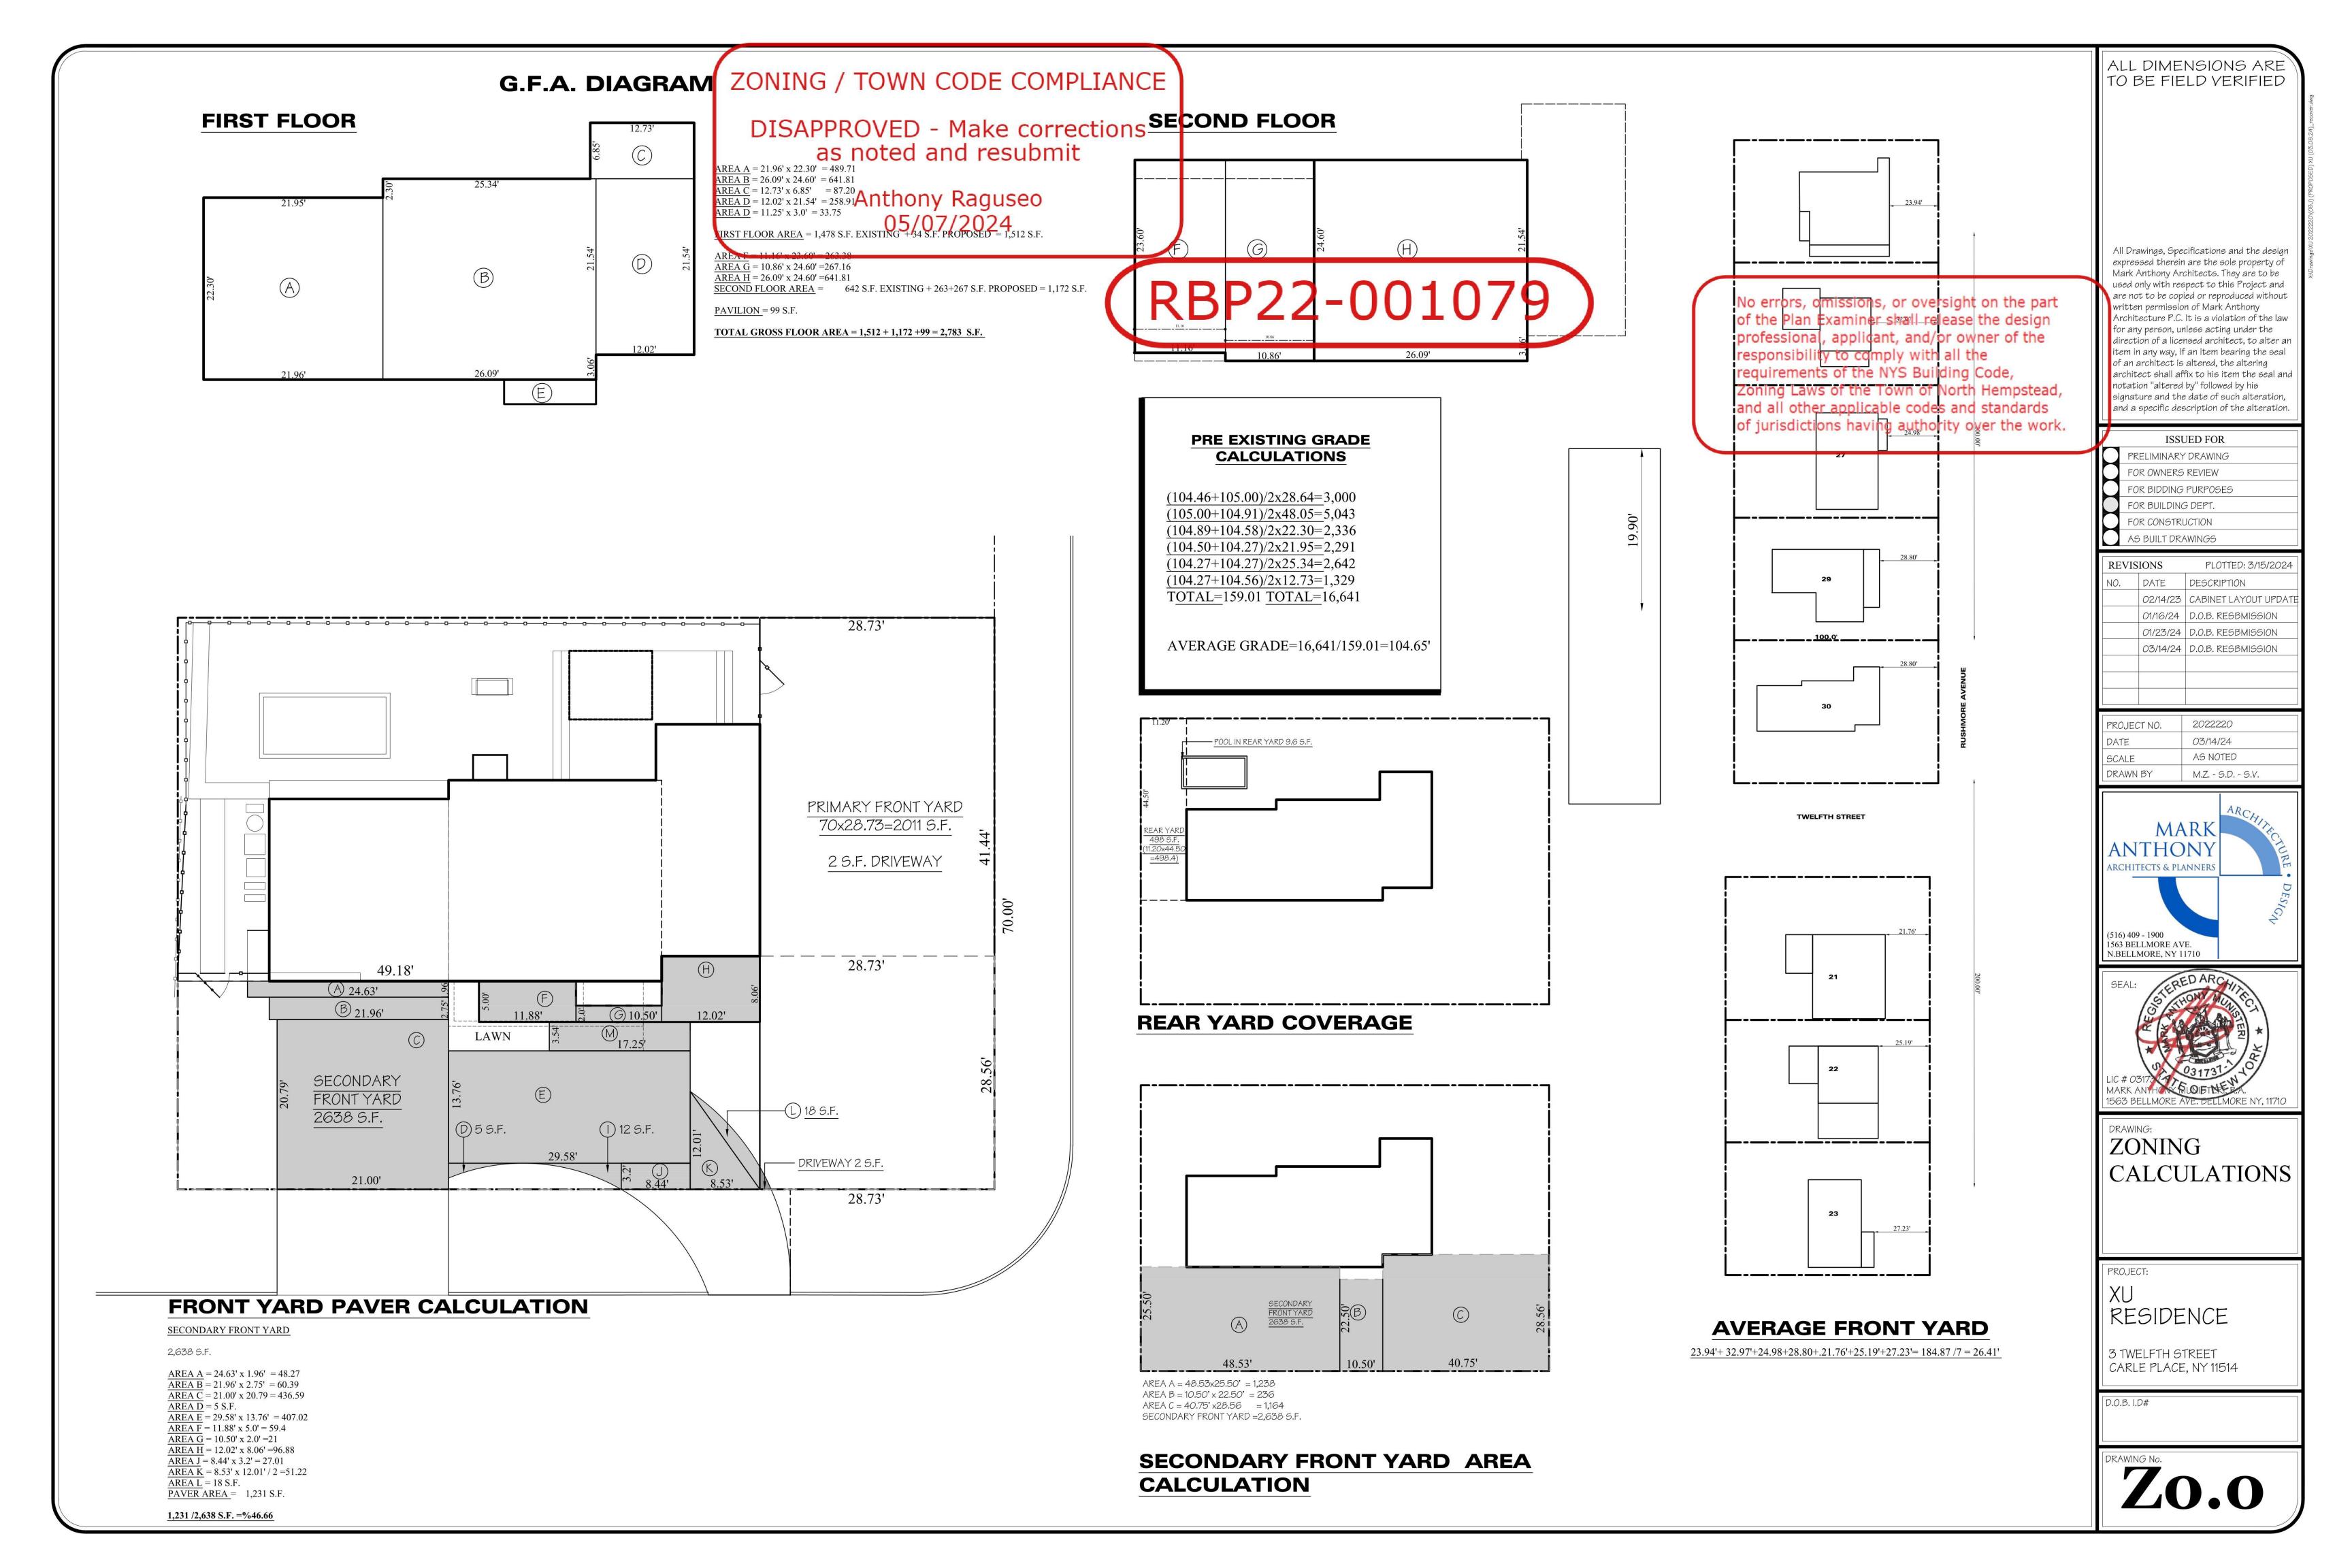

GENERAL NOTES

THE ARCHITECT OF RECORD HAS BEEN RETAINED ONLY FOR THE PURPOSE OF FILING THE PLANS TO OBTAIN A PERMIT AND HAS NO BEEN RETAINED FOR ANY SUPERVISION OR OBSERVATION OF THE WORK, AND HIS RESPONSIBILITY IS LIMITED TO THE ACCURACY OF THE PLANS. THESE DRAWINGS ARE FOR BUILDING DEPT. USE ONLY.

NOTED DIMENSIONS SHALL TAKE PRECEDENCE OVER THOSE SCALED.

ANY OMISSIONS OR CHANGES IN THESE DRAWINGS SHOULD BE BROUGHT TO THE ATTENTION OF THE ARCHITECT PRIOR TO ALL CONSTRUCTION AND/OR INSTALLATIONS BY THE CONTRACTOR.

THE CONTRACTOR SHALL VERIFY ALL CONDITIONS IN THE FIELD.

THE CONTRACTOR SHALL FIELD VERIFY THE LOCATION AND DEPTH OF ALL UNDERGROUND UTILITY PIPING PRIOR TO THE PROPOSED CONSTRUCTION EXCAVATION.

THE CONTRACTOR SHALL BRACE, SHORE, REINFORCE, AND/OR UNDERPIN ALL NEIGHBORING STRUCTURES AS REQUIRED FOR SAFE OPERATION.

ALL SITE DEVELOPMENT INCLUDING RETAINING WALLS, SIDEWALKS, PLANTINGS, ETC. BY OTHERS.

ALL LABOR, MATERIALS, AND CONSTRUCTION SHALL COMPLY WITH ALL RULES, REGULATIONS, CODES, AND LOCAL AUTHORITIES HAVING JURISDICTION OVER THE WORK DESIGN CRITERIA:

BUILDING CODE OF NEW YORK STATE (2020) RESIDENTIAL CODE OF NEW YORK STATE (2020) EXISTING BUILDING CODE OF NEW YORK STATE (2020) NFPA 70: NATIONAL ELECTRIC CODE (NEC) 2017 PLUMBING CODE OF NEW YORK STATE (2020) FIRE CODE OF NEW YORK STATE (2020)

FUEL GAS CODE OF NEW YORK STATE (2020) PROPERTY MAINTENANCE CODE OF NEW YORK STATE (2020) MECHANICAL CODE OF NEW YORK STATE (2020)

ENERGY CONSERVATION CONSTRUCTION CODE OF NEW YORK (2020)

WOOD FRAME CONSTRUCTION MANUEL FOR ONE-AND TWO FAMILY DWELLINGS (2018)

ALL LUMBER TO BE AMERICAN STANDARD SIZES. ALL STRUCTURAL * DOUGLAS FIR-LARCH LUMBER #2.

A MINIMUM OF ONE 5/8" ANCHOR BOLT SHALL BE PROVIDED WITHIN 6" - 12" OF EACH END PLATE, AND HAVE A MINIMUM EMBEDMENT OF 7" IN CONC. FOUNDATIONS AND SLABS ON GRADE OR 7" IN MASONRY BLOCK FOUNDATIONS WHEN RESISTING LATERAL AND SHEAR LOADS ONLY. ALSO 3" SQUARE WASHERS SHALL BE USED ON ALL ANCHOR BOLTS WITH THE ANCHOR BOLTS SPACING NOT TO EXCEED THE REQUIREMENTS SPECIFIED IN TABLE TABLE 3.2C. (WFCM 2018, SECTION 3.2.1.7 AND TABLE 3.2B AND 3.2C)

LUMBER TO BE GRADE MARKED PRIOR TO DELIVERY TO SITE, SUBJECT TO INSPECTION.

DOUBLE STUDS AT ALL OPENINGS IN THE EXTERIOR AND BEARINGS WALLS, DOUBLE ALL JOISTS, HEADERS AND TRIMMERS AROUND ALL OPENINGS AND UNDER ALL PARTITIONS. USE TECO HANGERS OR CONNECTORS WHERE REQUIRED (OR APPROVED EQUAL).

ALL HEADERS TO BE MIN. (2) 2 X 10 UNLESS OTHERWISE NOTED.

ALL GLAZING SHALL BE INSULATED, HIGH-PERFORMANCE GLASS (UO=.33), UNLESS OTHERWISE NOTED. PROVIDE MIN. 1" X 2 1/2" (ACTUAL SIZE) MITERED CROSS BRIDGING MAX. 8'-O" O.C. FOR FLOOR JOINTS OR EQUIVALENT METAL BRIDGING.

ALL INTERIOR PARTITIONS TO BE 2 X 4 WOOD STUDS, @ 16" O.C. WITH GYPSUM BOARD BOTH SIDES. DOUBLE-UP FLOOR JOISTS UNDER PARTITIONS RUNNING PARALLEL.

GYPSUM BOARD TO BE 1/2" TAPERED EDGE "SHEET ROCK", TAPED AND SPACKLED (3 COATS), OR EQUAL, UNLESS OTHERWISE NOTED ON DRAWINGS.

PROVIDE FLASHING AT ALL ROOF, WALL, OR OTHER INTERSECTIONS, OVER HEADS OF ALL OPENINGS AND UNDER SILLS OF ALL WINDOWS AND DOORS, CAULK ALL JOINTS EXPOSED TO WEATHER.

ROOF COVERING SHALL BE CLASSIFIED AS TYPE A OR B.

ALL STRUCTURAL STEEL SHALL BE MIN. 36,000 PSI.

ALL ELECTRICAL WORK SHALL BE PERFORMED BY A LICENSED ELECTRICIAN AND INSPECTED BY THE BOARD OF FIRE UNDERWRITERS AS PER THE NEC.

SINGLE STATION SMOKE & CARBON MONOXIDE DETECTING DEVICE TO BE INSTALLED ADJACENT TO SLEEPING AREAS ON EACH FLOOR LEVEL AND SHALL BE LOCATED ON OR NEAR CEILING.

ALL PLUMBING TO BE INSTALLED BY A LICENSED PLUMBER IN ACCORDANCE WITH THE APPLICABLE RESIDENTIAL CODE OF NEW YORK STATE, PLUMBING CODE OF NEW YORK STATE. (2020)

CURBS, CURB CUTS, AND PAVING MUST CONFORM WITH ALL REGULATIONS AND REQUIREMENTS OF THE DEPARTMENT OF PUBLIC

DRAWING	LEGEND
SYMBOL	DESCRIPTION
	EXISTING PARTITION TO REMAIN
	EXISTING ABOVE / BEYOND
	EXISTING WINDOW TO REMAIN
	EXISTING DOOR TO REMAIN
EXISTING (3) 2 x 10	EXISTING HEADER - SIZE AS SPECIFIED
	EXISTING WALL / WINDOW / DOOR TO BE DEMOLISHED
	PROPOSED PARTITION
TW2046 (2) 2 x 8	PROPOSED WINDOWS - SIZE AS SPECIFIED
N. O.	PROPOSED DOOR - SIZE AS SPECIFIED
(2) $1\frac{3}{4}$ " x $11\frac{7}{8}$ " LVL	PROPOSED HEADER - SIZE AS SPECIFIED
	PROPOSED FOUNDATION WALL
XXXXXXXXXXXXXXXXXXXXXXXXXXXXXXXXXXXXXX	INSULATION - TYPE AS SPECIFIED
	PROPOSED CLOSET
\oplus	COMBINATION SMOKE AND CARBON MONOXIDE DETECTOR
Θ	SMOKE DETECTOR

ZONING / TOWN CODE COMPLIANCE

MINIMUM WIDTH OF CONCRETE OR MASONRY FOOTINGS (INCHES)

DISAPPROVED - Make correctio. PAS-BEAR NG VALUE OF SOIL 8" SOLID CONCRETE OR MASONRY, OR FULLY (PSF) GROVERS MARKED and resubmi 1,500 2,000 3,000 ²4,000 ¹ Anthony Raguseo

05/07/2002ER401.4.1

PRESUMPTIVE LOAD-BEARING VALUES OF FOUNDATION MATERIALS

CLAYEY SILT, SILT AND SANDY SILT (CI,	(POUNDS PER SQUARE	(POUNDS PER SQUARE FOOT)								
CLAY, SANDY CLAY, SILTY CLAY, CLAYEY SILT, SILT AND SANDY SILT (CI, ML, MH and CH)	1,500		R	E						

TABLE R402.2 MINIMUM SPECIFIED COMPRESSIVE STRENGTH OF CONCRETE

	MIN. SPECIFIED COMPRESSIVE STRENGTH OF CONC. (f_c)								
TYPE OR LOCATIONS OF CONCRETE CONSTRUCTION	WEATHERING POTENTIAL (SEE TABLE 301.2(1)								
	NEGLIGIBLE	MODERATE	SEVERE						
BASEMENT WALLS, FOUNDATIONS & OTHER CONCRETE NOT EXPOSED TO THE WEATHER	×	×	2,500 ^c						
BASEMENT (CELLAR) SLABS AND INTERIOR SLABS ON GRADE, EXCEPT GARAGE FLOOR SLAB	×	×	2,500 [°]						
BASEMENT WALLS, FOUNDATION WALLS, EXTERIOR WALLS AND OTHER VERTICAL CONC. WORK EXPOSED TO THE WEATHER	×	×	3,000 ^d						
PORCHES, CARPORT SLABS AND STEPS EXPOSED TO THE WEATHER, AND GARAGE FLOOR SLABS	×	×	3,500 ^{d,e}						

FOR SI: 1 POUND PER SQUARE INCH = 6.895 kPa.

(a) AT 28 DAYS PSI

(b) SEE TABLE R301.2(1) FOR WEATHERING POTENTIAL

(c) CONC. IN THESE LOCATIONS THAT MAY BE SUBJECT TO FREEZING AND THAWING DURING CONSTRUCTION SHALL BE AIR-ENTRAINED CONCRETE IN ACCORDANCE WITH FOOTNOTE (d)

(d) CONCRETE SHALL BE AIR-ENTRAINED. TOTAL AIR CONTENT (PERCENT BY VOLUME OF CONCRETE) SHALL NOT BE LESS THAN 5% OR MORE THAN 7%

(e) SEE SECTION R402.2 FOR MINIMUM CEMENT CONTENT

TABLE 3.2B (WFCM 2018) BOTTOM PLATE TO FOUNDATION CONNECTIONS (ANCHOR BOLTS) RESISTING LATERAL & SHEAR LOADS FOR EXPOSURES B & C AND

FROM W	IND-EXPOSURE B	ALL WIND SPEEDS						
BOTTOM PLATE TO FOUNDATION ANCHOR BOLT CONNECTION RESISTING	FOUNDATION SUPPORTING	MAXIMUM ANCHOR BOLT SPACING (in.) 12.3.4						
LATERAL AND SHEAR LOADS	1 - 3 STORIES	1/2" ANCHOR BOL	TS 31					
LATERAL AND SHEAR LOADS	1 - 3 STORIES	5/8" ANCHOR BOL	TS 48					

"PRESCRIPTIVE LIMITS ARE BASED ON ASSUMPTIONS IN TABLE 3.2

WHEN ANCHOR BOLTS ARE USED TO RESIST UPLIFT, LATERAL, AND SHEAR LOADS, THE MAXIMUM ANCHOR BOLT SPACING SHALL NOT EXCEED THE LESSER OF THE TABULATED VALUES FOR UPLIFT LOADS (TABLE 3.2C) OR LATERAL AND SHEAR LOADS (TABLE 3.2B) FOR OTHER ANCHOR BOLT LIMITATIONS SEE SECTION 3.2

TABULATED ANCHOR BOLT SPACING FOR LATERAL AND SHEAR LOADS ASSUME WALLS ARE SHEATHED IN ACCORDANCE WITH SECTION 3.4.4.2. FOR OTHER WALL SHEATHING TYPES THE TABULATED ANCHOR BOLT SPACING SHALL BE MULTIPLIED BY THE APPROPRIATE SHEATHING TYPE ADJUSTMENT FACTOR IN TABLE 3.17D, BUT IN NO CASE SHALL ANCHOR BOLT SPACING EXCEED 6 FEET ON CENTER.

FOR THREE SECOND GUST WIND SPEEDS GREATER THAN 110 MPH, WITH A TABULATED LATERAL VALUE FROM TABLE 3.5 GREATER THAN 262 plf. LATERAL CONNECTIONS SHALL BE DETERMINED USING THE LOADS FROM TABLE 3.5

TABLE 3.2C (WFCM 2018) SILL OR BOTTOM PLATE TO

FOUNDATION CONNE ANCHOR BOLTS) RESIST LOADS FROM WIND-EXI	PLIFT GUS	GUST WIND SPEED (MPH)		95	100	105	110	115	120	130	140	150	160	170	180	195	
BOTTOM PLATE TO FOUNDATION ANCHOR BOLT CONNECTION RESISTING PLATE SIZE			OUNDATION JPPORTING	MAXIMUM ANCHOR BOLT SPACING				(in.) ^{1,2}) 1,2								
	2 x 4	1 - 3 STORIES	8 'END ZONES	72	72	72	72	72	72	71	57	43	35	30	27	24	22
UPLIFT LOADS		1 - 3 STORIES	INTERIOR ZONES	72	72	72	72	72	72	72	66	50	41	35	31	28	26
OFLIFT LOADS	2 6	1 - 3 STORIES	8 'END ZONES	72	72	72	72	72	72	72	68	51	42	36	32	29	26
	2 x 6	1 - 3 STORIES	INTERIOR ZONES	72	72	72	72	72	72	72	72	60	49	42	37	34	31

"PRESCRIPTIVE LIMITS ARE BASED ON ASSUMPTIONS IN TABLE 3.2

WHEN ANCHOR BOLTS ARE USED TO RESIST UPLIFT, LATRAL, AND SHEAR LOADS, THE MAXIMUM ANCHOR BOLT SPACING SHALL NOT EXCEED THE LESSER OF THE TABULATED VALUES FOR UPLIFT LOADS (TABLE 3.2C) OR LATERAL AND SHEAR LOADS (TABLE 3.2B) FOR OTHER ANCHOR

BOLT LIMITATIONS SEE SECTION 3.2.1.7 and 3.2.2.3

TABLE R703.3(1) WEATHER RESISTANT SIDING ATTACHED AND MIN. THICKNESS

SIDING MATERIAL	NOMINAL THICKNESS (INCHES)	JOINT TREATMENT	SHEATHING PAPER REQUIRED	WOOD OR WOOD STRUCTURAL PANEL SHEATHING	FIBERBOARD SHEATHING INTO STUD	GYPSUM SHEATHING INTO STUD	DIRECT TO STUDS	NUMBER OR SPACING OF FASTENERS	
/INYL SIDING*	0.035	LAP	NO	0.120 NAIL 1½" STAPLE-1¾"	0.120 NAIL 2" STAPLE-2 ¹ 2"	0.120 NAIL 2" STAPLE-2 ¹	NOT ALLOWED	SAME AS STUD SPACING	

*VINYL SIDING SHALL COMPLY WITH ASTM D3679

TABLE R702.3.5 MINIMUM THICKNESS AND APPLICATION OF GYPSUM BOARD

WINNING IT HICKINGS AND AFFLICATION OF GIFSON BOARD										
	THICKNESS OF GYPSUM BOARD	APPLICATION	ORIENTATION OF GYPSUM BOARD	MAX. SPACING OF FRAMING MEMBERS	MAX. SPACING OF FASTENERS		CILL CI ITALES I CITAL I LICATION			
	(INCHES)		TO FRAMING		NAILS	SCREWS				
	1/2	CEILING	EITHER DIRECTION	16	7	12	13 GAGE, $1\frac{3}{8}$ " LONG, $\frac{19}{64}$ " HEAD; 0.098 DIAMETER, $1\frac{1}{4}$ " LONG, ANNULAR-RINGED;5d COOLER NAIL, 0.086			
	-/-	WALL	EITHER DIRECTION	DN 16		16	DIAMETER, $1\frac{5}{8}$ " LONG, $\frac{15}{64}$ " HEAD; OR GYPSUM BOARD NAIL,0.0915 DIAMETER, $1\frac{5}{8}$ " LONG, $\frac{9}{32}$ " HEAD.			

CODE R702.3.1 RCNYS-GYPSUM BOARD

ALL GYPSUM BOARD MATERIALS AND ACCESSORIES SHALL CONFORM TO ASTM C22, C475, C514, C1002, C1047, C1177, C1178, C1278, C1396, C1658 OR C1766 AND SHALL BE INSTALLED IN ACCORDANCE WITH THE PROVISIONS OF THIS SECTION. ADHESIVES FOR THE INSTALLATION OF GYPSUM BOARD AND GYPSUM PANEL PRODUCTS SHALL CONFORM TO ASTM C557.

TABLE R301.5 ALSO NOTED SECTION R301.5 MINIMUM UNIFORMLY DISTRIBUTED LIVE LOADS

LIVE LOAD DEAD LOAD: R301.4

(IN POUNDS PER SQUARE FOOT)

		,
UNINHABITABLE ATTICS (b) WITHOUT STORAGE	10	THE ACTUAL WEIGHTS OF
UNINHABITABLE ATTICS WITH (b)(g) LIMITED STORAGE	20	MATERIALS AND CONSTRUCTION
HABITABLE ATTICS AND SERVED WITH FIXED STAIRS	30	SHALL BE USED FOR DETERMINING DEAD
EXTERIOR BALCONIES (e) AND DECKS	40	LOAD WITH CONSIDERATION FOR
FIRE ESCAPES	40	THE DEAD LOAD OF
GUARD RAILS AND HANDRAILS NO Errors, omissio GUARD RAILS IN FILE I EXAMINATION PONENTS	ns, 3000(h) er shall ^{h)} rel	
PASSENGER MEDICES DO ARAGES (4) ROOMS OTHER THAN SLEEPING	mply with	all the
SLEEPING REQUIREMENTS OF the	Town of I	North Hempstead,
STAIRS and all other applic	cable codes	s and standards

FOR SI: 1 ROUND PER SQUARE FOOT = 0.0479 kN/m, 1 SQUARE INCH = 645 mm, 1 POUND = 4.45 N^2

(a) (b) (c) (d)(e) (f) (g) (h) SEE (RCNYS 2020)

USE

UMBER SPECIFICATION:

* DESIGN LOADS TAKEN AS PER

WESTERN WOOD PRODUCTS ASSOCIATION

IN ACCORDANCE WITH ASTM STANDARDS

* DOUG - FIR LUMBER #2 WITH FB 875 OR EQUAL

- ALL HEADERS @ DOOR OPENINGS TO BE

2 x 10 UNLESS NOTED OTHERWISE

- ALL LAMINATED GIRDERS TO

- ALL LAMINATED GIRDERS ARE

CALLED OUT AS NOMINAL SIZE

- 1 3/4" x 9 1/2" FOR 2 x 10 LVL

- 1 3/4" x 11 7/8" FOR 2 x 12 LVL

WITH CONCRETE TO BE A.C.Q.

- ALL LUMBER THAT COMES IN CONTACT

FASTENERS, HANGERS AND TIE-DOWN

GALVANIZED OR STAINLESS STEEL

CONNECTORS THAT COME IN CONTACT WITH A.C.Q

TREATED LUMBER MUST BE DESIGNED FOR SUCH

USE (CHECK MANUFACTURERS SPECIFICTAIONS)

ALL FASTENERS IN DIRECT CONTACT WITH A.C.Q.

OR WOLMANIZED LUMBER MUST BE "ZMAX/HDG"

BE 2.0E G-P LAM LVL.

CONTRACTOR TO USE:

TABLE R301.7 ALLOWABLE DEFLECTION OF STRUCTURAL MEMBERS (b) (c)

STRUCTURAL MEMBER	ALLOWABLE DEFLECTION
RAFTERS HAVING SLOPES GREATER THAN 3/12 WITH FINISHED CEILING NOT ATTACHED TO RAFTERS	L/180
INTERIOR WALLS AND PARTITIONS	H/180
FLOORS	L/360
CEILINGS WITH BRITTLE FINISHES (INCLUDING PLASTER AND STUCCO)	L/360
CEILINGS WITH FLEXIBLE FINISHES (INCLUDING GYPSUM BOARD)	L/240
ALL OTHER STRUCTURAL MEMBERS	L/240
EXTERIOR WALLS - WIND LOADS WITH PLASTER OR STUCCO FINISHES	H/360
EXTERIOR WALLS - WIND LOADS ^a WITH OTHER BRITTLE FINISHES	H/240
EXTERIOR WALLS - WIND LOADS WITH FLEXIBLE FINISHES	L/120 ^d
LINTELS SUPPORTING MASONRY VENEER WALLS	L/600

(a) FOR THE PURPOSE OF THE DETERMINING DEFLECTION LIMITS HEREIN, THE WIND LOAD SHALL BE PERMITTED TO BE TAKEN AS 0.7 TIMES THE COMPONENT AND CLADDING (ASD) LOADS OBTAINED FROM TABLE R301.2(2)

FOR CANTILEVER MEMBERS, L SHALL BE TAKEN AS TWICE THE LENGTH OF THE CANTILVER FOR ALUMINUM STRUCTURAL MEMBERS OR PANELS USED IN ROOFS OR WALLS OF SUNROOM ADDITIONS OR PATIO COVERS, NOT SUPPORTING EDGE OF GLASS, THE TOTAL LOAD DEFLECTION SHALL NOT EXCEED L/175 FOR EACH GLASS LITE OR L/60 FOR THE ENTIRE LENGTH OF THE MEMBER, WHICHEVER IS MORE STRINGENT, FOR SANDWICH PANELS USED IN ROOFS OR WALLS OF

SUNROOM ADDITIONS OR PATIO COVERS, THE TOAL LOAD DEFLECTION SHALL NOT EXCEED L/120 DEFLECTION FOR EXTERIOR WALLS WITH INTERIOR GYPSUM BOARD FINISH SHALL BE LIMITED TO AN

ALLOWABLE DEFLECTION OF H/180 REFER TO SECTION R703.8.2

SECTION R301.2.2.2 WEIGHTS OF MATERIALS

2		
USE	DEAD LOAD	
EXTERIOR LIGHT FRAME WOOD WALLS	15 psf	
EXTERIOR LIGHT FRAME COLD-FORMED STEEL WALLS	14 psf	
INTERIOR LIGHT FRAME WOOD WALLS	10 psf	
INTERIOR LIGHT FRAME COLD-FORMED STEEL WALLS	5 psf	
8" THICK MASONRY WALLS	80 psf	
6" THICK CONCRETE WALLS	85 psf	
SIP WALLS	10 psf	

EXCEPTIONS:

1) ROOF AND CEILING DEAD LOADS NOT EXCEEDING 25 psf SHALL BE PERMITTED PROVIDED THE WALL BRACING AMOUNTS IN SECTION R602.10.3 ARE INCREASED IN ACCORDANCE WITH TABLE R602.10.3(4)

2) LIGHT-FRAME WALLS WITH STONE OR MASONRY VENEER SHALL BE PERMITTED IN ACCORDANCE WITH THE PROVISIONS OF SECTIONS R702.1 AND R703

3) FIREPLACES AND CHIMNEYS SHALL BE PERMITTED IN ACCORDANCE WITH CHAPTER 10

TABLE R301.2.1.3 EQUIVALENT BASIC WIND SPEEDS

V	ULT	110	115	120	130	140	150	160	170	180	190	200
V	ASD	85	89	93	101	108	116	124	132	139	147	155

ALL DIMENSIONS ARE TO BE FIELD VERIFIED

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ISSUED FOR PRELIMINARY DRAWING FOR OWNERS REVIEW FOR BIDDING PURPOSES FOR BUILDING DEPT. FOR CONSTRUCTION AS BUILT DRAWINGS

REV	ISIONS	PLOTTED: 3/15/2024
NO.	DATE	DESCRIPTION
	02/14/23	CABINET LAYOUT UPDATI
	01/16/24	D.O.B. RESBMISSION
	01/23/24	D.O.B. RESBMISSION
	03/14/24	D.O.B. RESBMISSION

2022220 PROJECT NO. 03/14/24 AS NOTED SCALE DRAWN BY M.Z. - S.D. - S.V.



DRAWING:

GENERAL NOTES

PROJECT:


RESIDENCE

3 TWELFTH STREET CARLE PLACE, NY 11514


D.O.B. I.D#

DISAPPROVED WINMARKEN CONTRECTIONS as noted and resubmit Neoprene gasket or sealant continuous around light fixture Exterior light fixture Neoprene gasket or sealant continuous around pipe penetrations Exterior faucet

RECESSED LIGHTING

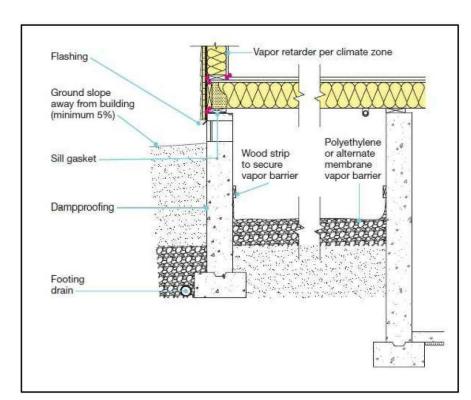


EXTERIOR WALL

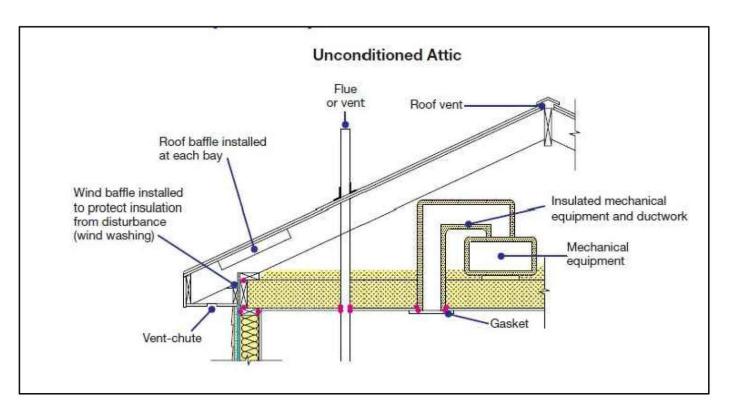

VENTED ATTIC SPACE

VENTED CRAWL SPACE

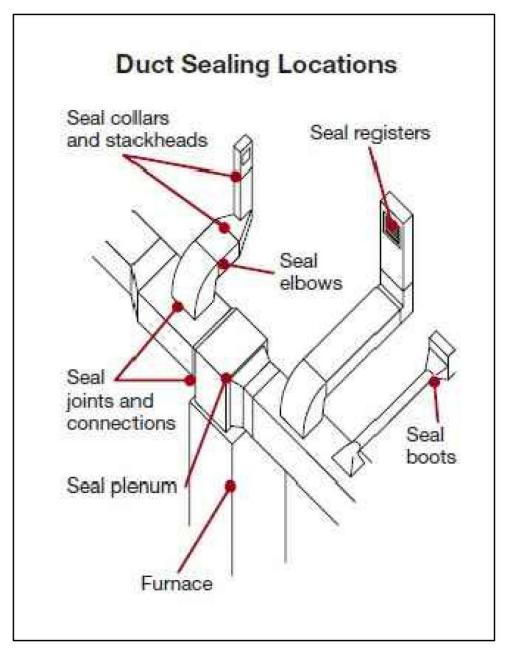

HVAC EQUIPMENT BY OTHERS

(RCNYS 2020) R303 - LIGHT, VENTILATION R303.10 REQUIRED HEATING IN TABLE R301.2(1) IS BELOW 60°F (16°C) EVERY DWELLING UNIT INTENDED TO BE OCCUPIED BETWEEN SEPTEMBER 15 AND MAY 15 SHALL BE PROVIDED WITH HEATING FACILITIES CAPABLE OF MAINTAINING A ROOM TEMPERATURE OF NOT LESS THAN 68°F (20°C) AT A POINT 3 FEET (914 mm) ABOVE THE FLOOR AT 2 FEET (610 mm) FROM EXTERIOR WALLS IN HABITABLE ROOMS AT THE DESIGN TEMPERATURE. TH INSTALLATION OF ONE OR MORE PORTABLE

SPACE HEATERS SHALL NOT BE USED TO ACHIEVE COMPLIANCE WITH THIS SECTION EXCEPTIONS: OWNER-OCCUPIED ONE-FAMILY DWELLINGS SUBJECT TO THE APPROVAL OF THE BUILDING OFFICIAL. 762 mm), AND LARGE ENOUGH TO ALLOW

M1305.1.2 APPLIANCES IN ATTICS. PROVIDED WITH AN OPENING AND A CLEAR AND UNOBSTRUCTED PASSAGEWAY LARGE ENOUGH TO ALLOW REMOVAL OF THE LARGEST APPLIANCE, BUT NOT LESS THAN 30 INCHES (762 mm) HIGH AND 22 INCHES (559 mm) WIDE AND NOT MORE THAN 20 FEET (6096 mm) LONG MEASURED ALONG THE CENTERLINE OF THE APPLIANCE. THE PASSAGEWAY SHALL HAVE CONTINUOUS SOLID FLOORING IN ACCORDANCE WITH CHAPTER 5 NOT LESS THAN 24 INCHES (610 mm) WIDE. A LEVEL SERVICE SPACE NOT LESS THAN 30 INCHES (762 mm) DEEP AND 30 INCHES (762 mm) WIDE SHALL BE PRESENT ALONG ALL SIDES OF THE APPLIANCE WHERE ACCESS IS REQUIRED. THE CLEAR ACCESS OPENING DIMENSIONS SHALL BE NOT LESS THAN 20 INCHES BY 30 INCHES (508 mm BY

REMOVAL OF THE LARGEST APPLIANCE.

DUCT SEALING

[NY] C106.2.6.1 HVAC System certification.

A registered design professional shall provide to the building official a written certification that (1) all required HVAC system inspections, HVAC system calibrations, and overall HVAC equipment functionality tests have been performed and (2) in the professional opinion of the registered design professional, the HVAC system is operating as designed. The registered design professional shall retain copies of the inspection, calibration, and test reports, and shall provide such reports to the building official, if requested. In the case of a building that is subject to the New York City Construction Codes, all required HVAC system inspections, HVAC system calibrations, and overall HVAC equipment functionality tests shall be special or progress inspections and shall be performed by approved agencies.

Supply and return ducts in attics shall be insulated to an R-value of not less than R-8 for ducts 3 inches (76 mm) in diameter and larger and not less than R-6 for ducts smaller than 3 inches (76 mm) in diameter. Supply and return ducts in other portions of the building shall be insulated to not less than R-6 for ducts 3 inches (76 mm) in diameter and to not less than R-4.2 for ducts smaller than 3 inches (76.2 mm) in diameter.

The thermostat controlling the primary heating or cooling system of the dwelling unit shall be capable of controlling the heating and cooling system Paragraphical and the comparation of the properties of the day. This thermostat shall include the capability to set back

be programmed hitially by the manufacturer with a heating temperature setpoint of not greater than 70°F (21°C) and a cooling temperature setpoint of not less than 78°F (26°C).

ystem to maintain z*one* temperatures of not less than 55°F (13°C) to not greater than 85°F (29°C). The thermostat shall

Exception: Ducts or portions thereof located completely inside the building thermal envelope

Ducts and air handlers shall be installed in accordance with Sections N1103.3.1 through N1103.3.8.

[NY] N1103.3.2 (R403.3.2) Sealing (Mandatory).

N1103.3.1 (R403.3.1) Insulation (Prescriptive).

Heat pumps having supplementary electric-re

Hot water boilers that supply heat to the building

poiler water temperature based on the outdoor temper

Ducts, air handlers and filter boxes shall be sealed. Joints and seams shall comply with Section M1601.4.1.

when the heat pump compressor can meet the heating load.

N1103.3 (R403.3) Ducts.

- Air-impermeable spray foam products shall be permitted to be applied without additional joint seals.
- 2. For ducts having a static pressure classification of less than 2 inches of water column (500 Pa), additional closure systems shall not be required for continuously welded joints and seams, and locking-type joints and seams of other than the snap-lock and button-lock types.

N1103.3.2.1 (R403.3.2.1) Sealed air handler.

Air handlers shall have a manufacturer's designation for an air leakage of not greater than 2 percent of the design airflow rate when tested in accordance with ASHRAE 193.

N1103.3.3 (R403.3.3) Duct testing (Mandatory).

Ducts shall be pressure tested to determine air leakage by one of the following methods:

- 1. Rough-in test: Total leakage shall be measured with a pressure differential of 0.1 inch w.g. (25 Pa) across the system, including the manufacturer's air handler enclosure if installed at the time of the test. Registers shall be taped or otherwise sealed during the test.
- 2. Postconstruction test: Total leakage shall be measured with a pressure differential of 0.1 inch w.g. (25 Pa) across the entire system, including the manufacturer's air handler enclosure. Registers shall be taped or otherwise sealed during the test.

1. A duct air-leakage test shall not be required where the ducts and air handlers are located entirely within the building thermal envelope. 2. A duct air-leakage test shall not be required for ducts serving heat or energy recovery ventilators that are not integrated with ducts

A written report of the results of the test shall be signed by the party conducting the test and provided to the building official.

N1103.3.4 (R403.3.4) Duct leakage (Prescriptive).

he total leakage of the ducts, where measured in accordance with Section R403.3.3, shall be as follows:

- 1. Rough-in test: The total leakage shall be less than or equal to 4 cubic feet per minute (113.3 L/min) per 100 square feet (9.29 m²) of conditioned floor area where the air handler is installed at the time of the test. Where the air handler is not installed at the time of the test, the total leakage shall be less than or equal to 3 cubic feet per minute (85 L/min) per 100 square feet (9.29 m²) of conditioned floor area. 2. Postconstruction test: Total leakage shall be less than or equal to 4 cubic feet per minute (113.3 L/min) per 100 square feet (9.29 m²) of
- N1103.3.5 (R403.3.5) Building cavities (Mandatory).

conditioned floor area.

Building framing cavities shall not be used as ducts or plenums

[NY] N1103.3.6 (R403.3.6) Ducts buried within ceiling insulation.

- Where supply and return air ducts are partially or completely buried in ceiling insulation, such ducts shall comply with all of the following:
- 1. The supply and return duct shall have an insulation R-value not less than R-8.
- 2. At all points along each duct, the sum of the ceiling insulation R-values against and above the top of the duct, and against and below the bottom of the duct shall be not less than R-19, excluding the R-value of the duct insulation.

N1103.3.6.1 (R403.3.6.1) Effective R-value of deeply buried ducts.

Where using a simulated energy performance analysis, sections of ducts that are installed in accordance with Section N1103.3.6, located directly on, or within 5.5 inches (140 mm) of the ceiling, surrounded with blown-in attic insulation having an R-value of R-30 or greater and located such that the top of the duct is not less than 3.5 inches (89 mm) below the top of the insulation, shall be considered as having an effective duct insulation R-value of R-25.

N1103.3.7 (R403.3.7) Ducts located in conditioned space.

- For ducts to be considered as inside a conditioned space, such ducts shall comply with either of the following: 1. The duct system is located completely within the continuous air barrier and within the building thermal envelope.
- 2. The ducts are buried within ceiling insulation in accordance with Section N1103.3.6 and all of the following conditions exist:
- 2.1. The air handler is located completely within the continuous air barrier and within the building thermal envelope.
- 2.2. The duct leakage, as measured either by a rough-in test of the ducts or a post-construction total system leakage test to outside the building thermal envelope in accordance with Section N1103.3.4, is less than or equal to 1.5 cubic feet per minute (42.5 L/min) per 100 square feet (9.29 m²) of conditioned floor area served by the duct system.
- 2.3. The ceiling insulation R-value installed against and above the insulated duct is greater than or equal to the proposed ceiling insulation R-value, less the R-value of the insulation on the duct.

N1103.4 (R403.4) Mechanical system piping insulation (Mandatory).

Mechanical system piping capable of carrying fluids greater than 105°F (41°C) or less than 55°F (13°C) shall be insulated to an R-value of not less than

N1103.4.1 (R403.4.1) Protection of piping insulation.

Piping insulation exposed to weather shall be protected from damage, including that caused by sunlight, moisture, equipment maintenance and wind. The protection shall provide shielding from solar radiation that can cause degradation of the material. Adhesive tape shall be prohibited.

N1103.5 (R403.5) Service hot water systems.

Energy conservation measures for service hot water systems shall be in accordance with Sections N1103.5.1 through N1103.5.4.

N1103.5.1 (R403.5.1) Heated water circulation and temperature maintenance systems (Mandatory).

Heated water circulation systems shall be in accordance with Section N1103.5.1.1. Heat trace temperature maintenance systems shall be in accordance with Section N1103.5.1.2. Automatic controls, temperature sensors and pumps shall be accessible. Manual controls shall be readily accessible.

COMPONENT	AIR BARRIER CRITERIA	INSULATION INSTALLATION CRITERIA
General requirements	A continuous air barrier shall be installed in the building envelope. The exterior thermal envelope contains a continuous air barrier. Breaks or joints in the air barrier shall be sealed.	Air-permeable insulation shall not be used as a sealing material.
Ceiling/attic	The air barrier in any dropped ceiling or soffit shall be aligned with the insulation and any gaps in the air barrier shall be sealed. Access openings, drop down stairs or knee wall doors to unconditioned attic spaces shall be sealed.	The insulation in any dropped ceiling/soffit shall be aligned with the air barrier.
Walls	The junction of the foundation and sill plate shall be sealed. The junction of the top plate and the top of exterior walls shall be sealed. Knee walls shall be sealed.	Cavities within corners and headers of frame walls shall be insulated by completely filling the cavity with a material having a thermal resistance, R-value, of not less than R-3 per inch. Exterior thermal envelope insulation for framed walls shall be installed in substantial contact and continuous alignment with the air barrier.
Windows, stalights and doors	The space between framing and skylights, and the jambs of windows and doors, shall be sealed.	
Rim joists	Rim joists shall include the DaRerrors, omiss	anjosus shallbe as waer sight on the
floors and floors above garages	The air barrier shall be installed at any exposed edge of	maintain greati/ insure or explores along of maintain permanent contact with the underside of sulfing decking a farmative life of thing cavity insulation shall be in contact with the top side of the latting or convincional attending to the underside of floor framing and shall extend from the bottom to the top of all perimeter floor
Crawl space walls		Grawling members of North Hemps Grawl space insulation, where provided instead of floor disulation, shall be provided instead of the walls.
Shafts, penetrations	Duct sharts, utility penetrations, and flue shafts opening to exterior or unconditioned space shall be sealed.	aving authority over the
Narrow cavities		Batts to be installed in narrow cavities shall be cut to fit or narrow cavities shall be filled with insulation that on installation readily conforms to the available cavity space
Garage separation	Air sealing shall be provided between the garage and conditioned spaces.	=
Recessed lighting	Recessed light fixtures installed in the <i>building thermal envelope</i> shall be sealed to the finished surface.	Recessed light fixtures installed in the building thermal envelope shall be air tight and IC rated.
Plumbing and wiring	_	In exterior walls, batt insulation shall be cut neatly to fit around wiring and plumbing, or insulation, that on installation readily conforms to available space, shall extend behind piping and wiring.
Shower/tub on exterior wall	The air barrier installed at exterior walls adjacent to showers and tubs shall separate the wall from the shower or tub.	Exterior walls adjacent to showers and tubs shall be insulated.
Electrical/phone box on exterior walls	The air barrier shall be installed behind electrical and communication boxes. Alternatively, air-sealed boxes shall be installed.	_
HVAC register boots	HVAC supply and return register boots that penetrate building thermal envelope shall be sealed to the subfloor, wall covering or ceiling penetrated by the boot.	_
Concealed sprinklers	Where required to be sealed, concealed fire sprinklers shall only be sealed in a manner that is recommended by the manufacturer. Caulking or other adhesive sealants shall not be used to fill voids between fire sprinkler cover plates and walls or ceilings.	_

R403.7 Equipment sizing and efficiency rating (Mandatory).

eating and cooling equipment shall be sized in accordance with ACCA Manual S based on building loads calculated in accordance with ACCA fanual J or other approved heating and cooling calculation methodologies. New or replacement heating and cooling equipment shall have an fficiency rating equal to or greater than the minimum required by federal law for the geographic location where the equipment is installed.

EQUIVALENT U-FACTORS

CLIMATE	FENESTRATION U-FACTOR	SKYLIGHT U-FACTOR	CEILING U-FACTOR	FRAME WALL U-FACTOR	MASS WALL U-FACTOR ^b	FLOOR U-FACTOR	BASEMENT WALL U-FACTOR	CRAWL SPACE WALL U-FACTOR
4	0.32	0.55	0.026	0.060	0.098	0.047	0.059	0.065
5	0.30	0.55	0.026	0.060	0.082	0.033	0.050	0.055
3	0.30	0.55	0.026	0.045	0.060	0.033	0.050	0.055

a. Nonfenestration U-factors shall be obtained from measurement, calculation or an approved source b. Mass walls shall be in accordance with Section R402.2.5. Where more than half the insulation is on the interior, the mass wall U-factors shall not exceed 0.087 in Climate Zone 4 except Marine, 0.065 in

SECTION N1102 (R402) **BUILDING THERMAL ENVELOPE**

[NY] N1102.1 (R402.1) General (Prescriptive).

The building thermal envelope shall comply with the requirements of Sections N1102.1.1 through N1102.1.5.

c. In warm-humid locations as defined by Figure R301.1 and Table R301.1, the basement wall U-factor shall not exceed 0.36

- 1. The following low-energy buildings, or portions thereof, separated from the remainder of the building by building thermal envelope assemblies complying with this section shall be exempt from the building thermal envelope provisions of Sections N1102.1.1 through
- 1.1. Those with a peak design rate of energy usage less than 3.4 Btu/h ft² (10.7 W/m²) or 1.0 watt/ft² of floor area for space-conditioning
- 1.2. Those that do not contain conditioned space. Log homes designed in accordance with ICC 400.

N1102.1.1 (R402.1.1) Vapor retarder.

Wall assemblies in the building thermal envelope shall comply with the vapor retarder requirements of Section R702.7.

[NY] N1102.1.2 (R402.1.2) Insulation and fenestration criteria.

The building thermal envelope shall meet the requirements of Table N1102.1.2 based on the climate zone specified in Section N1101.7. In Climate Zone 6, the building thermal envelope shall meet either the requirements of the Climate Zone 6 "option 1" row in Table N1102.1.2 or the requirements of the Climate Zone 6 "option 2" row in Table N1102.1.2.

[NY] TABLE N1102.1.2 (R402.1.2) INSULATION AND FENESTRATION REQUIREMENTS BY COMPONENT

CLIMATE ZONE	FENESTRATION U-FACTOR ^b	SKYLIGHT ^b U-FACTOR	GLAZED FENESTRATION SHGC ^{b, e}	CEILING R-VALUE	WOOD FRAME WALL R-VALUE	MASS WALL R-VALUE	FLOOR R-VALUE	BASEMENT ^C WALL R-VALUE	SLAB ^d R-VALUE & DEPTH	SPACE ^C WALL R-VALUE
1	NR	0.75	0.25	30	13	3/4	13	0	0	0
2	0.40	0.65	0.25	38	13	4/6	13	0	0	0
3	0.32	0.55	0.25	38	20 or 13 + 5 ^h	8/13	19	5/13 ^f	0	5/13
4 except Marine	0.32	0.55 ROVIDING	0.40 RESCHECK I	49 N LIEU (20 or 13 + 5 ^h OF THE PRESC	8/13 RIPTIVE	19 METHO	10/13 D	10, 2 ft	10/13
5 and Marine 4	0.30	0.55	NR	49	20 or 13 + 5 ^h	13/17	30 ^g	15/19	10, 2 ft	15/19
6	0.30	0.55	NR	49	20 + 5 ^h or 13 + 10 ^h	15/20	309	15/19	10, 4 ft	15/19
7 and 8	0.30	0.55	NR	49	20 + 5 ^h or 13 + 10 ^h	19/21	389	15/19	10, 4 ft	15/19

NR = Not Required.

- be not less than the R-value specified in the table. b. The fenestration U-factor column excludes skylights. The SHGC column applies to all glazed fenestration c. "10/13" means R-10 continuous insulation on the interior or exterior of the home or R-13 cavity insulation on the interior of the basement wall. "15/19" means R-15 continuous insulation on the interior or exterior
- of the home or R-19 cavity insulation on the interior of the basement wall. Alternatively, compliance with "15/19" shall be R-13 cavity insulation on the interior of the basement wall plus R-5 continu on the interior or exterior of the home
- d. R-5 insulation shall be provided under the full slab area of a heated slab in addition to the required slab edge insulation R-value for slabs, as indicated in the table. The slab edge insulation for heated slabs
- g. Alternatively, insulation sufficient to fill the framing cavity providing not less than an R-value of R-19. h. The first value is cavity insulation, the second value is continuous insulation. Therefore, as an example, "13+5" means R-13 cavity insulation plus R-5 continuous insulation Mass walls shall be in accordance with Section N1102.2.5. The second R-value applies where more than half of the insulation is on the interior of the mass wall.

D.O.B. I.D#

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ISSUED FOR PRELIMINARY DRAWING FOR OWNERS REVIEW FOR BIDDING PURPOSES FOR BUILDING DEPT. FOR CONSTRUCTION AS BUILT DRAWINGS REVISIONS

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an architect is altered, the altering


otation "altered by" followed by his

ALL DIMENSIONS AR TO BE FIELD VERIFIED

PLOTTED: 3/15/2024 NO. DATE DESCRIPTION 02/14/23 | CABINET LAYOUT UPDAT 01/16/24 D.O.B. RESBMISSION 01/23/24 D.O.B. RESBMISSION 03/14/24 D.O.B. RESBMISSION

2022220 PROJECT NO. AS NOTED DRAWN BY M.Z. - S.D. - S.V.



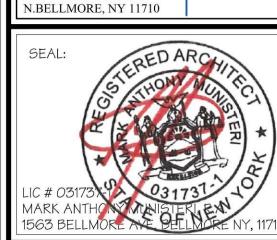



DRAWING:

ECCCNYS NOTES

RESIDENCE

3 TWELFTH STREET CARLE PLACE, NY 11514

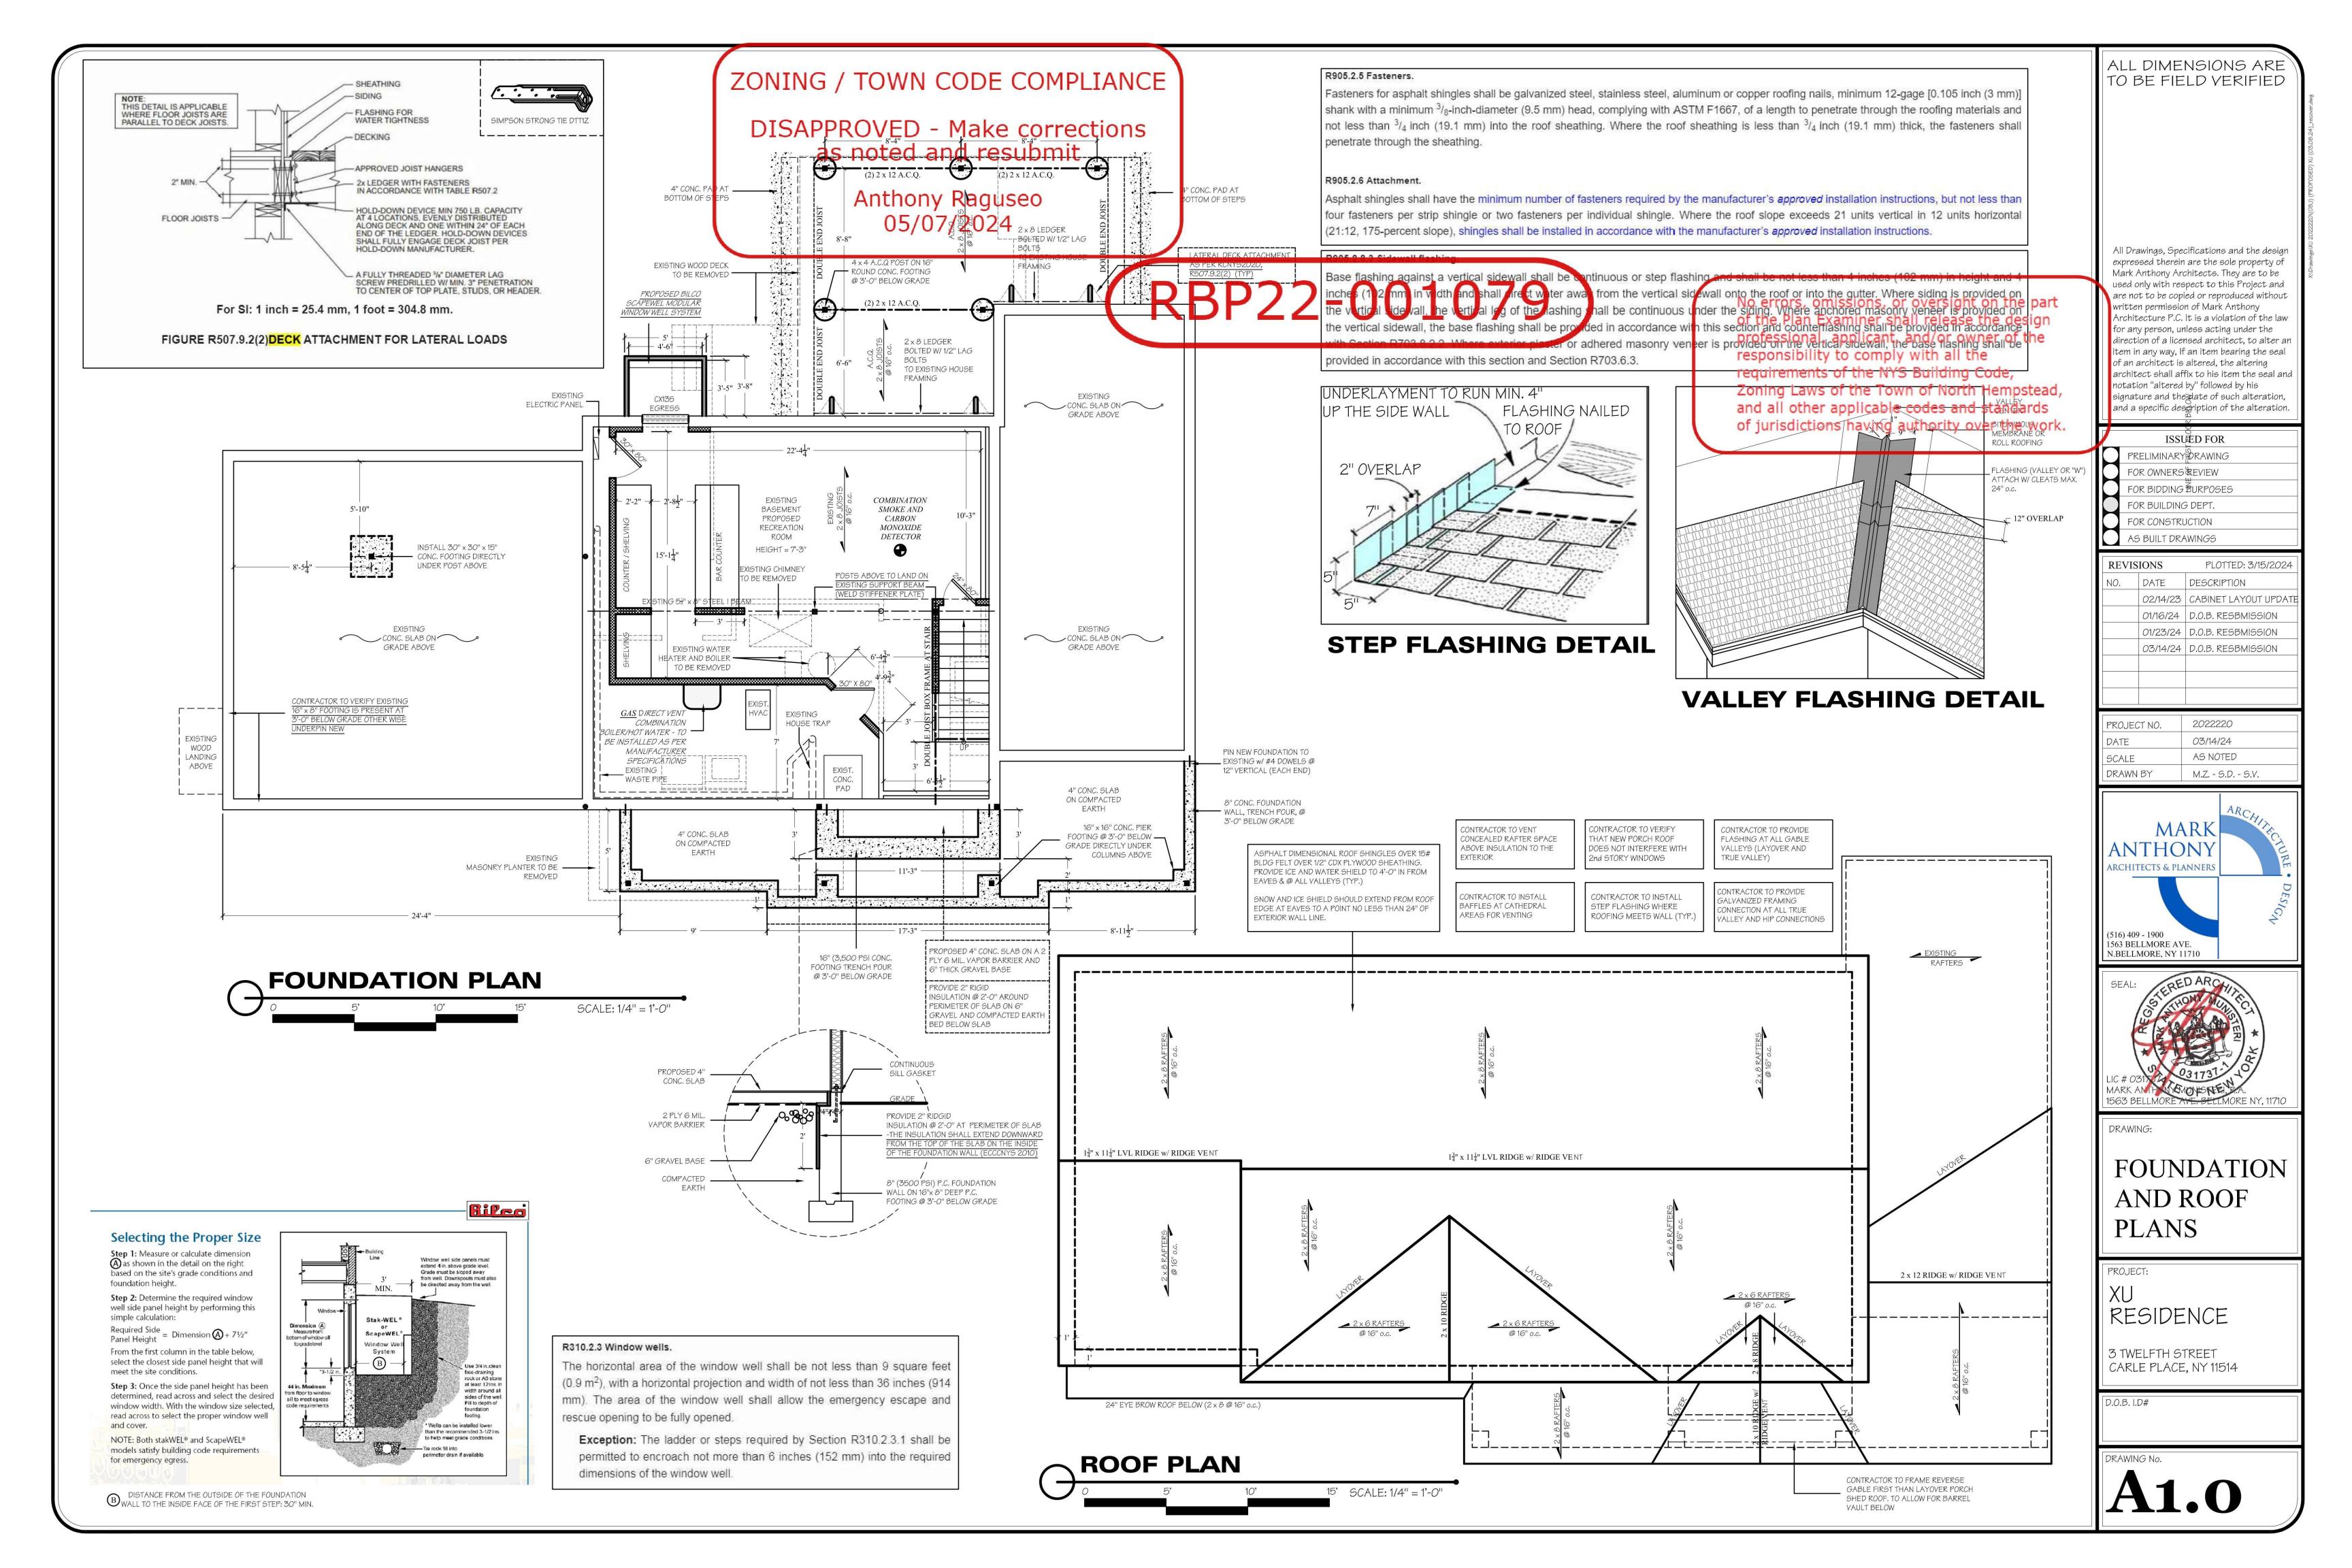

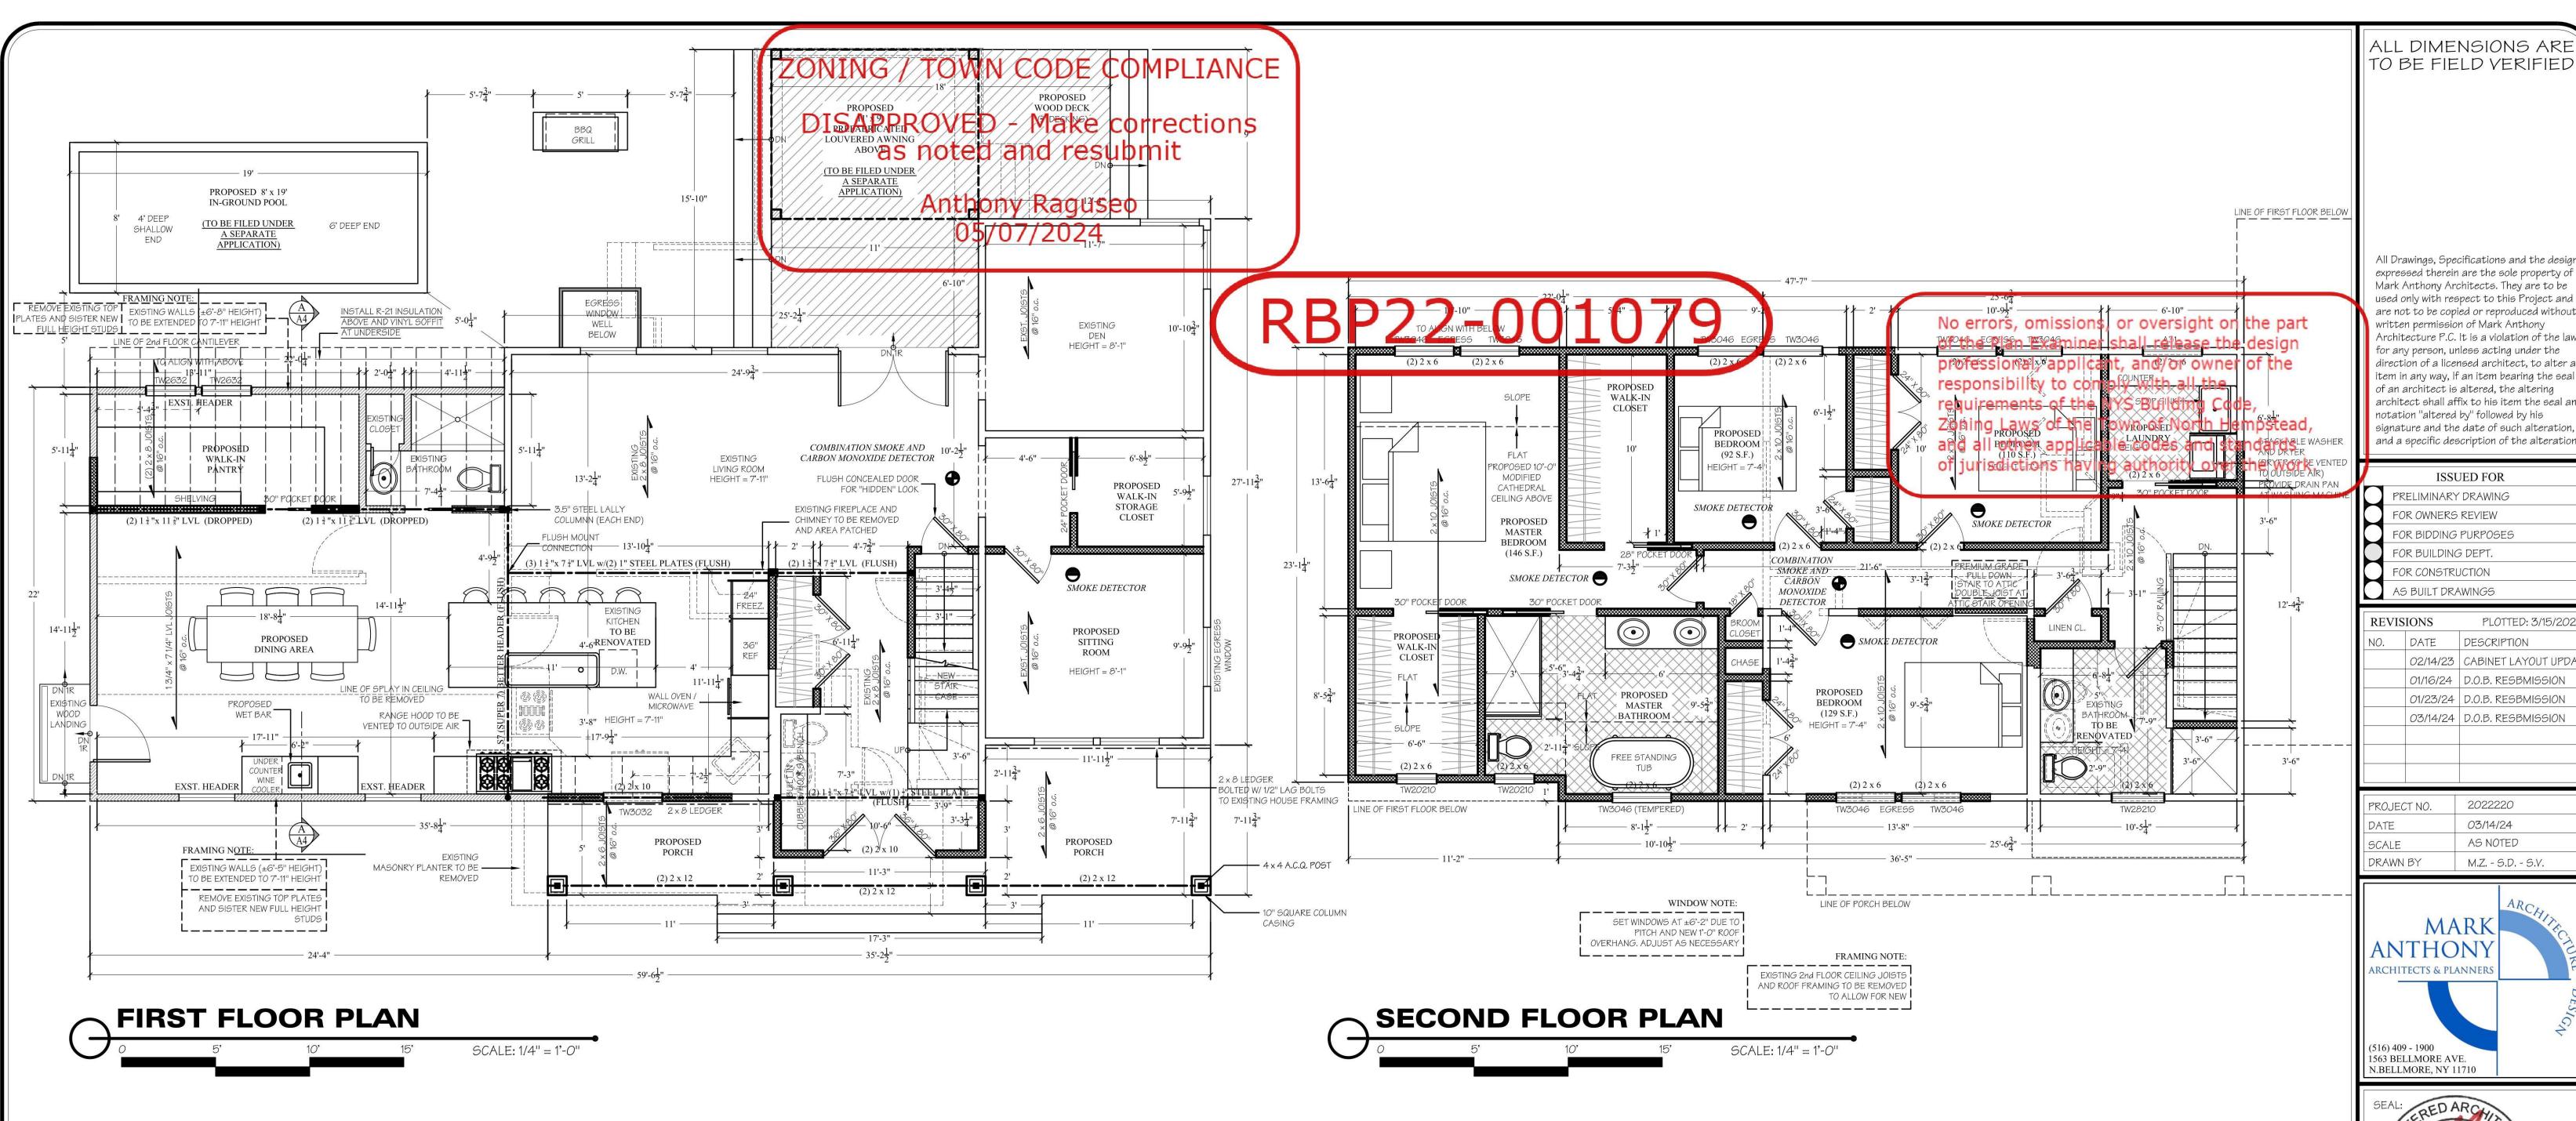

RCNYS 2020) R310 EMERGENCY ESCAPE AND RESCUE OPENINGS

:310.1 - EMERGENCY ESCAPE AND RESCUE OPENING REQUIRED. ASEMENTS, HABITABLE ATTICS AND EVERY SLEEPING ROOM SHALL HAVE NOT LESS HAN ONE OPERABLE EMERGENCY ESCAPE AND RESCUE OPENING. WHERE BASEMENTS ONTAIN ONE OR MORE SLEEPING ROOMS, AN EMERGENCY ESCAPE AND RESCUE PENINGS SHALL BE REQUIRED IN EACH SLEEPING ROOM. EMERGENCY ESCAPE AND ESCUE OPENINGS SHALL OPEN DIRECTLY INTO A PUBLIC WAY, OR TO A YARD OR COURT HAT OPENS TO PUBLIC WAY (EXCEPTION: SEE CODE SECTION) 310.2.1 - MINIMUM OPENING AREA.

EMERGENCY AND ESCAPE RESCUE OPENING SHALL HAVE A NET CLEAR OPENING OF NOT ESS THAN 5.7 SQUARE FEET (0.530 m2/). THE NET CLEAR OPENING DIMENSIONS EQUIRED BY THIS SECTION SHALL BE OBTAINED BY THE NORMAL OPERATION OF THE MERGENCY ESCAPE AND RESCUE OPENING FROM THE INSIDE. THE NET CLEAR HEIGH PENING SHALL BE NOT LESS THAN 24 INCHES (610 mm) AND THE NET CLEAR WIDTH HALL BE NOT LESS THAN 20 INCHES (508 mm) (EXCEPTION: SEE CODE SECTION) 310.2.2 - WINDOW SILL HEIGHT.

VHERE A WINDOW IS PROVIDED AS THE EMERGENCY ESCAPE AND RESCUE OPENING, I HALL HAVE A SILL HEIGHT OF NOT MORE THAN 44 INCHES (1118 mm) ABOVE THE FLOOR; WHERE THE SILL HEIGHT IS BELOW GRADE, IT SHALL BE PROVIDED WITH A WINDOW WELL N ACCORDANCE WITH SECTION R310.2.3

310.2.5 - REPLACEMENT WINDOWS. REPLACEMENT WINDOWS INSTALLED IN BUILDINGS MEETING THE SCOPE OF THIS CODE HALL BE EXEMPT FROM THE MAXIMUM SILL HEIGHT REQUIREMENTS OF SECTION

310.2.2 AND THE REQUIREMENTS OF SECTION R310.2.1, PROVIDED THAT THE EPLACEMENT WINDOW MEETS THE FOLLOWING CONDITIONS: 1: THE REPLACEMENT WINDOW IS THE MANUFACTURER'S LARGEST STANDARD SIZE INDOW THAT WILL FIT WITHIN THE EXISTING FRAME OR EXISTING ROUGH OPENING. THE EPLACEMENT WINDOW IS OF THE SAME OPERATING STYLE AS THE EXISTING WINDOW OR STYLE THAT PROVIDES FOR AN EQUAL OR GREATER OPENING AREA THAN THE EXISTING

2: THE REPLACEMENT WINDOW IS NOT PART OF A CHANGE OF OCCUPANCY. 310.5 - DWELLING ADDITIONS.

VHERE DWELLING ADDITIONS CONTAIN SLEEPING ROOMS, AND EMERGENCY ESCAPE AND ESCUE OPENING SHALL BE PROVIDED IN EACH NEW SLEEPING ROOM. WHERE DWELLING ADDITIONS HAVE BASEMENTS, AN EMERGENCY ESCAPE AND RESCUE OPENING SHALL E PROVIDED IN THE NEW BASEMENT.

1: AN EMERGENCY ESCAPE AND RESCUE OPENING IS NOT REQUIRED IN A NEW ASEMENT THAT CONTAINS A SLEEPING ROOM WITH AN EMERGENCY ESCAPE AND

2: AN EMERGENCY ESCAPE AND RESCUE OPENING IS NOT REQUIRED IN A NEW ASEMENT WHERE THERE IS AN EMERGENCY AND RESCUE OPENING IN AN EXISTING ASEMENT THAT IS ACCESSIBLE FROM THE NEW BASEMENT

50 cfm MECHANICAL VENT / VENT DIRECTLY TO OUTSIDE AIR (AT BATHROOM AREAS) L-----

CLOTHES DRYER EXHAUST TO BE NSTALLED AS PER (RCNYS 2020) ECTION M1502

- DRYER TO HAVE INDEPENDENT VEN' TO OUTSIDE AIR AND INSTALLED AS PER MANUFACTURERS SPECIFICATIONS ________

3.5 " STEEL LALLY COLUMN T BE TREATED WITH RUST-INHIBITIVE PAINT ON ALL SIDES (INSIDE AND OUTSIDE)

(2) 2 x 4 WOOD POST

(2) 2 x 6 WOOD POST

POST ON FLOOR ABOVE ALL EXTERIOR WOOD POSTS ARE T BE A.C.Q. TREATED LUMBER **WOOD POSTS TO SUPPORT FULL

POSTED WITH (4) 2 x 4 POST

ALL NEW WORK DOES CONFORM TO THE REQUIREMENTS FOR AN ADDITION UNDER SECTION AJ501 AND AJ601 (RCNYS 2020)

PROVIDE ILLUMINATION ON THE

EXTERIOR SIDE OF EACH OUTDOOR

WIDTH OF GIRDER (i.e.: (3) LVL GIRDER

WALL-SWITCH-CONTROLLED LIGHTING OUTLET SHALL BE INSTALLED TO

GRESS (TYP)

ALL MEANS OF EGRESS, STAIRWAYS AND RAILINGS EGRESS DOOR HAVING GRADE LEVE

DOUBLE JOISTS UNDER ALL PARALLEL PARTITIONS

ALL LAMINATED GIRDERS T E 2.0E G-P LAM LVL.

LUMBER SPECIFICATION: DOUG - FIR LUMBER #2 WIT FB 875 OR EQUAL DESIGN LOADS TAKEN AS PER WESTERN WOOD PRODUCTS ASSOCIATION IN ACCORDANCE WITH ASTM

STANDARDS * SOLID POST UNDER FULL WIDTH OF GIRDER @ EACH

* SOLID POST DOWN TO FOUNDATION OR GIRDER BELOW UNDER ALL GIRDER

HANDRAILS SHALL BE PROVIDED ON AT LEAST ONE SIDE OF EACH CONTINUOUS RUN OF TREADS OR FLIGHT WITH FOUR OR MORE RISERS (RCNYS 2020 R311.7.8)

HANDRAIL AS PER CODE 312.1.2 (RCNYS 2020

MUST CONFORM TO R311 AND 312 (RCNYS 2020)

RCNYS 2020) R311 MEANS OF EGRESS

314 INCHES (209 MM). THE RISER SHALL BE MEASURED VERTICALLY BETWEEN LEADING EDGES OF THE ADJACENT TREADS. THE GREATEST RISER

EIGHT WITHIN ANY FLIGHT OF STAIRS SHALL NOT EXCEED THE SMALLEST BY MORE THAN /8 INCH (9.5 MM). RISERS SHALL BE VERTICAL OR SLOPED FROM THE UNDERSIDE OF THE OSING OF THE TREAD ABOVE AT AN ANGLE NOT MORE THAN 30 DEGREES (0.51 RAD) FROM HE VERTICAL. AT OPEN RISERS, OPENINGS OCATED MORE THAN 30 INCHES (762 MM), A IEASURED VERTICALLY, TO THE FLOOR OR GRADE BELOW SHALL NOT PERMIT THE ASSAGE OF A 4-INCH-DIAMETER (102 MM) PHFRF.

(CEPTIONS: THE OPENING BETWEEN ADJACENT TREADS NOT LIMITED ON SPIRAL STAIRWAYS. . THE RISER HEIGHT OF SPIRAL STAIRWAYS HALL BE IN ACCORDANCE WITH SECTION 311.7.10.1.

RCNYS 2020) R311 MEANS OF EGRESS 311.7.5.2 TREADS INCHES (229 MM). THE TREAD DEPTH SHALL BE MEASURED HORIZONTALLY BETWEEN THE VERTICAL PLANES OF THE OREMOST PROJECTION OF ADJACENT TREADS AND AT A RIGHT ANGLE TO THE TREAD'S EADING EDGE. THE GREATEST TREAD DEPTH VITHIN ANY FLIGHT OF STAIRS SHALL NOT EXCEED THE SMALLEST BY MORE THAN 3/8

INCH (9.5 MM).

(RCNYS 2020) R303 LIGHT, VENTILATION AND HEATING

03.7 INTERIOR STAIRWAY ILLUMINATIO INTERIOR STAIRWAYS SHALL BE PROVIDED WITH AN ARTIFICIAL LIGHT SOURCE TO ILLUMINATE THE LANDINGS AND TREADS. THE LIGHT SOURCE SHALL BE CAPABLE OF ILLUMINATING TREADS AND LANDINGS TO LEVELS OF NOT LESS THAN 1 FOOT-CANDLE (11 LUX) AS MEASURED AT THE CENTER OF TREADS AND LANDINGS. THERE SHALL BE A WALL SWITCH AT EACH FLOOR LEVEL TO CONTROL THE LIGHT SOURCE WHERE THE STAIRWAY HAS SIX OR MORE RISERS

(RCNYS 2020) R311 MEANS OF EGRESS R311.1 - MEANS OF EGRESS.

DWELLINGS SHALL BE PROVIDED WITH A MEANS OF EGRESS IN ACCORDANCE WITH THIS SECTION. THE MEANS OF EGRESS SHALL PROVIDE A CONTINUOUS AND UNOBSTRUCTED PATH OF VERTICAL AND HORIZONTAL EGRESS TRAVEL FROM ALL PORTIONS OF THE DWELLING TO THE REQUIRED EGRESS DOOR WITHOUT REQUIRING TRAVEL THROUGH A GARAGE. THE REQUIRED EGRESS DOOR SHALL OPEN DIRECTLY INTO A PUBLIC WAY OR TO A YARD OR COURT THA OPENS TO A PUBLIC WAY.

(RCNYS 2020) R303 - LIGHT, VENTILATION AND HEATING R303.4 MECHANICAL VENTILATION.

WHERE THE AIR INFILTRATION RATE OF A DWELLING UNIT IS 5 AIR EXCHANGES PER HOUR OR LESS WHERE TESTED WITH A BLOWER DOOR AT A PRESSURE OF 0.2 INCH W.C. (50 Pa) IN ACCORDANCE WITH SECTION N1102.4.1.2, THE DWELLING JNIT SHALL BE PROVIDED WITH A WHOLE-HOUSE MECHANICAL VENTILATION IN ACCORDANCE WITH SECTION M1505.4

(RCNYS 2020) R303 - LIGHT, VENTILATION AND HEATING

APPROVAL OF THE BUILDING OFFICIAL.

WHERE THE WINTER DESIGN TEMPERATURE IN TABLE R301.2(1) IS BELOW 60 $^{
m O}$ I 16°C), EVERY DWELLING UNIT INTENDED TO BE OCCUPIED BETWEEN SEPTEMBER 15 AND MAY 15 SHALL BE PROVIDED WITH HEATING FACILITIES CAPABLE OF MAINTAINING A ROOM TEMPERATURE OF NOT LESS THAN 68°F (20°C) AT A POINT 3 FEET (914 mm) ABOVE THE FLOOR AT 2 FEET (610 mm) ROM EXTERIOR WALLS IN HABITABLE ROOMS AT THE DESIGN TEMPERATURE. THE INSTALLATION OF ONE OR MORE PORTABLE SPACE HEATERS SHALL NOT BE USED TO ACHIEVE COMPLIANCE WITH THIS SECTION. EXCEPTIONS: OWNER-OCCUPIED ONE-FAMILY DWELLINGS SUBJECT TO THE

(RCNYS 2020) R315 CARBON MONOXIDE ALARMS

CARBON MONOXIDE ALARMS SHALL BE PROVIDED IN ACCORDANCE WITH SECTION 915 OF THE FIRE CODE OF NEW YORK STATE.

(FCNYS 2020) CARBON MONOXIDE DETECTION

915.3 DETECTION LOCATIONS. CARBON MONOXIDE DETECTION SHALL BE INSTALLED IN THE LOCATIONS SPECIFIED IN SECTIONS 915.3 THROUGH 915.3.3 PLUS ANY ADDITIONAL LOCATIONS AS REQUIRED BY THE MANUFACTURER OF THE CARBON MONOXIDE DETECTION DEVICE. ALL CARBON MONOXIDE DETECTORS SHALL BE INSTALLED IN LOCATIONS THAT AVOID DEAD AIR SPACES, TURBULENT AIR SPACES, FRESH AIR RETURNS, OPEN WINDOWS, HVAC DUCTS, CLOSED DOORS, AND OTHER SUCH OBSTRUCTIONS THAT COULD PREVENT CARBON MONOXIDE FROM REACHING THE DETECTOR, WHERE THERE IS A CONFLICT BETWEEN THE LOCATION REQUIREMENTS SPECIFIED BY THIS CODE AND THE LOCATION REQUIREMENTS SPECIFIED BY THE MANUFACTURER OF THE CARBON MONOXIDE DETECTION DEVICE, THE MORE RESTRICTIVE SHALL GOVERN. (EXCEPTION: SEE CODE SECTION)

915.3.1.3 DWELLING UNITS AND SLEEPING UNITS THAT CONTAIN A FUEL-BURNING APPLIANCE. CARBON MONOXIDE DETECTION SHALL BE INSTALLED OUTSIDE OF SLEEPING AREAS AND WITHIN 10 FEET (3048 mm) OF THE ENTRANCE TO THE SLEEPING AREAS IN DWELLING UNITS AND SLEEPING UNITS THAT CONTAIN A FUEL-BURNING APPLIANCE. (EXCEPTION: SEE CODE SECTION)

915.4.1.1 POWER SOURCE. CARBON MONOXIDE ALARMS SHALL RECEIVE THEIR PRIMARY POWER FROM THE BUILDING WIRING WHERE SUCH WIRING IS SERVED FROM A COMMERCIAL SOURCE, AND WHEN PRIMARY POWER IS INTERRUPTED, SHALL RECEIVE POWER FROM A BATTERY. WIRING SHALL BE PERMANENT AND WITHOUT A DISCONNECTING SWITCH OTHER THAN THAT REQUIRED FOR OVERCURRENT PROTECTION.

I. CARBON MONOXIDE ALARMS POWERED BY A 10-YEAR BATTERY SHALL BE AN ACCEPTABLE ALTERNATIVE IN RESIDENTIAL BUILDINGS AND COMMERCIAL BUILDINGS WITHOUT COMMERCIAL POWER, 1.1. EXISTING RESIDENTIAL BUILDINGS AND COMMERCIAL BUILDINGS UNLESS OTHERWISE REQUIRED BY

THE UNIFORM CODE. 2. CARBON MONOXIDE ALARMS INSTALLED IN ACCORDANCE WITH AN EARLIER VERSION OF THE UNIFORM CODE MAY BE CORD-TYPE OR DIRECT PLUG WHEN PERMITTED BY SUCH CODE.

915.5.3 INTERCONNECTION OF MULTIPLE CARBON MONOXIDE NOTIFICATION APPLIANCES. WHEN MORE THAN ONE CARBON MONOXIDE ALARM IS INSTALLED IN A DWELLING UNIT, SLEEPING AREA, OCCUPIABLE SPACE. OR HVAC ZONE. ALL SUCH ALARMS SHALL BE INTERCONNECTED IN SUCH MANNER THAT THE ACTIVATION OF ONE ALARM OR DETECTOR SHALL ACTIVATE ALL CARBON MONOXIDE NOTIFICATION APPLIANCES THROUGHOUT THE INDIVIDUAL DWELLING UNIT, SLEEPING AREA, OCCUPIABLE SPACE, OR HYAC ZONE. INTERCONNECTION OF ALARMS SHALL COMPLY WITH NFPA 720 SECTIONS 9.6.4.1 THROUGH 9.6.4.5 AND 9.6.7. (EXCEPTION: SEE CODE SECTION)

RCNYS 2020) R302 FIRE-RESISTANT CONSTRUCTION

ICLOSED SPACE UNDER STAIRS THAT IS ACCESSED BY A DOOR OR ACCESS PANEL BHALL HAVE WALLS, UNDER-STAIR SURFACE AND ANY SOFFITS PROTECTED ON ENCLOSED SIDE WITH $\frac{1}{2}$ INCH (12.7 mm) GYPSUM BOARD.

(RCNYS 2020) R314 SMOKE ALARMS AND HEAT DETECTION

SMOKE ALARMS SHALL BE INSTALLED IN THE FOLLOWING LOCATIONS:

1. IN EACH SLEEPING ROOM.

2. OUTSIDE EACH SEPARATE SLEEPING AREA IN THE IMMEDIATE VICINITY OF THE

3. ON EACH ADDITIONAL STORY OF THE DWELLING, INCLUDING BASEMENTS AND IABITABLE ATTICS AND NOT INCLUDING CRAWL SPACES AND UNINHABITABLE ATTICS I DWELLINGS OR DWELLING UNITS WITH SPLIT LEVELS AND WITHOUT AN INTERVENING DOOR BETWEEN THE ADJACENT LEVELS, A SMOKE ALARM INSTALLED ON THE UPPER EVEL SHALL SUFFICE FOR THE ADJACENT LOWER LEVEL PROVIDED THAT THE LOWER LEVEL IS LESS THAN ONE FULL STORY BELOW THE UPPER LEVEL.

4. SMOKE ALARMS SHALL BE INSTALLED NOT LESS THAN 3' HORIZONTALLY FROM THE DOOR OR OPENING OF A BATHROOM THAT CONTAINS A BATHTUB OR SHOWER UNLESS THIS WOULD PREVENT PLACEMENT OF A SMOKE ALARM REQUIRED BY THIS

WHEN MORE THAN ONE SMOKE ALARM IS REQUIRED TO BE INSTALLED WITHIN AN IDIVIDUAL DWELLING UNIT IN ACCORDANCE WITH SECTION R314.3, THE ALARM DEVICES SHALL BE INTERCONNECTED IN SUCH A MANNER THAT THE ACTUATION OF ONE ALARM VILL ACTIVATE ALL OF THE ALARMS IN THE INDIVIDUAL DWELLING UNIT. PHYSICAL INTERCONNECTION OF SMOKE ALARMS SHALL NOT BE REQUIRED WHERE LISTED

WIRELESS ALARMS ARE INSTALLED AND ALL ALARMS SOUND UPON ACTIVATION OF EXCEPTION: SMOKE ALARMS AND ALARMS INSTALLED TO SATISFY SECTION R314.4.1 SHALL NOT BE REQUIRED TO BE INTERCONNECTED TO EXISTING SMOKE ALARMS WHERE SUCH EXISTING SMOKE ALARMS ARE NOT INTERCONNECTED OR WHERE SUCH NEW SMOKE ALARM OR ALARM IS NOT CAPABLE OF BEING INTERCONNECTED TO THE EXISTING SMOKE ALARMS.

ALL SMOKE DETECTORS TO BE INTERCONNECTED

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ISSUED FOR PRELIMINARY DRAWING FOR OWNERS REVIEW FOR BIDDING PURPOSES FOR BUILDING DEPT. FOR CONSTRUCTION AS BUILT DRAWINGS

REV	ISIONS	PLOTTED: 3/15/2024				
NO.	DATE	DESCRIPTION				
	02/14/23	CABINET LAYOUT UPDATE				
	01/16/24	D.O.B. RESBMISSION				
	01/23/24	D.O.B. RESBMISSION				
	03/14/24	D.O.B. RESBMISSION				
ul						

PROJECT NO.	2022220
DATE	03/14/24
SCALE	AS NOTED
DRAWN BY	M.Z S.D S.V.





DRAWING:


FIRST AND SECOND FLOOR PLANS

3 TWELFTH STREET

CARLE PLACE, NY 11514

D.O.B. I.D#

DRAWING No.

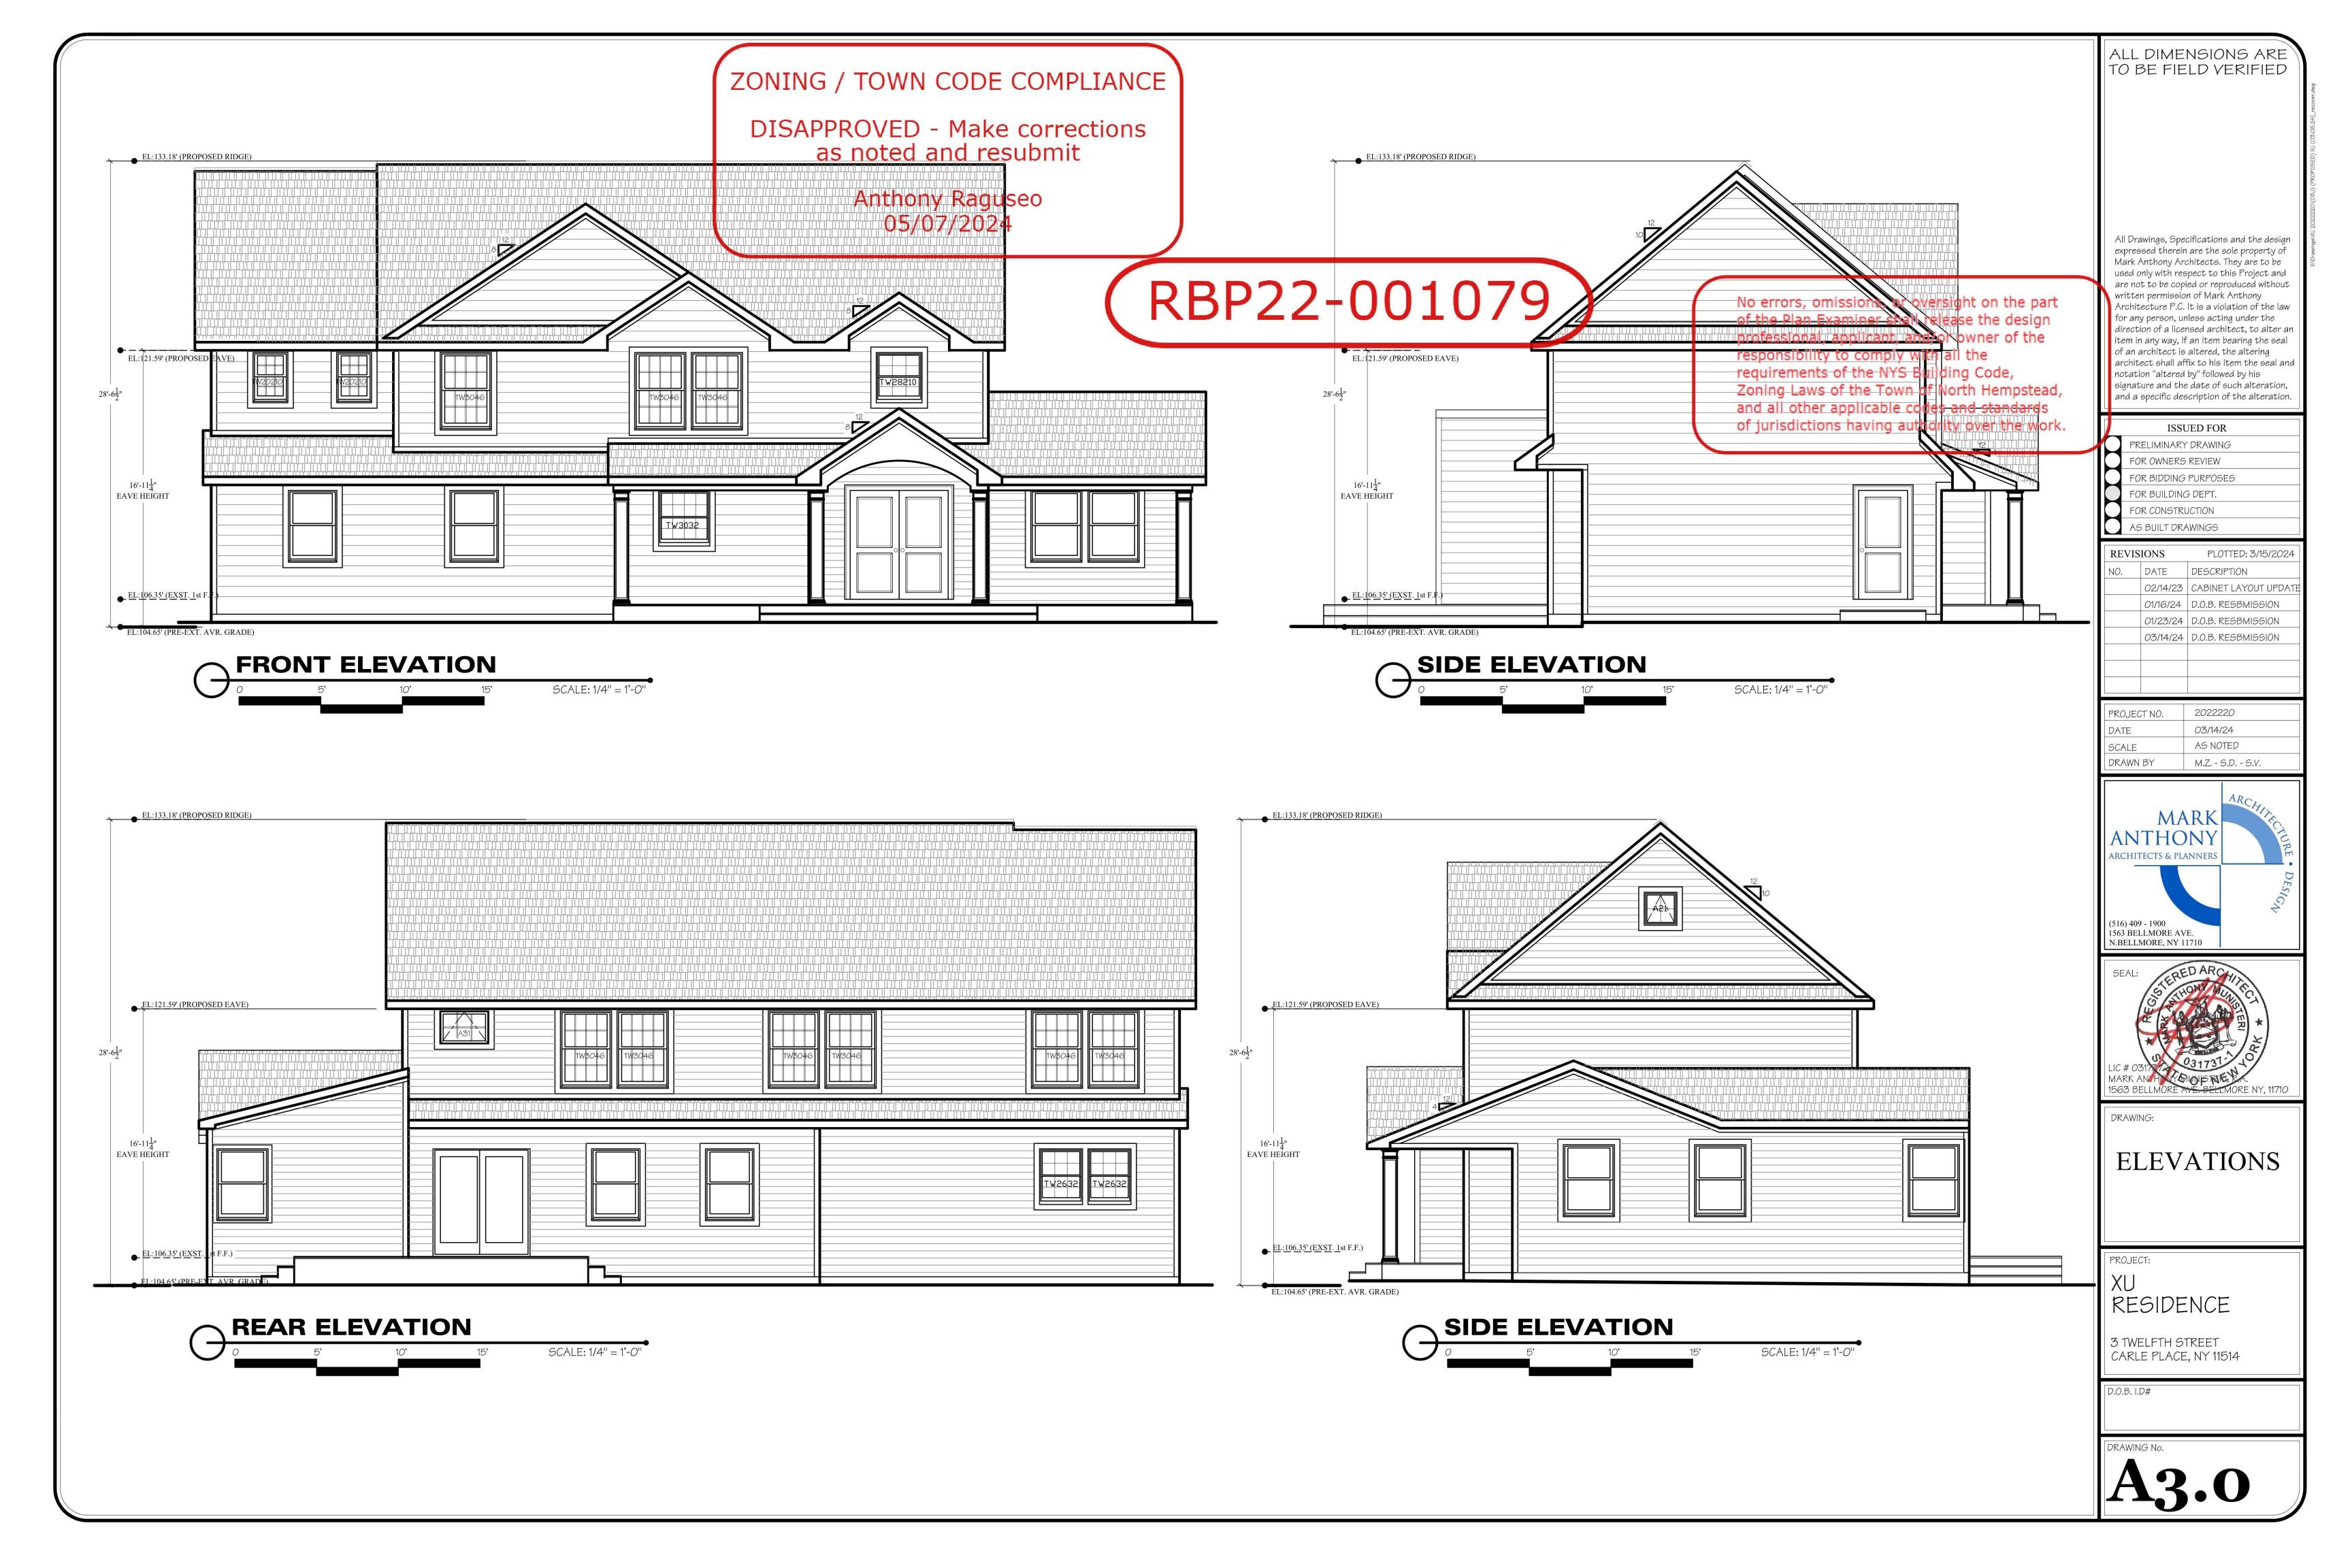

NAILING SCHEDLILE EOD STOLICTURAL MEMBERS (2018 WECK), TABLE 3 1)

JOINT DESCRIPTION	NUMBER OF COMMON NAILS	NUMBER OF BOX NAILS	NAIL SPACING
RO	OF FRAMING		
RAFTER TO TOP PLATE (TOE-NAILED)	SEE TABLE 3.4A	SEE TABLE 3.4A	PER RAFTER
CEILING JOIST TO TOP PLATE (TOE-NAILED)	SEE TABLE 3.4A	SEE TABLE 3.4A	PER JOIST
CEILING JOIST TO PARALLEL RAFTER (FACE-NAILED)	SEE TABLE 3.9A	SEE TABLE 3.9A	EACH LAP
CEILING JOIST LAPS OVER PARTITIONS (FACE-NAILED)	SEE TABLE 3.9A	SEE TABLE 3.9A	EACH LAP
COLLAR TIE TO RAFTER (FACE-NAILED)	SEE TABLE 3.6	SEE TABLE 3.6	PER TIE
BLOCKING TO RAFTER (TOE-NAILED)	2 - 8d	2 - 10d	EACH END
RIM BOARD TO RAFTER (END-NAILED)	2 - 16d	3 - 16d	EACH END
WA	ALL FRAMING		
TOP PLATE TO TOP PLATE (FACE-NAILED)	2 - 16d ¹	2 - 16d ¹	PER FOOT
TOP PLATES AT INTERSECTIONS (FACE-NAILED)	4 - 16d	5 - 16d	JOINTS-EACH SIDE
STUD TO STUD (FACE-NAILED)	2 - 16d	2 - 16d	24" o.c.
HEADER TO HEADER (FACE-NAILED)	16d	16d	16" o.c. ALONG EDGES
TOP OR BOTTOM PLATE TO STUD (END-NAILED)	SEE TABLE 3.5A	SEE TABLE 3.5A	PER STUD
BOTTOM PLATE TO FLOOR JOIST, BAND JOIST, END JOIST OR BLOCKING (FACE NAILED	2 - 16d ^{1,2}	2 - 16d ^{1,2}	PER FOOT
FLO	OOR FRAMING		
JOIST TO SILL, TOP PLATE OR GIRDER (TOE-NAILED)	4 - 8d	4 - 10d	PER JOIST
BRIDGING TO JOIST (TOE-NAILED)	2 - 8d	2 - 10d	EACH END
BLOCKING TO JOIST (TOE-NAILED)	2 - 8d	2 - 10d	EACH END
BLOCKING TO SILL OR TOP PLATE (TOE-NAILED)	3 - 16d	4 - 16d	EACH BLOCK
LEDGER STRIP TO BEAM (FACE-NAILED)	3 - 16d	4 - 16d	EACH JOIST
JOIST ON LEDGER TO BEAM (TOE-NAILED)	3 - 8d	3 - 10d	PER JOIST
BAND JOIST TO JOIST (END-NAILED)	3 - 16d	4 - 16d	PER JOIST
BAND JOIST TO SILL OR TOP PLATE (TOE-NAILED)	2 - 16d ¹	3 - 16d	PER FOOT
RO	OF SHEATHING		
WOOD STRUCTURAL PANELS	8d	10d	SEE TABLE 3.10
DIAGONAL BOARD SHEATHING 1" x 6" OR 1" x 8"	2 - 8d	2 - 10d	PER SUPPORT
DIAGONAL BOARD SHEATHING 1" x 10" OR WIDER	3 - 8d	3 - 10d	PER SUPPORT
CE	ILING SHEATHING		-1
GYPSUM WALLBOARD	5d COOLERS	5d COOLERS	7" EDGE / 10" FIELD
WA	ALL SHEATHING		
WOOD STRUCTURAL PANELS	8d	10d	SEE TABLE 3.11
STRUCTURAL FIBERBOARD PANELS 1/2"	11 ga. galv. roofing nail (.120"x1 $\frac{1}{2}$ "LONG x $\frac{7}{16}$ " HEAD)		3" EDGE / 6" FIELD
STRUCTURAL FIBERBOARD PANELS 25/32"	11 ga. galv. roofing nail (.120"x1 $\frac{1}{2}$ "LONG x $\frac{3}{8}$ " HEAD)		3" EDGE / 6" FIELD
GYPSUM WALLBOARD	5d COOLERS	5d COOLERS	7" EDGE / 10" FIELD
HARDBOARD	8d	8d	SEE TABLE 3.11
PARTICLEBOARD PANELS	8d	8d	SEE MANUFACTURER

NAILING REQUIREMENTS ARE BASED ON WALL SHEATHING NAILED 6" ON-CENTER AT THE PANEL EDGE. ALTERNATIVE NAILING SCHEDULES SHALL BE USED WHERE WALL SHEATHING NAILING IS REDUCED. FOR EXAMPLE, IF WALL SHEATHING IS NAILED 3" ON-CENTER AT THE PANEL EDGE TO OBTAIN HIGHER SHEAR CAPACITIES, NAILING REQUIREMENTS FOR STRUCTURAL MEMBERS

1" x 6" OR 1" x 8"

1" x 10" OR WIDER

GREATER THAN 1"

1" x 6" OR 1" x 8"

1" x 10" OR WIDER

SHALL BE DOUBLED, OR ALTERNATE CONNECTORS SHALL BE USED TO MAINTAIN THE LOAD PATH.

1" OR LESS

DIAGONAL BOARD SHEATHING

DIAGONAL BOARD SHEATHING

WOOD STRUCTURAL PANELS

VOOD STRUCTURAL PANELS

DIAGONAL BOARD SHEATHING

DIAGONAL BOARD SHEATHING

2-8d

3 - 8d

80

10d

2 - 8d

3 - 8d

FLOOR SHEATHING

2 - 10d

3 - 10d

10d

16d

2 - 10d

3 - 10d

PER SUPPORT

PER SUPPORT

6" EDGE / 12" FIELD

6" EDGE / 12" FIELD

PER SUPPORT

PER SUPPORT

² WHEN WALL SHEATHING IS CONTINUOUS OVER CONNECTED MEMBERS, THE TABULATED NUMBER OF NAILS SHALL BE PERMITTED TO BE REDUCED TO 1-16d NAIL PER FOOT

	Shear Co	nd/or Ceiling Joist to Top Plate Lateral and Exposure E onnection Requirements ve Alternative to Table 3.4)										
700-yr. Wind Speed 3-second gust (mph)		110	115	120	130	140	150	160	170	180	195	
Rafter/Ceiling Jois Spacing (in.)	Wall Height (ft.)	37	Requi						Toenailed) te Connectio	on ^{1,2,3,4}		
12	8	2	2	2	2	3	3	3	3	3	3	
12	10	2	2	2	2	3	3	3	3	3	3	
16	8	2	2	2	3	3	3	3	3	3	3	
10	10	2	2	2	3	3	3	3	3	3	4	
5,57,5	8	3	3	3	4	5	5	5	5	5	5	
24		0.000	720	12	7. 1		-		-	5		

- When ceiling joists are installed parallel to rafters, the sum of the toenails in the rafter and ceiling joist shall equal or exceed the tabulated number of nails required.
- To avoid splitting, no more than 2 toenails shall be installed in each side of a rafter or ceiling joist when fastened to a 2x4
- top plate or 3 toenails in each side when fastened to a 2x6 top plate. Where top plate-to-ridge heights exceed 10', they shall be adjusted as follows:

1.40 1.50

Top Plate to Ridge djustment Facto 1.00 1.15 1.25

ZONING / TOWN CODE COMPLIANCE

DISAPPROVED - Make corrections as noted and resubmit

> Anthony Raguseo 05/07/2024

> > EAVE HEIGHT

EL:106.35' (EXST. 1st F.F.)

:104.65' (PRE-EXT. AVR. GRADE)

ASPHALT DIMENSIONAL ROOF SHINGLES OVER 15# BLDG FELT OVER 1/2" CDX PLYWOOD SHEATHING. PROVIDE ICE AND WATER SHIELD TO 4'-O" IN FROM EAVES & @ ALL VALLEYS (TYP

SNOW AND ICE SHIELD SHO

EL:121.59' (PROPOSED EAVE) 2×4 WALLS W/ R-15 INSULATION, V.B., 1/2" SHEETROCK, 1/2" CDX SHEATHING, W/ 1" TUFF-R

RIGID INSUL. (R-5.0) VINYL FINISH

3/4" PLYWOOD SUBFLOOR, GLUED AND SCREWED TO FLOOR BEAMS. BLOCK ALL UNSUPPORTED EDGES.

2 x 6 FRAMED EYEBROW ROO

(PROVIDE VINYL SOFFIT AT

(2) $1\frac{3}{4}$ "x $11\frac{7}{8}$ " LVL (DROPPED) R- 21 INSULATION -EXISTING PROPOSED

ADJACENT GRADI

MATCH

EXISTING

MASTER

BEDROOM

PROPOSED WALL DINING AREA **DINING AREA HEIGHT** EXISTING WALL

EXISTING WALLS (±6'-5" HEIGHT ._____ WALL REMOVE EXISTING TOP PLATES HEIGHT AND SISTER NEW FULL HEIGHT ______

SCALE: 1/4" = 1'-0"

MATCH

EXISTING

SOLID BLOCK UNDER ___

- INSTALL 30" x 30" x 15" CONC. FOOTING DIRECTLY UNDER POST ABOVE CONTRACTOR TO VERIFY EXISTING

PROPOSED

MASTER

BATHROOM

 $1\frac{3}{4}$ " x $11\frac{1}{4}$ " LVL RIDGE w/ RIDGE VE N

CROSS SECTION 'A'

2nd STORY IF APPLICABLE PORCH 1st STORY IF APPLICABLE APPLICABLE APPLICABLE

TYP. CONNECTOR DIAGRAM DETAIL SHEET AS N.T.S.

THE MECHANICAL SYSTEM SHALL BE INSTALLED IN ACCORDANCE WITH CHAPTERS THE ELECTRICAL SYSTEM SHALL BE INSTALLED THE PLUMBING SYSTEM SHALL BE INSTALLED 12/24 OF THE RCNYS 2020 25/33 OF THE RCNYS 2020 CHAPTERS 34/42 OF THE RCNYS 2020

WITHIN THE FIRST 10'

CONTRACTOR TO VERIFY THAT WOOD SHEATHING TO BE A MIN. OF 6" FROM GRADE (AS PER RCNYS 2020 SECTION R317)

ROOF COVERINGS TO BE INSTALLED AS PER (RCNYS 2020) SECTION R905

ALL LUMBER THAT COMES IN CONTACT WITH MASONRY (CONCRETE) TO BE A.C.Q. LUMBER

DOUBLE JOIST UNDER ALL PARALLEL PARTITIONS HANDRAILS SHALL BE PROVIDED ON AT LEAST ONE SIDE

OF EACH CONTINUOUS RUN OF TREADS OR FLIGHT WITH FOUR OR MORE RISERS (RCNYS 2020 SECTION R311.7.8) ALL MEANS OF EGRESS, STAIRWAYS

CONTRACTOR TO VENT CONCEALED RAFTER SPACE ABOVE INSULATION TO THE EXTERIOR

AND RAILINGS MUST CONFORM

TO RCNYS 2020 SECTIONS R311 AND 312

ROVIDE 2" X 6" COLLAR TIES 32" o.c. @ ALL ROOFS. ET TOP OF TIES IN UPPER 1/3 OF THE DISTANCE BETWEEN .O. RIDGE AND T.O. CEILING JOISTS.

CORROSION- RESISTIVE FLASHING TO BE PROVIDED UNDER AND AT THE ENDS OF MASONRY, WOOD, OR METAL COPINGS AND SILLS. ALL MATERIALS IN CONTRACT

WITH PRESSURE TREATED LUMBER (STRAP, TECO, NAILS, FLASHING) SHALL BE APPROVED FOR SUCH USE. (RCNYS 2020 SECTION R703.4) SURFACE DRAINAGE SHALL BE DIVERTED TO A STORM SEWER CONVEYANCE OR OTHER APPROVED POINT OF COLLECTION SO AS TO NOT CREATE A HAZARD. LOTS SHALL BE GRADED SO AS TO DRAIN SURFACE WATER AWAY FROM FOUNDATION

WALLS. THE GRADE AWAY FROM FOUNDATION WALL SHALL FALL A MINIMUM OF 6"

(AS PER RC 2020 SECTION R406) EXCEPT WHERE REQUIRED BY SECTION R406.2 TO BE WATERPROOFED, FOUNDATION WALLS THAT RETAIN EARTH AND ENCLOSE INTERIOR SPACES AND FLOORS BELOW GRADE SHALL BE DAMPPROOFED FROM THE HIGHER OF (a) THE TOP OF THE FOOTING OR (b) 6 INCHES (152 mm) BELOW THE TOP OF THE BASEMENT FLOOR, TO THE FINISHED GRADE. MASONRY WALLS SHALL HAVE NOT

WITH ONE OF THE FOLLOWING. 1: BITUMINOUS COATIING 2: THREE POUNDS PER SQUARE YARD (1.63 kg/m²) OF ACRYLIC MODIFIED 3: ONE-EIGHTH-INCH (3.2 mm) COAT OF SURFACE-BONDING CEMENT COMPLYING WITH ASTM C 887.

4: ANY MATERIAL PERMITTED FOR WATERPROOFING IN SECTION R406.2

LESS THAN \(\frac{3}{6}\) INCH (9.5 mm) PORTLAND CEMENT PARGING APPLIED TO THE

EXTERIOR OF THE WALL. THE PARGING SHALL BE DAMPPROOFED IN ACCORDANCE

5: OTHER APPROVED METHODS OR MATERIALS. 1: PARGING OF UNIT MASONRY WALLS IS NOT REQUIRED WHERE A MATERIAL IS APPROVED FOR DIRECT APPLICATION TO THE MASONRY

CONCRETE WALLS SHALL BE DAMPPROOFED BY APPLYING ANY ONE OF THE LISTED DAMPPROOFING MATERIALS OR ANY ONE OF THE WATERPROOFING MATERIALS LISTED IN SECTION R406.2 TO THE EXTERIOR OF WALL




AIR SEALING DETAILS TO FOLLOW THE REQUIREMENTS OF THE 2020 RESIDENTIAL CODE OF NEW YORK STATE.

-ROOF VENT

P3103.2 FROST CLOSURE - WHERE THE 97.5-PERCENT VALUE FOR OUTSIDE DESIGN TEMPERATURE IS O DEGREES F (-18 DECREES C) OR LESS, VENT EXTENSIONS THROUGH A ROOF OR A WALL SHALL NOT BE

LESS THEN 3 INCHES IN DIAMETER. ANY INCREASE IN THE SIZE OF THE VENT SHALL BE MADE NOT LESS THAN 1 FOOT (304.8 mm) INSIDE THE THERMAL ENVELOPE OF THE BUILDING. P3103.1.1 ROOF EXTENSION - OPEN VENT PIPES THAT EXTEND THROUGH A ROOF THAT DO NOT MEET THE CONDITIONS OF SECTION P3103.1.2 OR P3103.1.3 SHALL TERMINATE NOT LESS THAN 6 INCHES (150 mm) ABOVE

THE ROOF OR 6 INCHES (150 mm) ABOVE THE ANTICIPATED SNOW ACCUMULATION, WHICHEVER IS GREATER. PROPOSED PROPOSED BATHROOM TO LAUNDRY MASTER ROOM BATHROOM

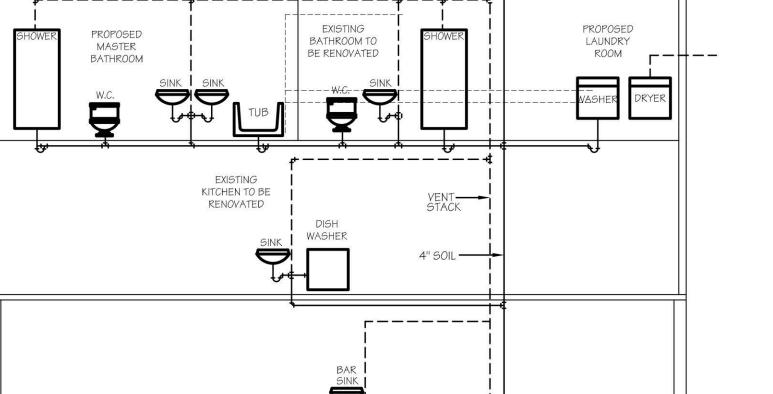

EXISTING HOUSE DRAIN

PLUMBING RISER DIAGRAM

BRANCH BRANCH SOIL OR WASTE VENT COLD CONNECTION CONNECTION WATER WATER 3/4" 3/4" 1 1/2" SINK 1 1/2" 1 1/4" BATHTUB **SHOWER** 3/4" 1 1/2" WASHER 1 1/2"

No errors, omissions, or oversight on the part

of the Plan Examiner shall release the design

Zoning Laws of the Town of North Hempstead,

of jurisdictions having authority over the work.

and all other applicable codes and standards

professional, applicant, and/or owner of the

responsibility to comply with all the

FRAMING NOTE:

requirements of the NYS Building Code,

TABLE P3201.7 SIZE OF TRAPS AND TRAP ARMS FOR PLUMBING FIXTURES

PLUMBING FIXTURE	TRAP SIZE MINIMUM (INCHES)
BATHTUB (WITH OR WITHOUT SHOWER HEAD AND/OR WHIRLPOOL ATTACHMENTS)	1 ½
BIDET	1 1/4
CLOTHES WASHER STANDPIPE	2
DISHWASHER (ON SEPARATE TRAP)	1 ½
FLOOR DRAIN	2
KITCHEN SINK (ONE OR TWO TRAPS, WITH OR WITHOUT DISHWASHER AND GARBAGE GRINDER)	1 ½
LAUNDRY TUB (ONE OR MORE COMPARTMENTS)	1 ½
LAVATORY	1 1/4
SHOWER NOTE a	
5.7 GPM AND LESS MORE THAN 5.7 GPM UP TO 12.3 GPM MORE THAN 12.3 GPM UP TO 25.8 GPM MORE THAN 25.8 GPM UP TO 55.6 GPM	11/2 2 3 4
WATER CLOSET	NOTE b

(a) BASED ON TOTAL FLOW RATE THROUGH SHOWERHEADS AND BODYSPRAYS (b) CONSULT FIXTURE STANDARDS FOR TRAP DIMENSION OF SPECIFIC BOWLS

ALL DIMENSIONS ARE TO BE FIELD VERIFIED


All Drawings, Specifications and the design expressed therein are the sole property of Mark Anthony Architects. They are to be used only with respect to this Project and are not to be copied or reproduced without written permission of Mark Anthony Architecture P.C. It is a violation of the law for any person, unless acting under the direction of a licensed architect, to alter ar item in any way, If an item bearing the seal of an architect is altered, the altering architect shall affix to his item the seal and notation "altered by" followed by his signature and the date of such alteration, and a specific description of the alteration.

ISSUED FOR PRELIMINARY DRAWING FOR OWNERS REVIEW FOR BIDDING PURPOSES FOR BUILDING DEPT. FOR CONSTRUCTION AS BUILT DRAWINGS

PLOTTED: 3/15/2024 REVISIONS NO. DATE DESCRIPTION 02/14/23 | CABINET LAYOUT UPDA 01/16/24 D.O.B. RESBMISSION 01/23/24 D.O.B. RESBMISSION 03/14/24 D.O.B. RESBMISSION

2022220 PROJECT NO. 03/14/24 AS NOTED DRAWN BY M.Z. - S.D. - S.V.




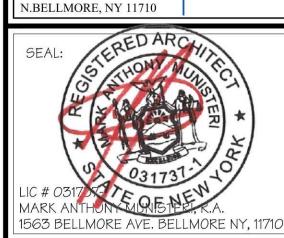


CROSS SECTION AND **DETAILS**


RESIDENCE

3 TWELFTH STREET CARLE PLACE, NY 11514

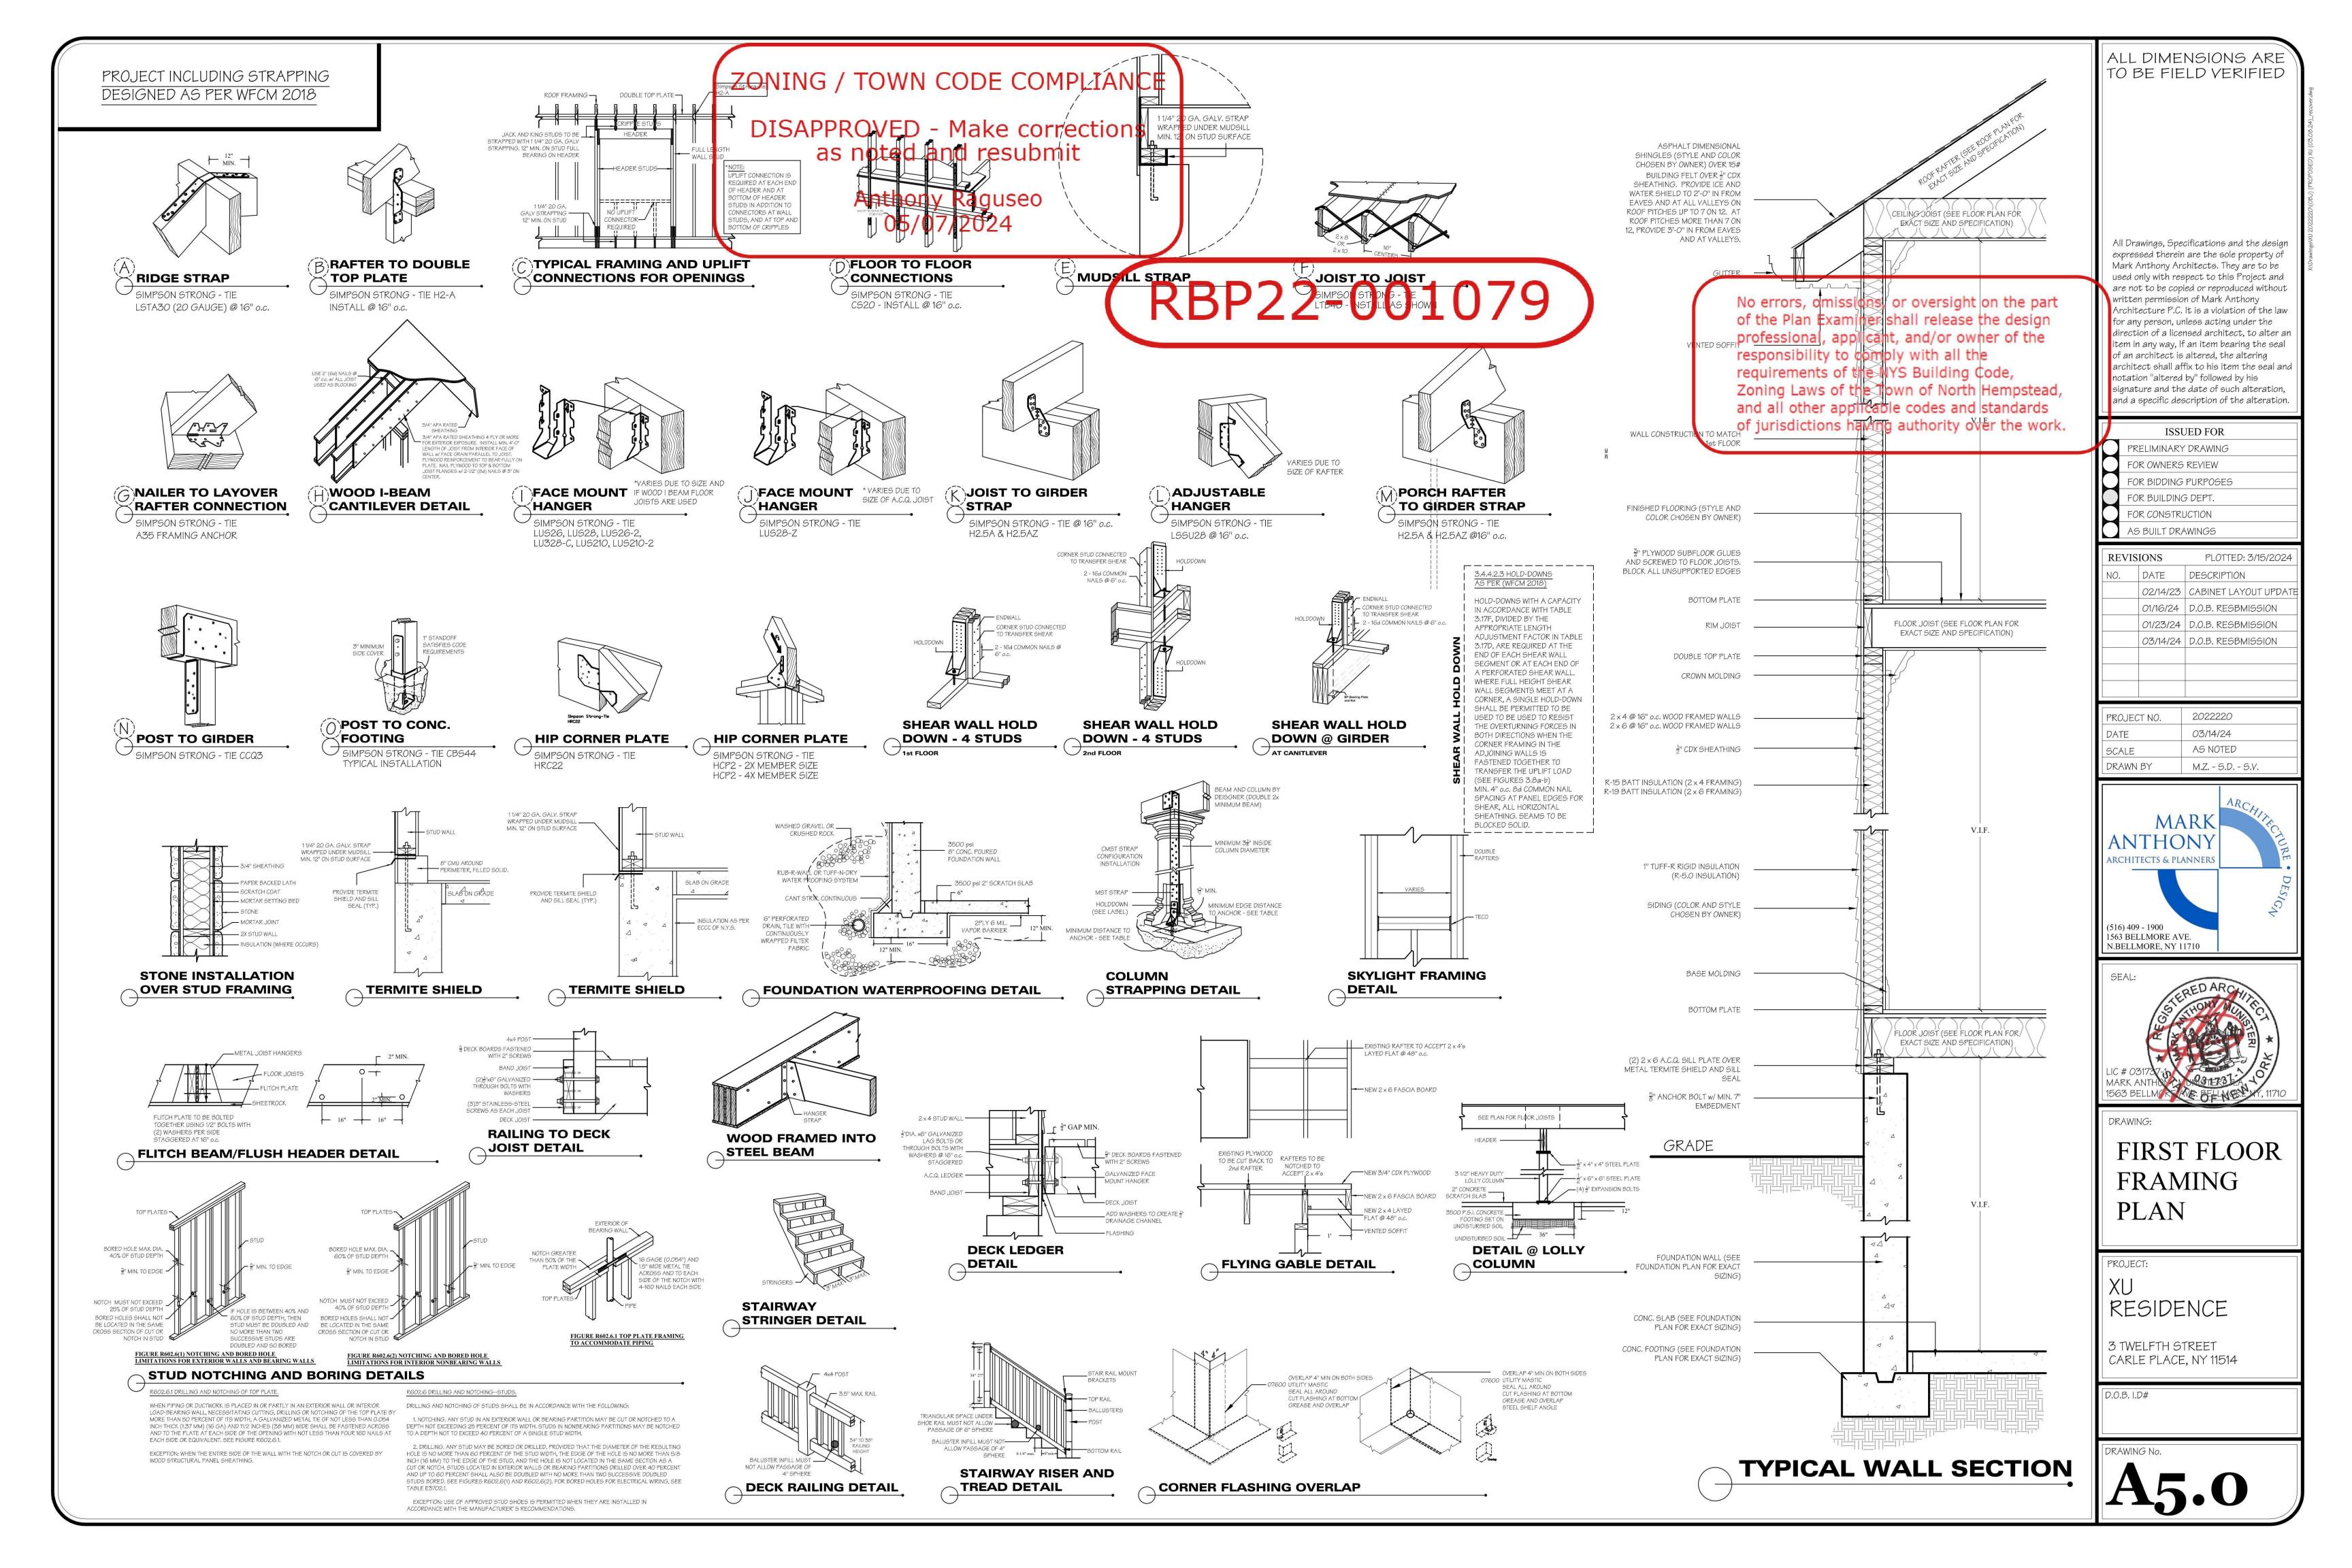



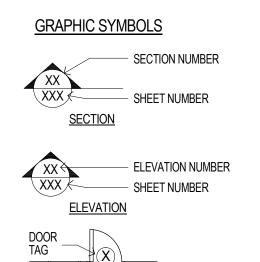

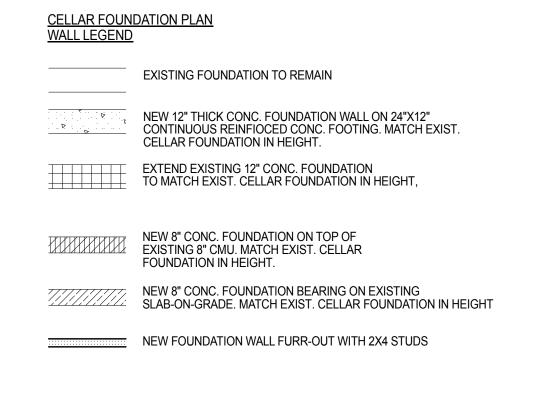


LEGEND	
	EXISTING FOUNDATION WALL TO REMAIN
	WALL, PARTITION, FOUNDATION TO BE REMOVED,
<u>/////////////////////////////////////</u>	NEW FRAME WALL w/ BRICK OR CASTSTONE 2"X6" STUDS 24" O.C. WITH R-20 CAVITY INSULATION, 1/2" PLYWOOD OR OSB SHEATHING, GYP. BD ON INTERIOR
	NEW INTERIOR FRAME WALL 2"X4" 16" O.C. OR 2"X6" 24" O.C., SEE FLOOR PLAN, w/ GYP. BD. PROVIDE WATER RESISTANT GYP BD. IN BATHROOMS AND KITCHEN WALLS
	CONCRETE FOUNDATION WALL
(SD)	SMOKE DETECTOR - HARD-WIRE, INTERCONNECT

PROGRAMABLE THERMOSTAT

CARBON MONOXIDE DETECTOR - HARD-WIRE

SITE PLAN	N LEGEND
FF	POINT OF BEGINNING FIRST FLOOR ELEVATION GARAGE FLOOR ELEVATION FOR PEAK ELEVATION FOR OF CURB
GEN A.C WW	WATER VALVE GENERATOR GENERATOR WINDOW WELL TREE & SIZE
	TRENCH DRAIN (DI) CURB CUT VINYL FENCE WATER LINE GAS LINE PROPERTY LINE

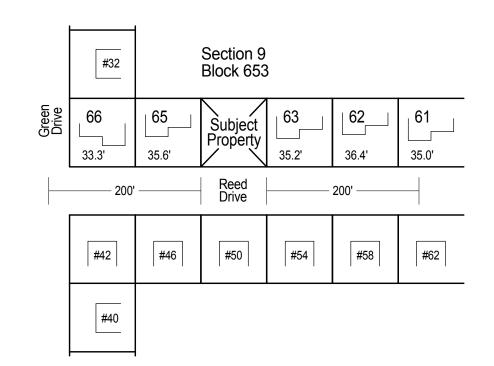


63 35.2' 62 36.4' 61 <u>35.0'</u> 175.5'

175.5 / 5 = 35.10'

Average Front Yard setback = 35.10'

AVERAGE FRONT YARD SETBACK

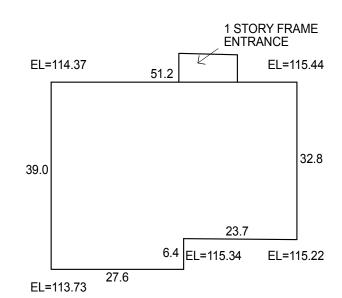

Calculation

115.22 + 115.34 = 230.56 / 2 = 115.28 x 23.7 = 2732.14 115.34 x 6.4 = 738.18 115.34 + 113.73 = 229.07 / 2 = 114.54 x 27.6 = 3161.30 113.73 + 114.37 = 228.10 / 2 = 114.05 x 39.0 = 4447.95 114.37 + 115.44 = 229.81 / 2 = 114.91 x 51.2 = 5883.39 115.44 + 115.22 = 230.66 / 2 = 115.33 x 32.8 = 3782.82

20,745.78 / 180.70 = 114.81


THe preexisting average grade = 114.81

PREEXISTING AVERAGE GRADE

NEW DWELLING ON A NEW & EXISTING FOUNDATION SECTION: 9, BLOCK: 653, LOT: 64 LOT AREA: 11,847.79 sq. ft. INTERIOR LOT, IRREGULARLY SHAPED

ZONING CODE ANALYSIS RESIDENCE A DISTRICT (R-A)							
	PERMITTED	EXISTING	PROVIDED	<u>TOWN</u> <u>VARIANCE</u>			
MAX. BLDG. HEIGHT	2 1/2 STORY	1 1/2 STORY	2 1/2 STORY	NO			
	30'-0"	18'-7"	29'-7"	NO			
MAX. EAVE HEIGHT	22'-0"	14'-10"	21'-8"	NO			
MIN. PLOT AREA	8,500 SF	11,847.79 SF	11,847.79 SF	NO			
MIN. LOT WIDTH A. @ REQ'D FRONT SETBACK LINE / @ ALL POINTS BETW. STREET P.L. & FRONT SETBACK LINE	65' / 40' **	73.48' / 67.25	73.48' / 67.25	PRE-EXISTING			
B. AVERAGE LOT WIDTH	<u>84.0'</u>	<u>84.0'</u>	<u>84.0'</u>	CONDITION			
GREATER OF A OR B, NOT TO EXCEED 100'	<u>84.0'</u>	<u>84.0'</u>	<u>84.0'</u>				
MAX. LOT COVERAGE	25%	16.2%	17.9%	NO			
MIN. HABITABLE FLOOR AREA	1,200 SF	2,597 SF	3,023 SF	NO			
MAX. GROSS FLOOR AREA	4,000 SF	3,003 SF	4,033 SF	YES			
MIN. FRONT YARD DEPTH	35.1' *	36.0'	33.1'	YES			
SIDE YARDS NUMBER OF SIDE YARDS MIN. WIDTH OF ANY S.Y. MIN. AGGREGATE WIDTH	TWO 10' 30% 22.0'	TWO 11.2'	TWO 11.2' 30.5%, 22.4'	NO			
MIN .REAR YARD SETBACK	15'	62.2'	61.7'	NO			
SKY EXPOSURE PLANES	RATIO OF 2' VERTICAL TO 1' HORIZNTAL		RATIO OF 1.99' VERTICAL TO 1' HORIZONTAL	NO			
MAX. FRONT YARD PAVING	40% ***	30.0%	37.4%	NO			
MIN. SLOPE FOR ATTACHED GARAGE	3% BELOW ****		2% ABOVE	NO			
MAX. REAR YARD COVERAGE	40% *****		15.9%	NO			
OFF-STREET PARKING	2	2	2	NO			

- * SEE AVERAGE FRONT YARD SETBACK DIAGRAM & CALCULATION ON THIS SHEET
- ** WIDTH OF THE LOT AT THE REQUIRED FRONT YARD SETBACK = 73.48'
- *** SEE FRONT YARD PAVING CALCULATION ON T-2 SHEET
- **** GARAGE FLOOR ELEVATION NO LOWER THAN 3% SLOPE BELOW ADJACENT CURB ELEV. VERTICAL DISTANCE = GARAGE FL. ELEV 113.9 ADJ. CURB ELEV 112.99 = 0.91' HORIZONTAL DISTANCE = 45', SLOPE = 0.91 / 45 = 2.0% SLOPE ABOVE CURB ELEV
- ***** SEE REAR YARD COVERAGE CALCULATION ON T-2 SHEET

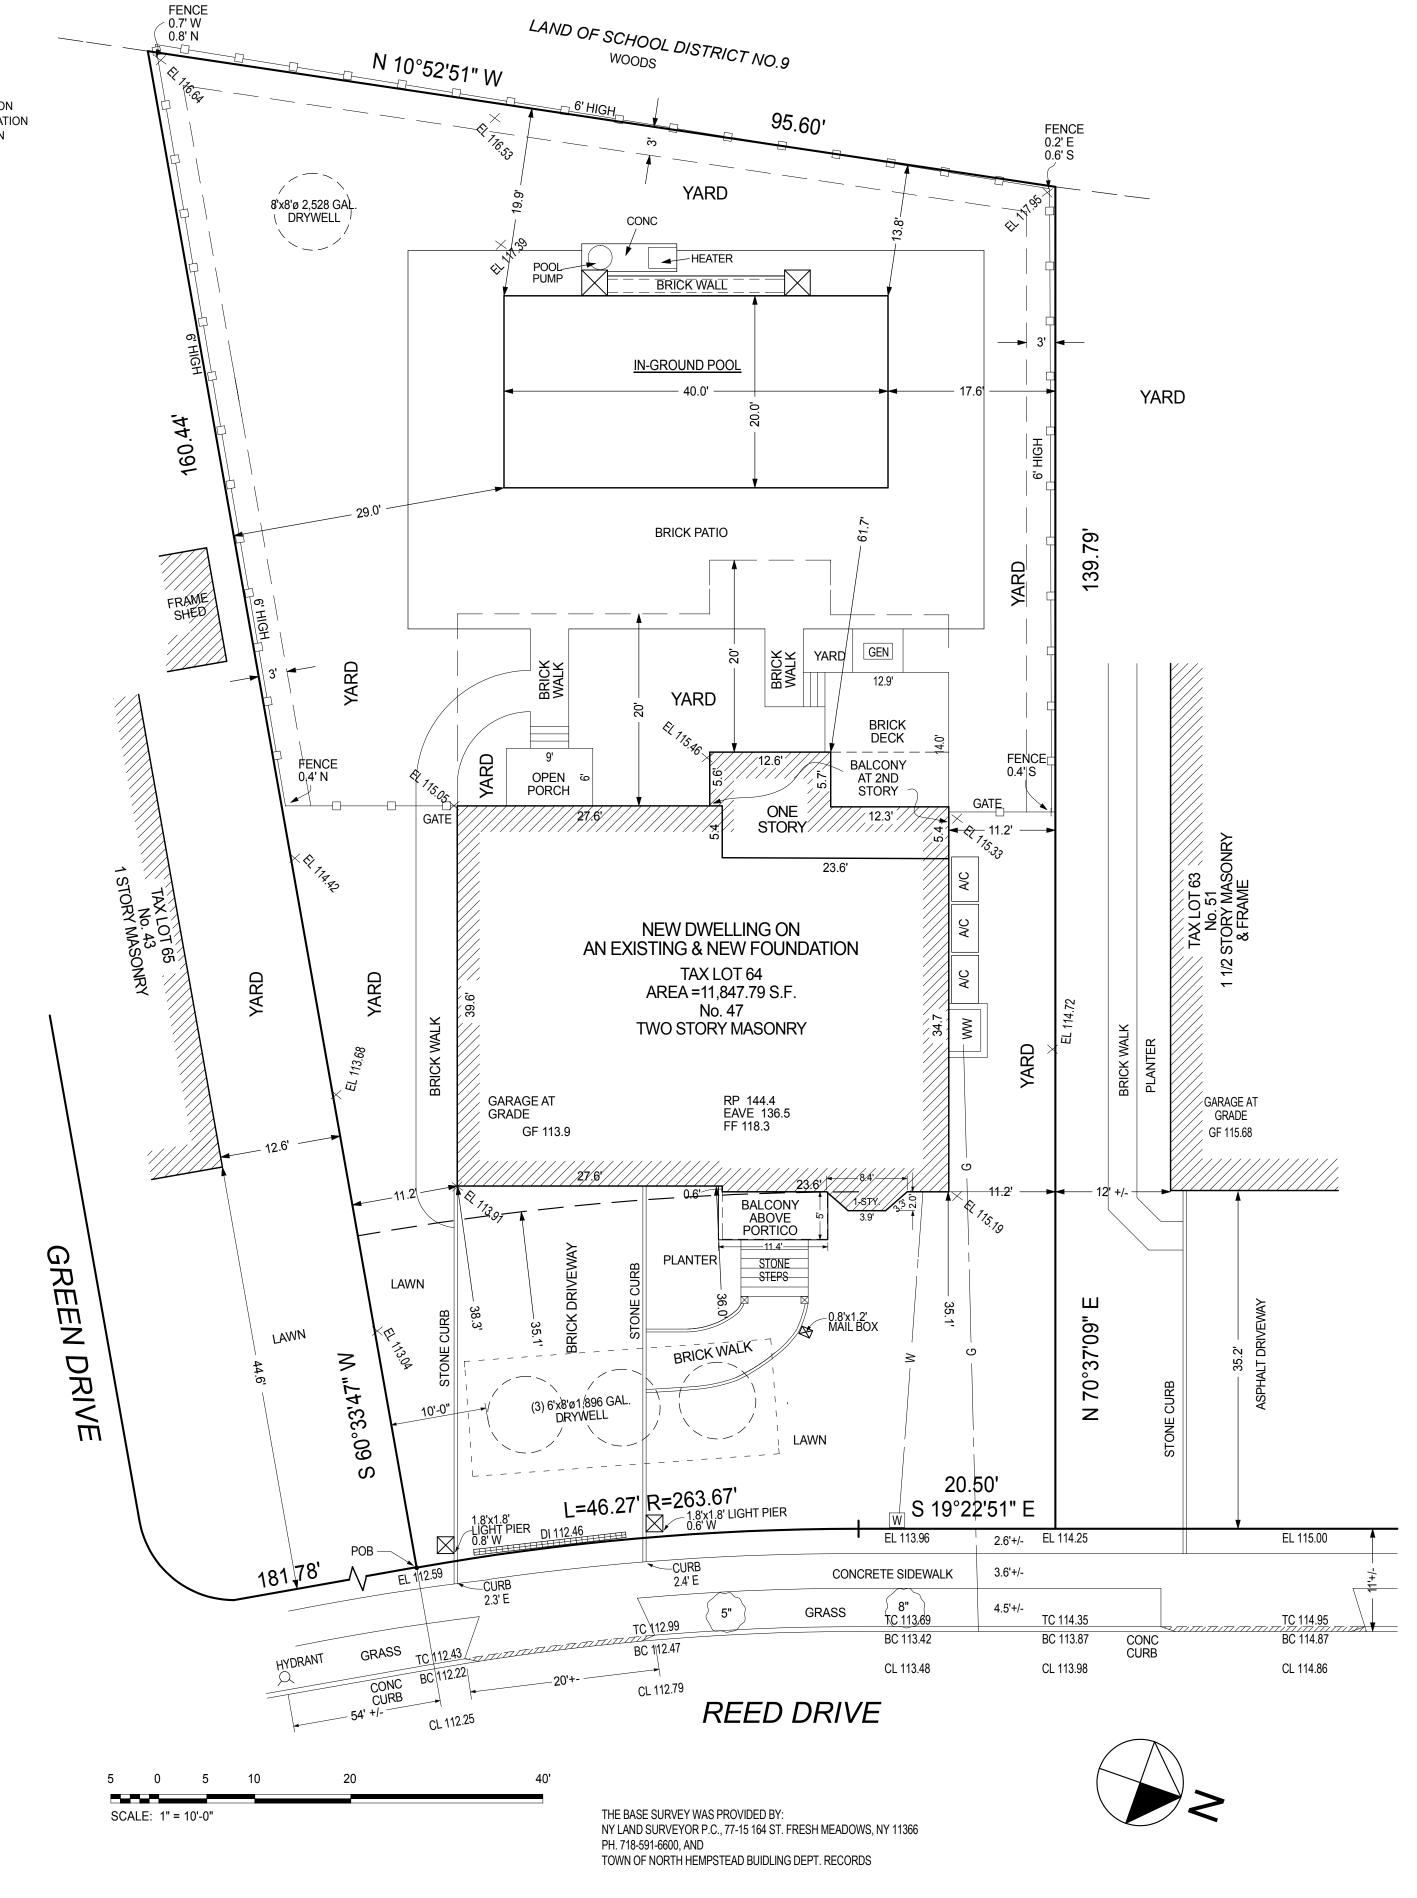

SITE PLAN

SCALE: 1" = 10'-0"

FACADE ARCHITECTURE

ARCHITECTORE

6120 GRAND CENTRAL PKWY, B103, FOREST HILLS NY 11375 347-957-2245 .FACADE3A@GMAIL.COM

PROJECT DESCRIPTION:

EXISTING BUILDING IS A 1 1/2 STORY
SPLIT LEVEL 1 FAMILY DWELLING;
IN THE SOUTH SIDE OF HOUSE IS GARAGE
AND DEN WITH BEDROOMS ABOVE,
NORTH SIDE OF HOUSE IS KITCHEN,
LIVING/DINING AREA WITH CELLAR BELOW.

FILING IS FOR A NEW 2 STORY DWELLING
ON AN EXISTING AND NEW FOUNDATION
WITH ATTACHED PORTICO.
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POOL, FENCING, AIR CONDITIONING
EQUIPMENT AND DRYWELLS.

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PROJECT:

MR. & MRS. SINGH RESIDENCE

47 REED DRIVE ROSLYN NY 11576

TAX SECTION: 9
TAX BLOCK: 653
TAX LOT: 64

FOR:

MR. & MRS. SINGH 80-34 230TH STREET BELLEROSE MANOR, NY 11427

	REVISION	DATE
1	PLANS COMPLYING 03.11.19	05.28.19
	OMMISSIONS LETTER	
2	PLANS COMPLYING 06.18.19	07.22.19
	OMMISSIONS LETTER 2	
3	PLANS COMPLYING 08.03.19	08.19.19
	OMMISSIONS LETTER 3	
4	PLANS COMPLYING 10.23.19	
	OMMISSIONS LETTER 4, POOL	12.02.19
5	TOWN BOARD REVIEW	5.11.22
6	STATE VARIANCE APPLICATION	1.19.23
7	TOWN VARIANCE APPLICATION	7.27.23
8	STATE VARIANCE REAPPLICATION	8.04.23
<u>/</u> 9\	TOWN VARIANCE REAPPLICATION	4.11.24
		•

ISSUED FOR PERMITS: 11/28/18
DRAWN BY: MS
CHECKED. BY: MS
SCALE: AS NOTED

MICHIO SANGA ARCHITECT

SHEET TITLE:

SITE PLAN, ZONING ANALYSIS, DIAGRAM CALCULATION

SHEET NO:

T-1

Tag	Description	DIMS. R.O. W x H	Glass Type	U-Factor	SHGC	Light A. in sq. ft.	Vent A. in sq. ft.	0.A. Area in sq. ft.	Air Leakage	Manufacturer	Notes
1	Casement	3'-0" x 6'-0"	IGU, low-e, clear	0.29	0.29	18	18	18	<0.20 cfm/SF	Pella Windows & Deors	1, 2
2		2'-0" x 4'-0"				8	8	8			1
3		2'-0" x 2'-0"				4	4	4			1
4		3'-0" x 5'-0"				15	15	15			1
5		4'-9" x 6'-0"				29	29	29			1, 2
6		4'-9" x 5'-0"				24	24	24			1, 2
7	Half-Circle Top Picture	4'-9" x 9'-0"		0.27	0.32	40	0	40			1
8	3 Casement combo	6'-0" x 5'-0"		0.29	0.29	30	30	30			1
9	Half-Circle Picture	6'-0" x 3'-0"		0.27	0.32	14	0	14			1
10	Casement	2'-0" x 5'-0"		0.29	0.29	10	10	10			1
11	2 Casement combo	4'-6" x 5'-0"		\	\downarrow	23	23	23			1, 2
12	Half-Circle Top Picture	4'-6" x 2'-3"		0.27	0.32	8	0	8			1, 2
13	Casement	3'-0" x 4'-0"		0.29	0.29	12	12	12			1
14	Casement	3'-0" x 4'-0"		0.29	0.29	12	12	12			1, 2

Notes

- 1. Air leakage: Provide flashing, window dams, expandable foam sealant and caulking at rough opening/window frame joints to create a continuous air barrier with surrounding wall system.
- 2. Emergency escape

Exte	Exterior Door Schedule											
Tag	Description	DIMS. R.O. W X H	Glass Type	U-Factor	SHGC	Infiltration Valuel	0.A. Area in sq. ft.	Light A. in sq. ft.	Vent A. in sq. ft.	Manufacturer	Cat. No.	Notes
1	Fiberglass Raised Panel 1/4 lite Door	(2)3'-0" x 8'-0"	IGU, low-e, clear	0.29	0.27	0.30 cfm/SF *	48.0	12.0	-	Jeld-Wen windows & Doors		1
2	Gliding Patio Door	8'-0" x 6'-11"	IGU, low-e, clear	0.30	0.23	< 0.20 cfm/SF *	54.5	35.9	21.8	Andersen Windows & Doors	FWG80611	1
3	Gliding Patio Door	8'-0" x 8'-0"	IGU, low-e, clear	0.30	0.23	< 0.20 cfm/SF *	63.2	43.0	25.5	Andersen Windows & Doors	FWG8080	1

- 1. Air leakage: Provide flashing, expandable foam sealant and caulking at rough opening/door frame joints to create a continuous air barrier with surrounding wall system.
- * Doors to be fitted with weatherstripping.

Impervious Area Calculation

= 610

Existing Impervious Area:

Walkway on gravel =

Rear walls, light posts = 41 Concrete Patio = 362 Total = 2,970 SF

Proposed Impervious Area:

Driveway on gravel = Walkway on gravel =

Pool patio on gravel =

3,501-2,970 **= 531 SF**

Stone deck, steps = 246

Pool Equip. pad = 108

Portico steps Light piers

Increase:

Driveway

Retaining wall


Deck on gravel

Area "B" (rear one-story) (1) = 5.65 x 12.6 = 71 **Enlarged Diagram with Calculation** $(2) = 23.6 \times 5.4 = 127$ 12.6 1) + 2) = 198 12.3 23.6


Diagram

12.9

4,033

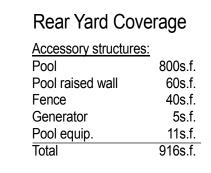

Rear Yard: 5,763s.f. 916 / 5,763 **= 15.9**%

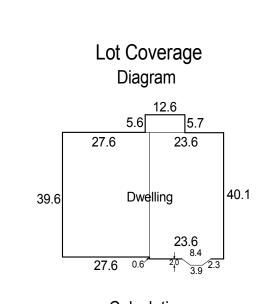

Calculation Dwelling = (27.6x39.6) + (23.6x40.1) $+ \{12.6x(5.6+5.7)/2\} + \{2.0x(8.4+3.9)/2\}$ = 1.093 ÷ 946 + 71 + 12 = 2,122 SF 2,122 / 11,848 Lot Area = **17.9**%

Open porch 9.0 12.6 Open o Roofed over porch $^{\circ}$ ம் | open porch One Story 12.3 27.6 23.6 Two Story 39.6 34.7 3.22 Open to above 0.57 9.8 Second floor 27.6 Corner chamfer $3.22 \times 0.57 / 2 = 1 \text{ s.f.}$ One-story 11.4 Deduct Portico Calculation $(27.60 \times 39.6) + (23.6 \times 34.7) = 1,093 + 819 =$ 1,912 A (main dwelling) B (rear one-story) (See Enlarged Diagram with Calculation) = 198 (8.4+3.9)2.0 / 2 =12 C (front addition) 2,122 First floor total = $(27.60 \times 39.6) + (23.6 \times 34.7) = 1,093 + 819 =$ 1,912 A (main dwelling) deduct corner chamfer 1,911 Second floor total = 11.4 x 5.0 = One-story portico $9.0 \times 6.0 =$ Open porch 12.9 x 14.0 = Open porch

RESIDENCE FRONT YARD = 2,387 SF 20.50' L=46.27'

Calculation

Light piers =

Mailbox pier =

Front Yard = 2,387 SF 893/ 2,387 **= 37.4%**


= 106

REED DRIVE

Portico

Steps Walk

Driveway Total

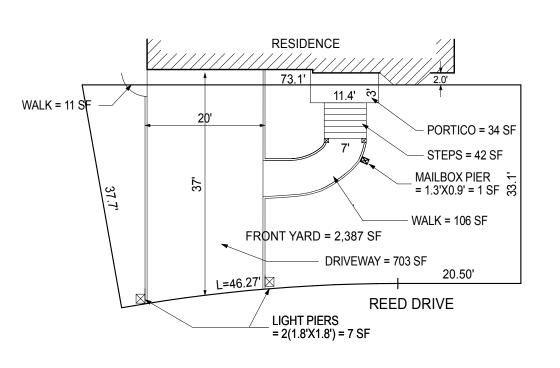


FRONT YARD PAVING plan NOT TO SCALE

GROSS FLOOR AREA DIAGRAM & CALCULATION


Total gross floor area =

NOT TO SCALE

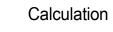

South Side	North Side
$\frac{114.39 + 113.38}{2} = 113.89$	$\frac{115.39 + 114.74}{2} = 115.07$

The average grade at the south side is 113.89' The average grade at the north side is 115.07'

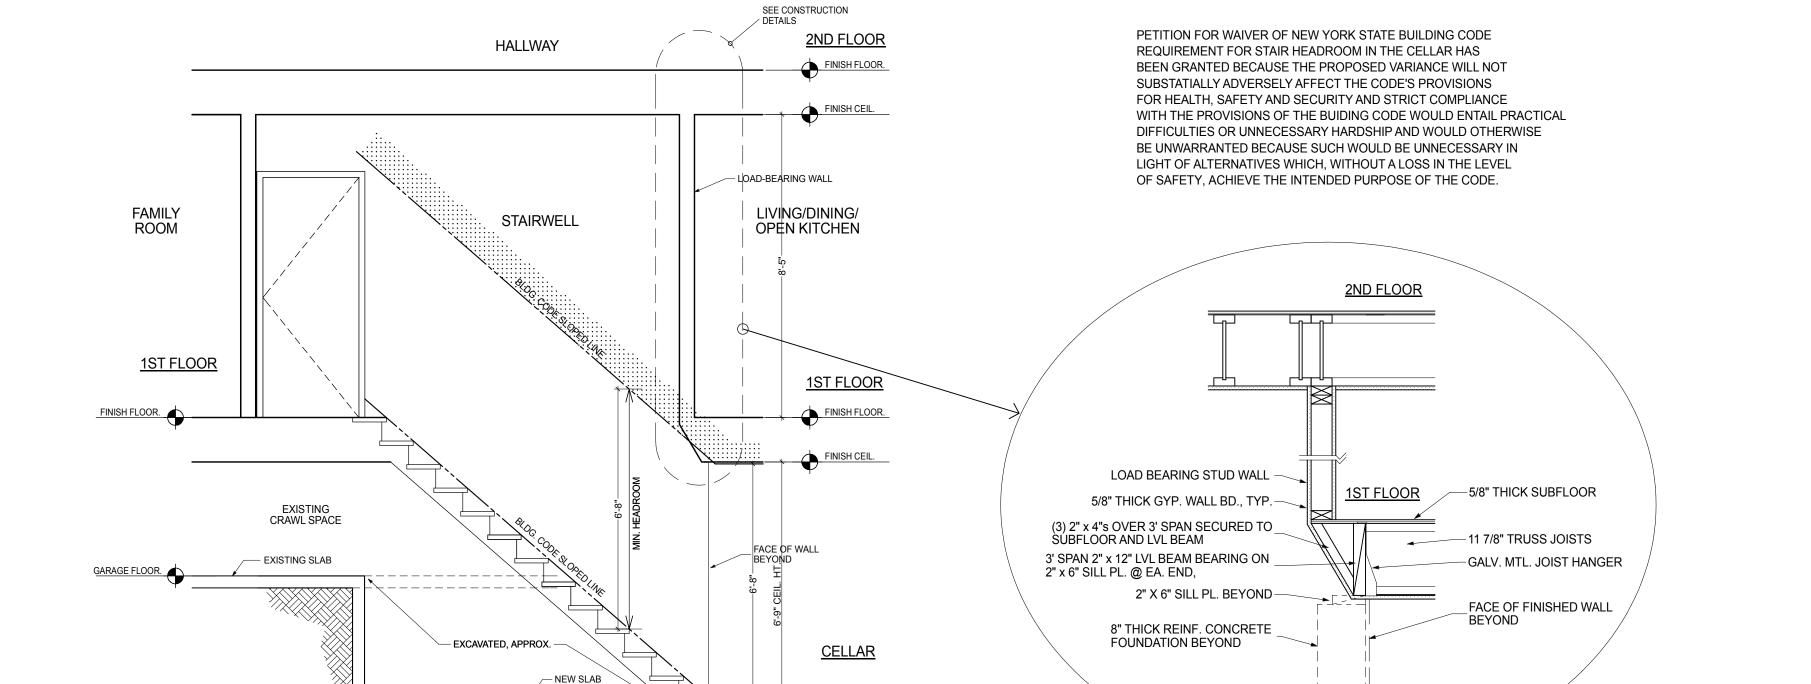

L EL = 114.18 EL=115.40 EL=114.39 I EL = 114.42 EL = 115.39 EL=114.72 - L EL = 113.68 ——11.22'——— —11.76'— Interpolated EL = 114.74 EL = 114.76 L EL = 113.04

PROPERTY LINE GRADE DIAGRAM NOT TO SCALE

FACADE

ARCHITECTURE

ARCHITECTS

6120 GRAND CENTRAL PKWY,

B103, FOREST HILLS NY 11375

347-957-2245

.FACADE3A@GMAIL.COM

PROJECT DESCRIPTION:

SPLIT LEVEL 1 FAMILY DWELLING; IN THE SOUTH SIDE OF HOUSE IS GARAGE AND DEN WITH BEDROOMS ABOVE.

LIVING/DINING AREA WITH CELLAR BELOW.

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MR. & MRS.

SINGH

RESIDENCE

47 REED DRIVE

ROSLYN

NY 11576

653

64

DATE

AS NOTED

TAX SECTION: 9

TAX BLOCK:

MR. & MRS. SINGH

80-34 230TH STREET

REVISION 1 PLANS COMPLYING 03.11.19 OMMISSIONS LETTER 2 PLANS COMPLYING 06.18.19

OMMISSIONS LETTER 2 3 PLANS COMPLYING 08.03.19

OMMISSIONS LETTER 3 4 PLANS COMPLYING 10.23.19 OMMISSIONS LETTER 4, POOL 5 TOWN BOARD REVIEW

6 STATE VARIANCE APPLICATION 7 TOWN VARIANCE APPLICATION

ISSUED FOR PERMITS:

DRAWN BY:

SCALE:

CHECKED. BY:

STATE VARIANCE REAPPLICATION 8.04.23

TOWN VARIANCE REAPPLICATION 4.11.24

MICHIO SANGA

ARCHITECT

BELLEROSE MANOR, NY 11427

TAX LOT:

FOR:

EXISTING BUILDING IS A 1 1/2 STORY

NORTH SIDE OF HOUSE IS KITCHEN,

SHEET TITLE:

GROSS FLOOR AREA CALCULATION, CELLAR STAIR SECTION DIAGRAMS AND CALCULATIONS, WINDOW DOOR SCHEDULE


SHEET NO:


2 OF 11


SECTION STAIR HEADROOM SCALE: 3/8" = 1'-0"

CONSTRUCTION DETAILS SCALE: 3/4" = 1'-0"

<u>CELLAR</u>

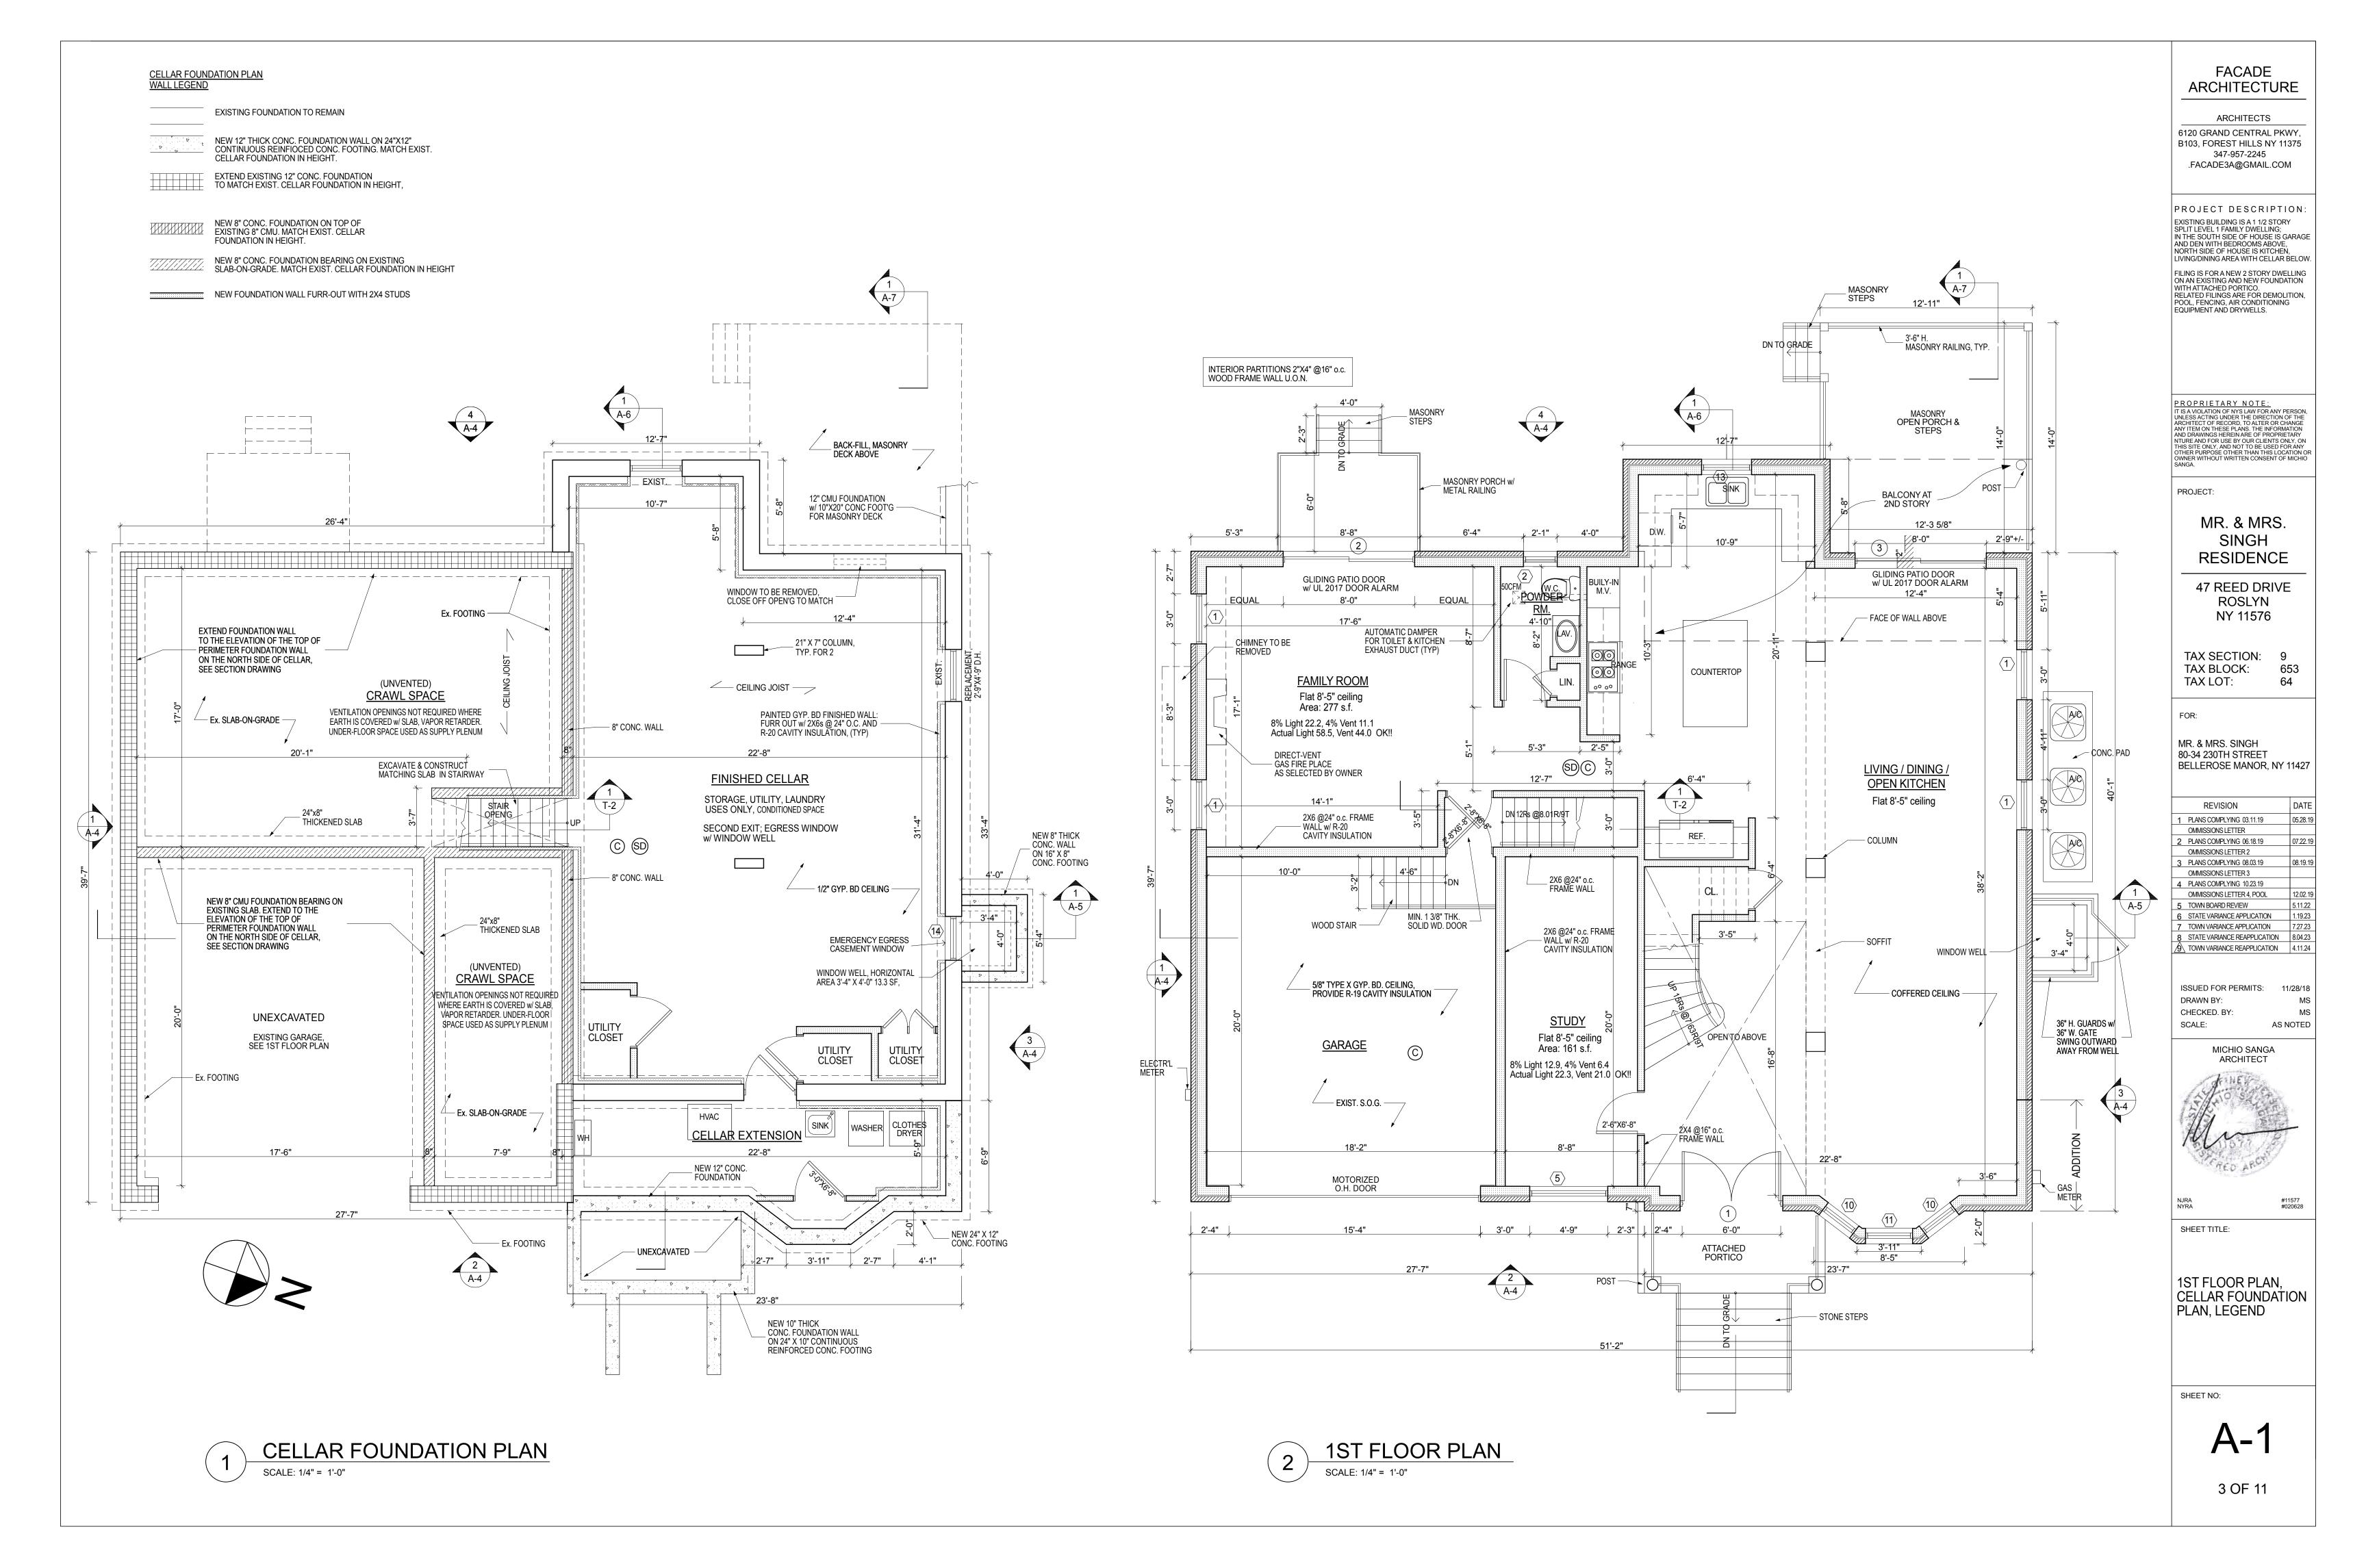

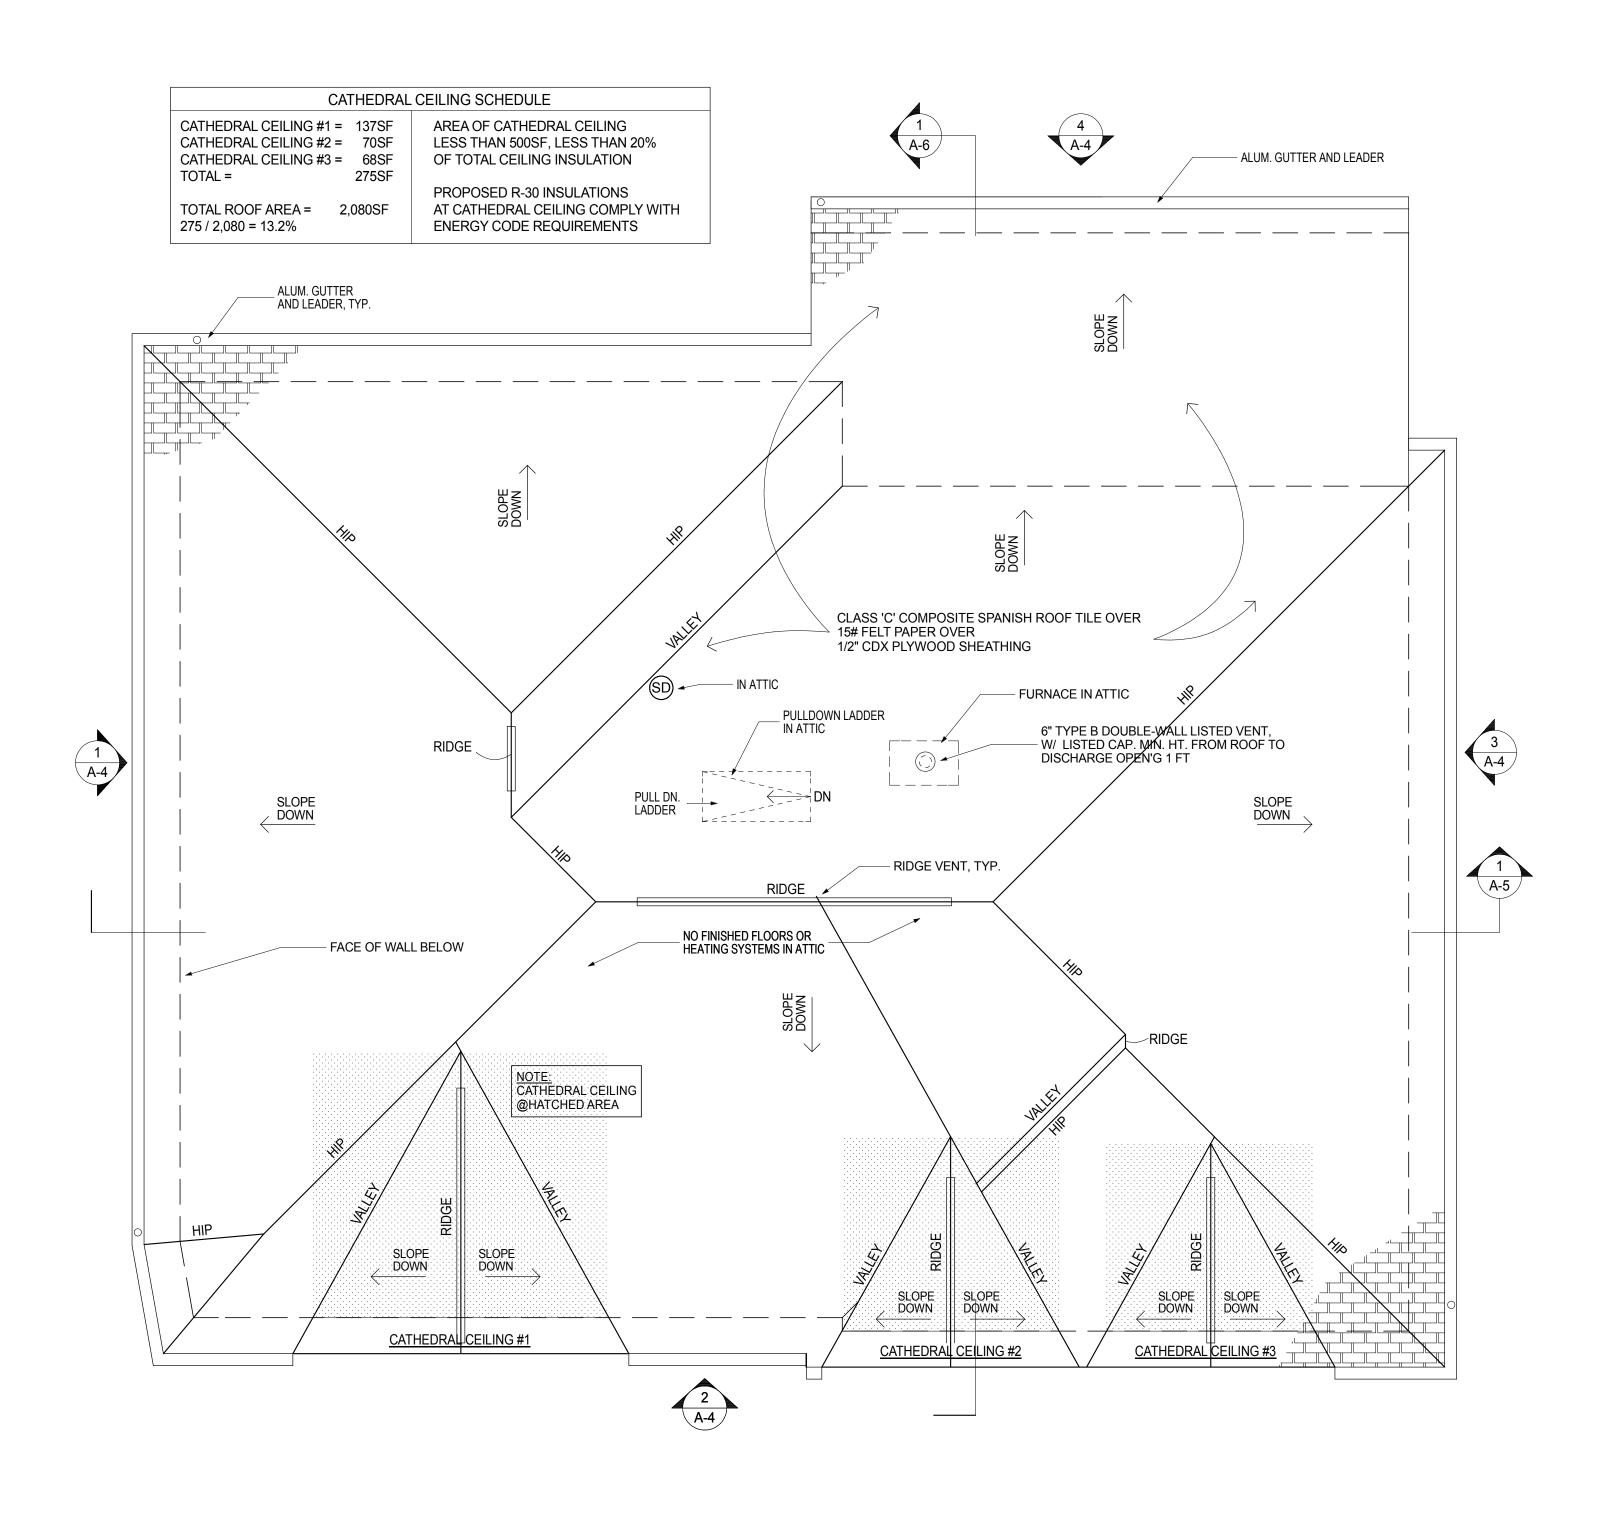

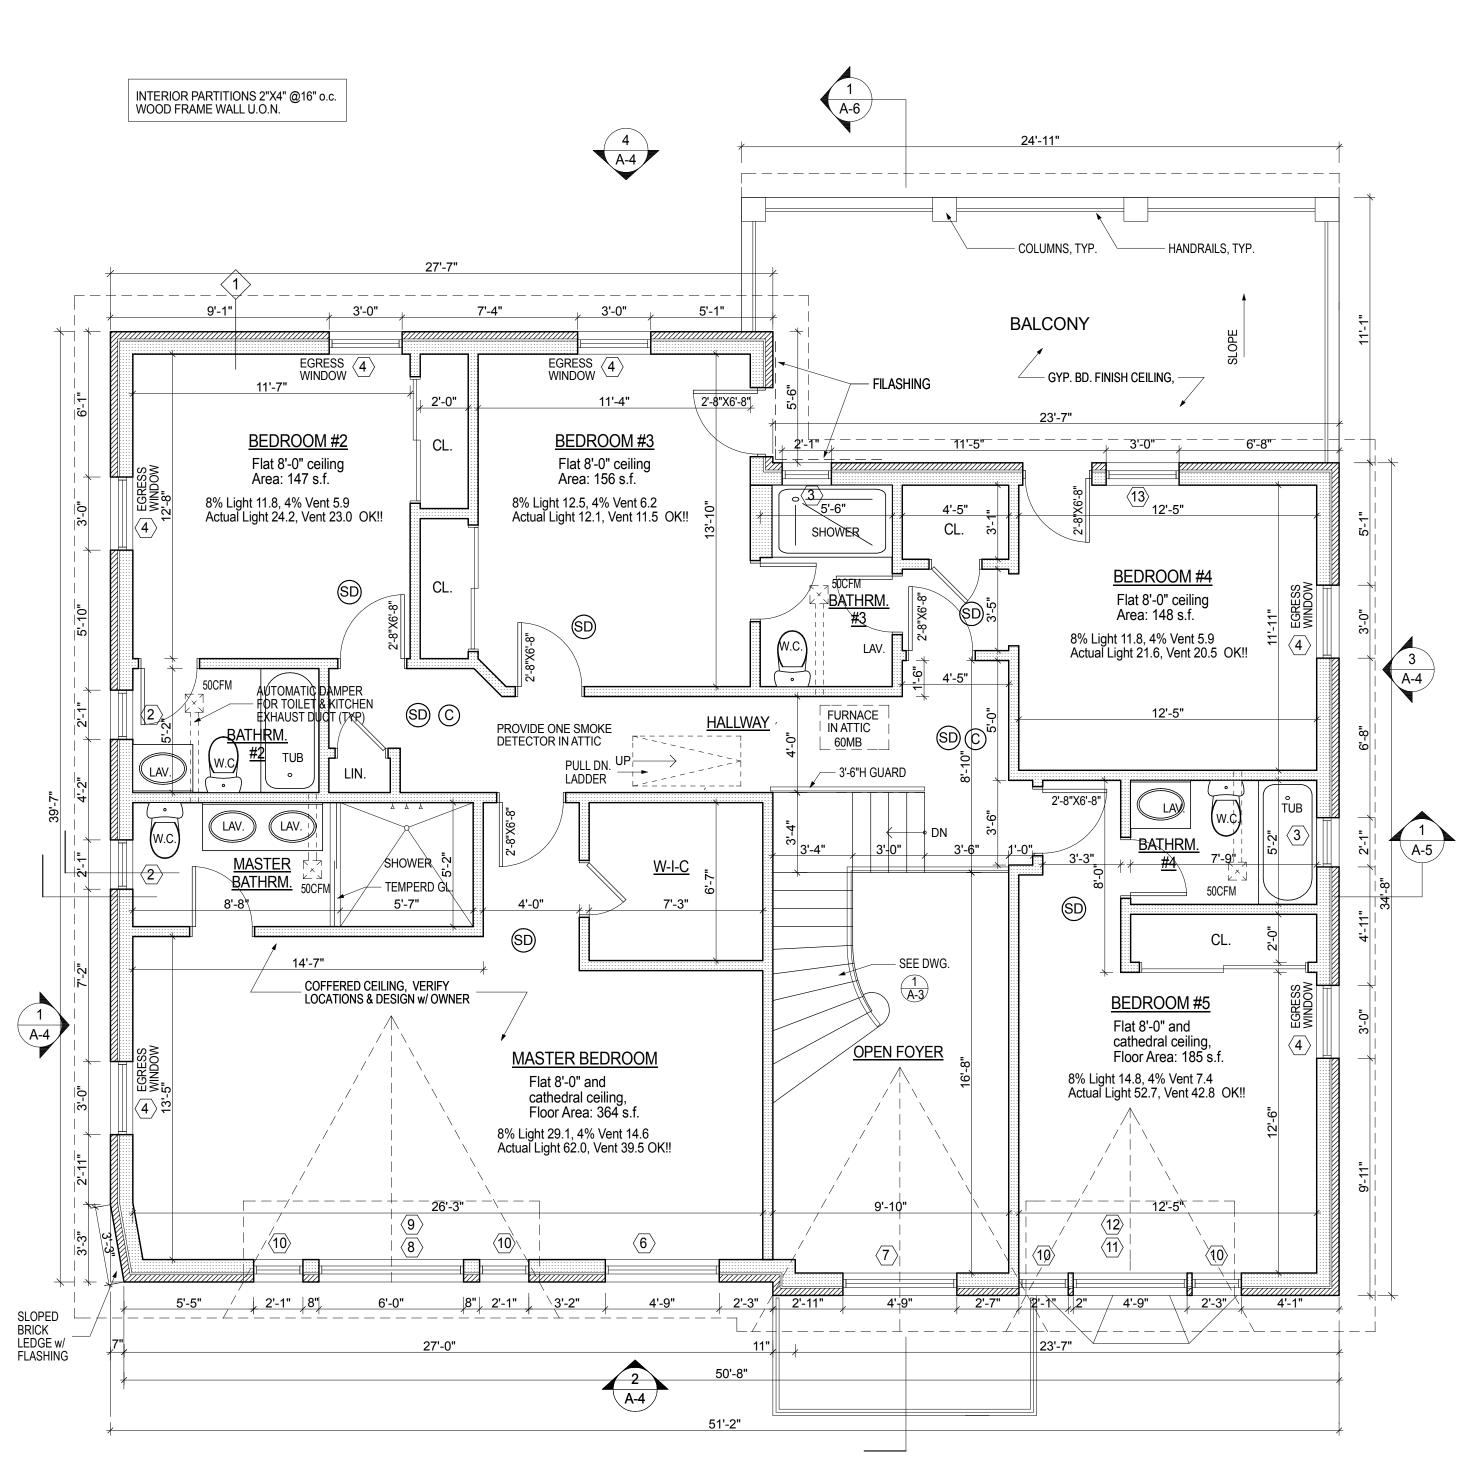

1 ROOF PLAN
SCALE: 1/4" = 1'-0"

2 2ND FLOOR PLAN

SCALE: 1/4" = 1'-0"

FACADE ARCHITECTURE

ARCHITECTS
6120 GRAND CENTRAL PKWY,
B103, FOREST HILLS NY 11375
347-957-2245
.FACADE3A@GMAIL.COM

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OTHER PURPOSE OTHER THAN THIS LOCATION OR
OWNER WITHOUT WRITTEN CONSENT OF MICHIO
SANGA.

PROJECT:

MR. & MRS. SINGH RESIDENCE

47 REED DRIVE ROSLYN NY 11576

TAX SECTION: 9
TAX BLOCK: 653
TAX LOT: 64

FOR:

MR. & MRS. SINGH 80-34 230TH STREET BELLEROSE MANOR, NY 11427

	REVISION	DATE
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8	STATE VARIANCE REAPPLICATION	8.04.23
/9 \	TOWN VARIANCE REAPPLICATION	4.11.24

ISSUED FOR PERMITS: 11/28/18
DRAWN BY: MS
CHECKED. BY: MS
SCALE: AS NOTED

MICHIO SANGA ARCHITECT




NJRA #11577 NYRA #020628

SHEET TITLE:

2ND FLOOR PLAN, ROOF PLAN

SHEET NO:

A-2

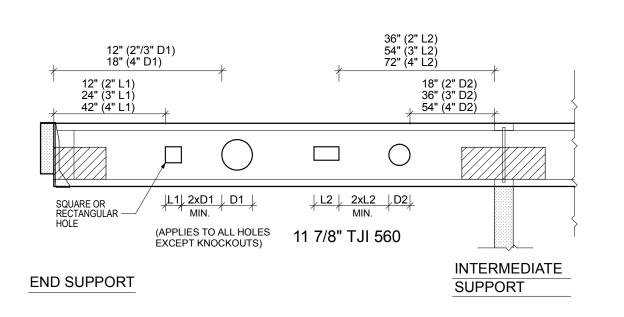

1'-0" (2"/3" D1) 1'-6" (4" D1) 4'-6" (6 1/2" D1) 2'-0" (2" L2) 9'-6" (6 1/2" L2) 3'-6" (3" L2) 11'-0" (8 7/8" L2) 5'-0" (4" L2) 7'-0" (8 7/8" D1) 1'-0" (2"/3" L1) 2'-6" (4" L1) 6'-6" (6 1/2" L1) 1 1/2" HOLE MAY BE CUT – ANYWHERE IN WEB OUTSIDE HATCHED ZONE 7'-0" (6 1/2" D2) 7'-6" (8 7/8" L1) 11'-0" (8 7/8" D2) NO FIELD CUT HOLES IN HATCHED ZONE |L1| 2xD1 | D1 | L2 2xL2 D2 (APPLIES TO ALL HOLES EXCEPT KNOCKOUTS) 11 7/8" TJI 360 INTERMEDIATE **END SUPPORT** SUPPORT

I-JOIST ALLOWABALE HOLES

NOT TO SCALE

LOADING DESIGN

FIRST FLOOR	40#LL + 15#DL	=	55PSF	
SECOND FLOOR	30#LL + 15#DL	=	45PSF	
ATTIC	20#LL + 10#DL	=	30PSF	
ROOF	30#LL + 12#DL	=	43PSF	

WOOD NOTES

- 1. All framing members shall be thoroughly seasoned Douglas fir select structural or southern pine no. 1 grade with a minimum fiber stress grading of 1,400 PSI in bending. All wood girders indicated to have a minimum fiber stress grading of 1,400 PSI U.O.N.
- 2. Grade marked lumber for structural use will bear grade marking when it is delivered to the site as per LL45 and CH23-2303.1.1.
- 3. Structural capacities and design provisions for prefabricated wood I-joists shall be established and monitored in accordance with ASTM D 5055.
- 4. Plywood sheathing shall conform to AF & PA standards for structural use. Sheathing face grain to run across studs, joists or rafters. Plywood shall bear Identification as to grade, type, species or identification.
- 5. Maximum spans for joists and rafters to comply with NFPA 1961 (RS 10.12). All wood construction to comply with section CH23-2308.8.
- 6. The ends of wood beams, joists and rafters resting on masonry or concrete walls shall be fire cut to a bevel of 3" in their depth.
- 7. Wood joists or wood structural floors closer than 18", wood girders closer than 12" or sills closer than 8" to an exposed ground surface within or without the building shall be treated or shall be of an equivalent resistant species per C26-1006.5(B)(4).
- 8. Ends of wood girders entering masonry or concrete walls shall be provided with a minimum 1/2" air space on top, sides, and at the end, unless the girder is treated or is of an equivalent resistant species.
- 9. Provide 1" x 3" bridging for every 8'-0" of span except for wood I-joists. A line of ling or solid blocking shall also be required at supports unless lateral support is provided by nailing to a beam header or the studs. Bridging shall bear securely against and be anchored at the members to be braced.
- 10. Except where supported on a 1' x 4" ribbon strip and nailed on the adjoining studs. The ends of the floor joists shall have at least 11/2" of bearing on wood or metal, nor less than 4" on masonry.
- 11. Joists framing into the side of a wood girder shall be supported by framing anchors, on ledger strips at 2" x 2", or by equivalent methods.
- 12. Roof construction shall be securely anchored to load bearing masonry walls with a minimum $1\!\!\!/2$ " bolts spaced 8" o.c. The bolts shall extend and be embedded a minimum of 15" vertically into the masonry. 13. All interior and exterior stairs
- Max. 8 ¼" Risers min. 9" Treads + 1 1/4" nosing (with closed risers).
- 14. Provide at least 2 1/4" of solid masonry under joists and at least 4" under beams & girders. Bearing of joists or beams shall extend into the masonry at least 4".
- 15. Do not notch or cut into any structural members unless specifically shown on drawings. 16. All bearing partitions, if any, are to be of 2" x 4" studs at 16" o.c. with double studs at ends of openings between 3'-5" and 6'-0" and triple studs at ends of openings of greater width, 2"x4" sill plates and 2-2" x 4" top plates. Double beams solid bridging shall be used under bearing partitions.
- 17. All non-bearing partition to be 2" x 4" studs at 16" o.c. or 2 ½" metal studs per owners
- 18. Headers, trimmers, and joists under partitions, all openings in roofs and around all stairwells are to be doubled.
- 19. Double studs, posts, joists, and or rafters are to be thoroughly spiked or bolted together (min. 16d nails at 12" o.c.).
- 20. All wood in contact with concrete, concrete foundations and piers, exterior wood decking and any exterior stair posts, stringers, threads, and thread cleats, wood fascia in other than the vertical plane is to pressure impregnated with waterborne wood preservative.
- 21. All wood beams, joists and studs shall be frames away from chimneys. Headers, beams. joists and studs shall be at least 2" from the outside face of walls.


WALL LEGEND

EXISTING FOUNDATION TO REMAIN


NEW 12" THICK CONC. FOUNDATION WALL ON 24"X12" CONTINUOUS REINFIOCED CONC. FOOTING. MATCH EXIST. CELLAR FOUNDATION IN HEIGHT.

EXTEND EXISTING 12" CONC. FOUNDATION TO MATCH EXIST. CELLAR FOUNDATION IN HEIGHT,

NEW 8" CONC. FOUNDATION ON TOP OF EXISTING 8" CMU. MATCH EXIST. CELLAR FOUNDATION IN HEIGHT. NEW 8" CONC. FOUNDATION BEARING ON EXISTING

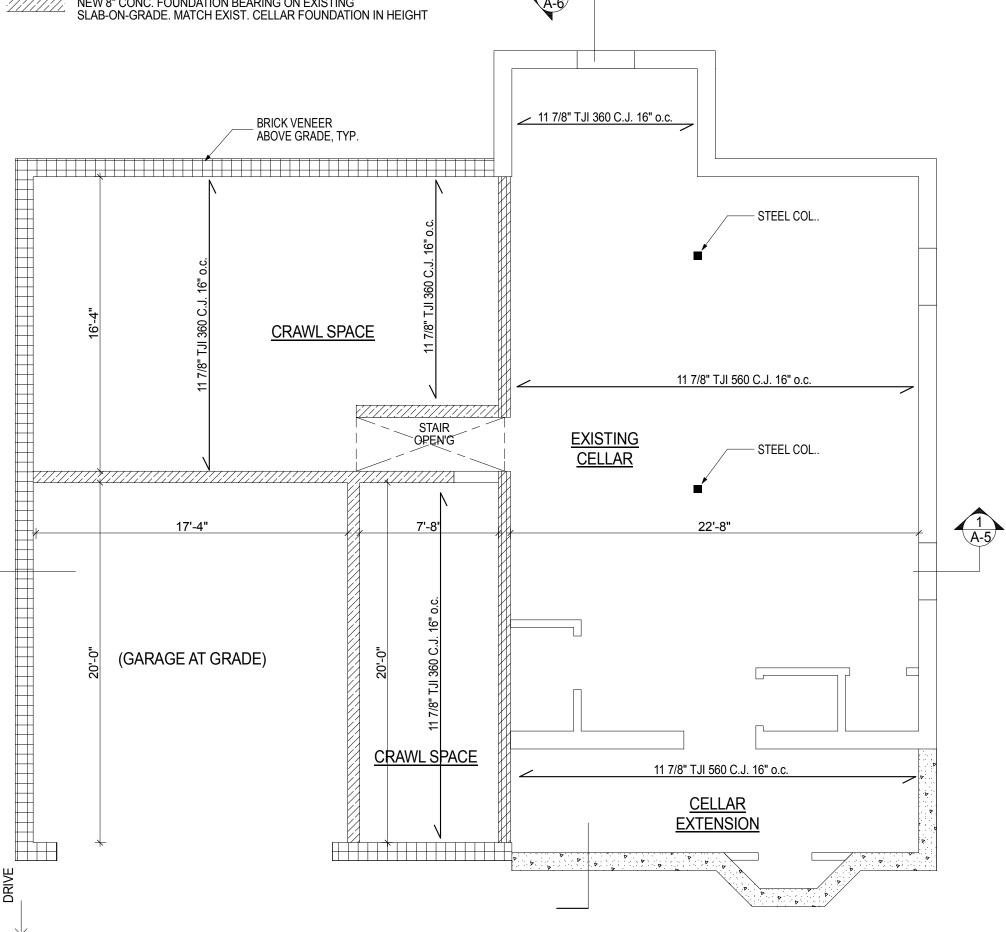


1ST FL. STRUCTURAL FRAMING PLAN SCALE: 3/16"= 1'-0"

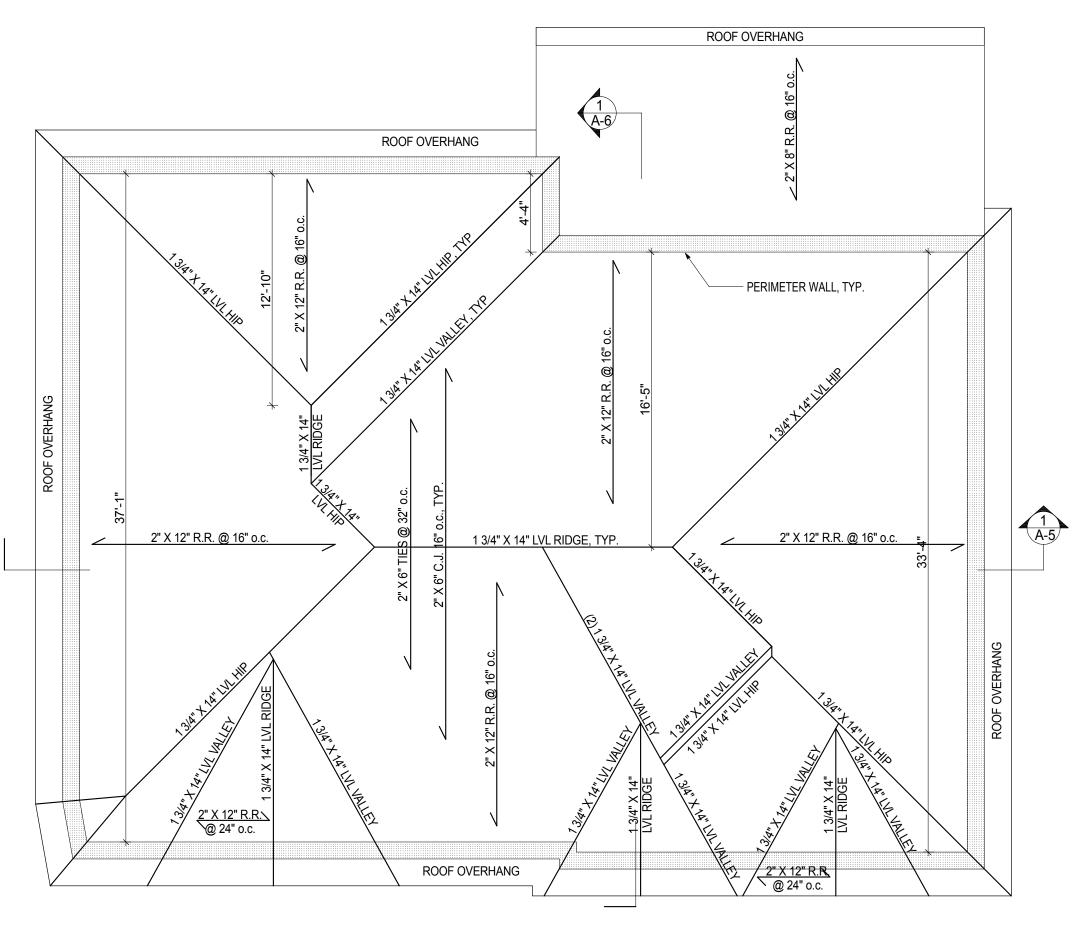

ROOF STRUCTURAL FRAMING PLAN

SCALE: 3/16"= 1'-0"

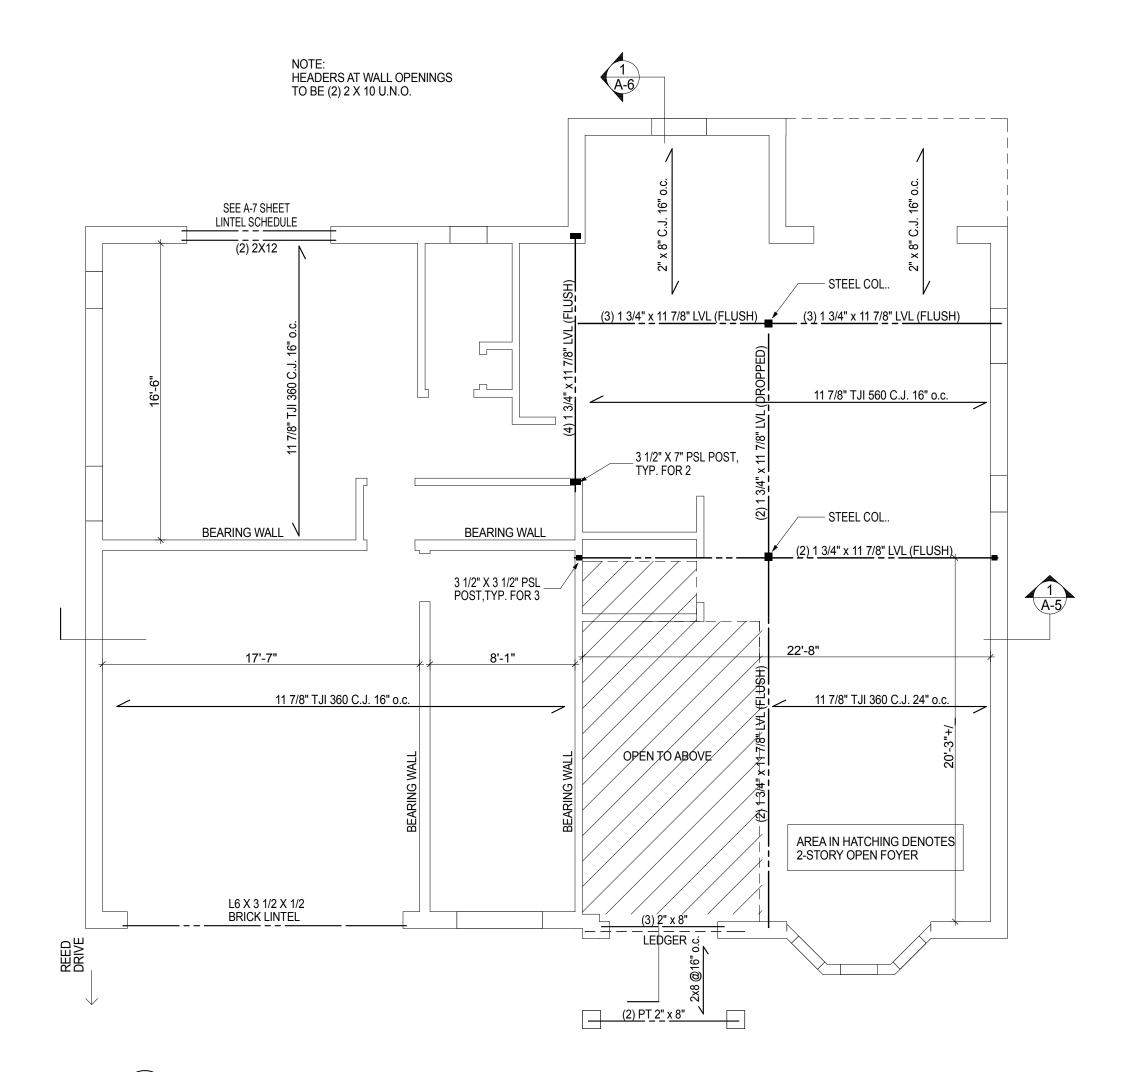

2ND FL. STRUCTURAL FRAMING PLAN SCALE: 3/16"= 1'-0"

FACADE ARCHITECTURE

ARCHITECTS 6120 GRAND CENTRAL PKWY, B103, FOREST HILLS NY 11375 347-957-2245 .FACADE3A@GMAIL.COM

PROJECT DESCRIPTION: EXISTING BUILDING IS A 1 1/2 STORY SPLIT LEVEL 1 FAMILY DWELLING; IN THE SOUTH SIDE OF HOUSE IS GARAGE AND DEN WITH BEDROOMS ABOVE, NORTH SIDE OF HOUSE IS KITCHEN, LIVING/DINING AREA WITH CELLAR BELOW FILING IS FOR A NEW 2 STORY DWELLING

ON AN EXISTING AND NEW FOUNDATION

RELATED FILINGS ARE FOR DEMOLITION, POOL, FENCING, AIR CONDITIONING

WITH ATTACHED PORTICO

EQUIPMENT AND DRYWELLS.

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SANGA.

PROJECT:

MR. & MRS. SINGH RESIDENCE

47 REED DRIVE **ROSLYN** NY 11576

TAX SECTION: TAX BLOCK: TAX LOT:

MR. & MRS. SINGH 80-34 230TH STREET BELLEROSE MANOR, NY 11427

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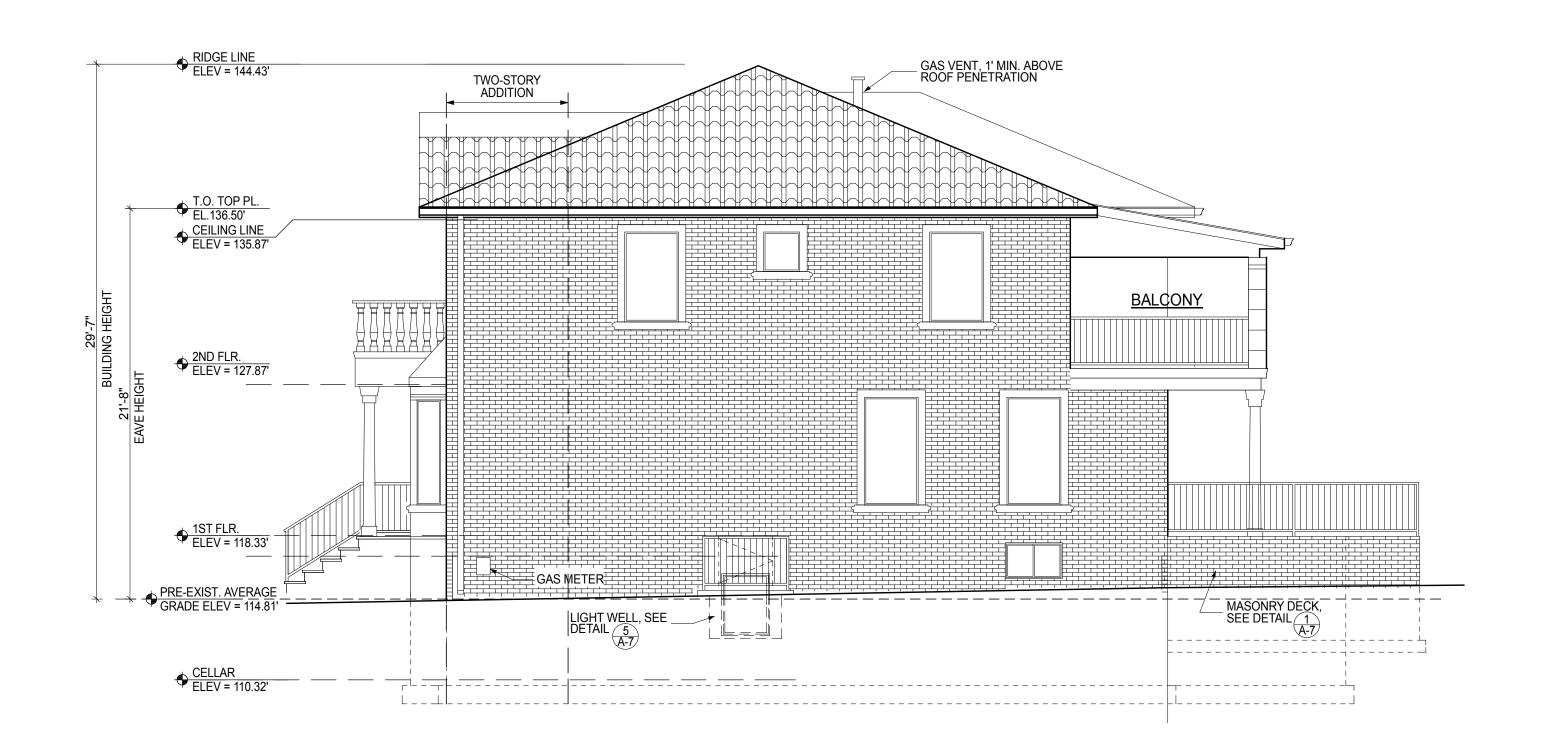
ISSUED FOR PERMITS: 11/28/18 DRAWN BY: CHECKED. BY: SCALE: AS NOTED


MICHIO SANGA ARCHITECT

SHEET TITLE:

STRUCTURAL FRAMING PLANS, I-JOIST ALLOWABLE HOLES DETAIL, LOADING DESIGN TABLE, NOTES


SHEET NO:



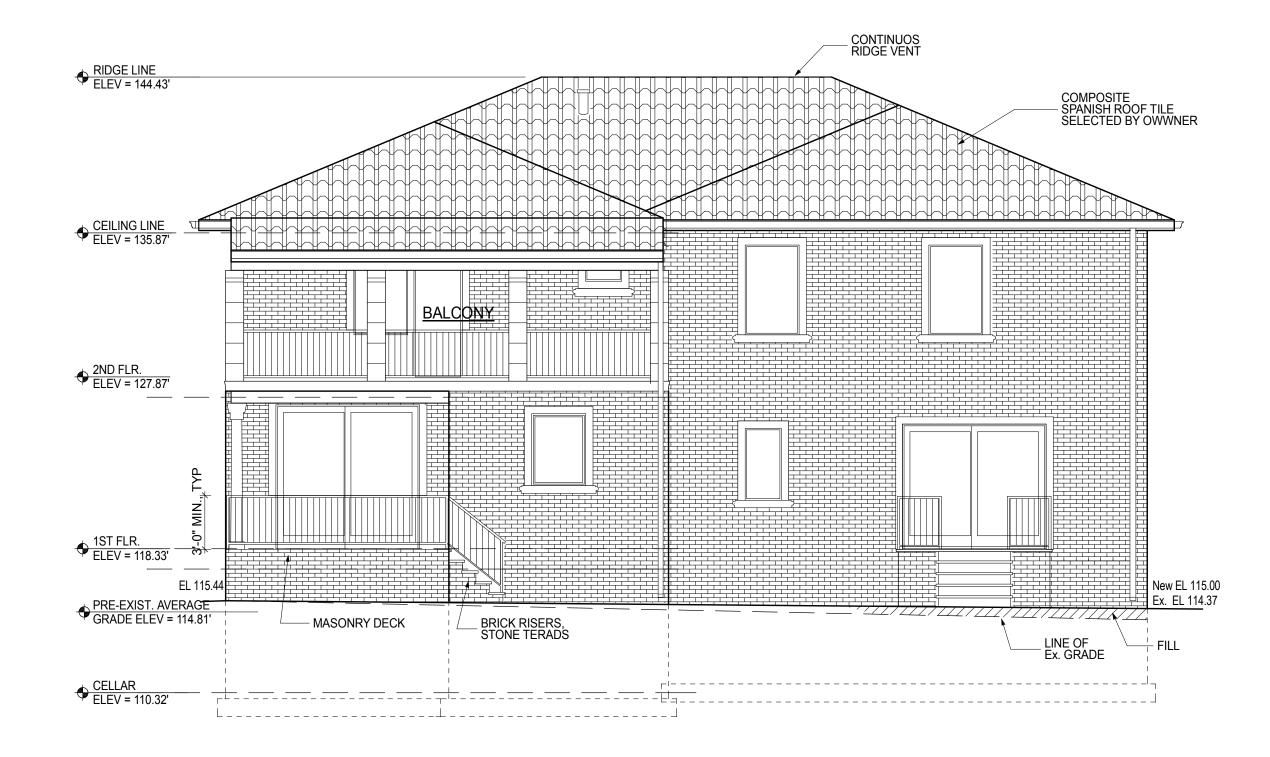

4 REAR ELEVATION

SCALE: 3/16"= 1'-0"

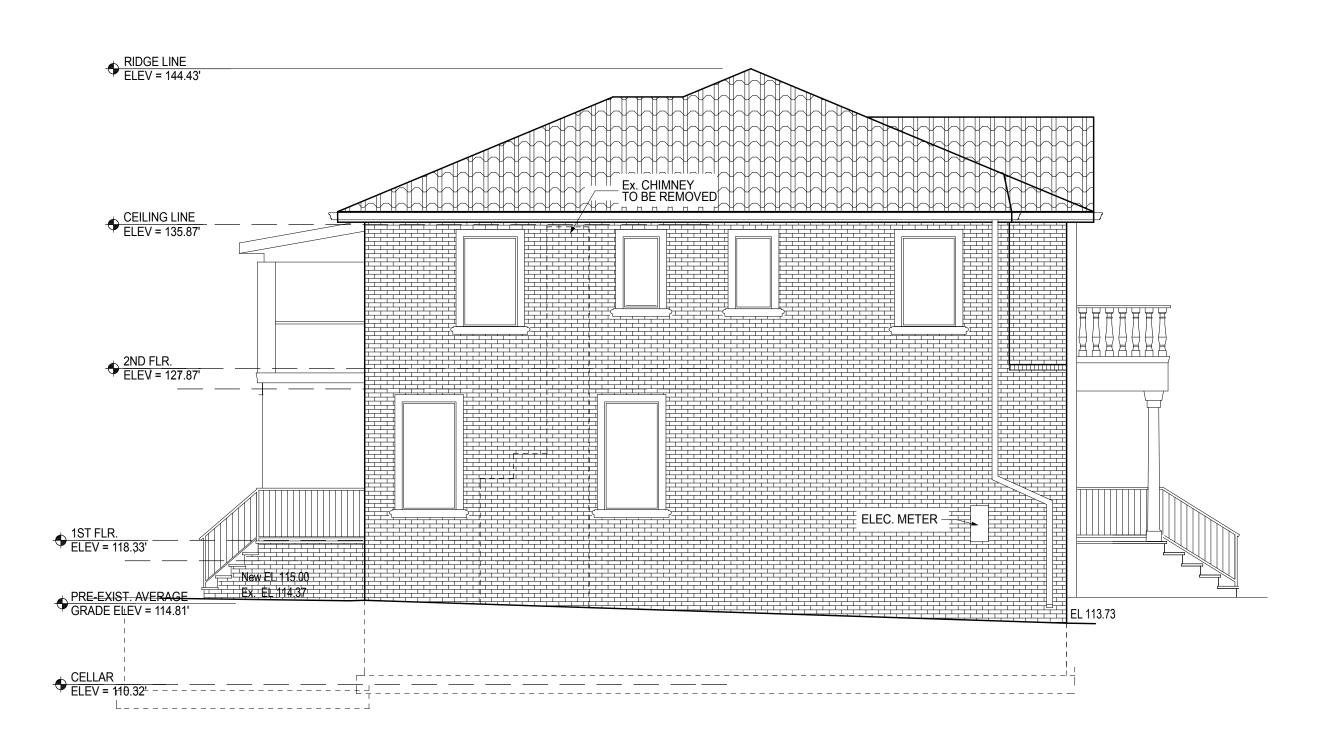




1 LEFT SIDE ELEVATION

SCALE: 3/16"= 1'-0"

RIGHT SIDE ELEVATION

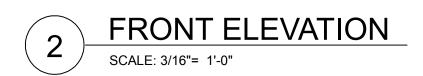

FACADE ARCHITECTURE

ARCHITECTS
6120 GRAND CENTRAL PKWY,
B103, FOREST HILLS NY 11375
347-957-2245
.FACADE3A@GMAIL.COM

PROJECT DESCRIPTION:

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IN THE SOUTH SIDE OF HOUSE IS GARAGE
AND DEN WITH BEDROOMS ABOVE,
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LIVING/DINING AREA WITH CELLAR BELOW.

FILING IS FOR A NEW 2 STORY DWELLING
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PROJECT:

MR. & MRS. SINGH RESIDENCE

47 REED DRIVE ROSLYN NY 11576

TAX SECTION: 9
TAX BLOCK: 65
TAX LOT: 64

FO

MR. & MRS. SINGH 80-34 230TH STREET BELLEROSE MANOR, NY 11427

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ISSUED FOR PERMITS: 11/28/18
DRAWN BY: MS
CHECKED. BY: MS
SCALE: AS NOTED

MICHIO SANGA ARCHITECT


IRA ⁄RA

SHEET TITLE:

ELEVATIONS

SHEET NO:

A-4

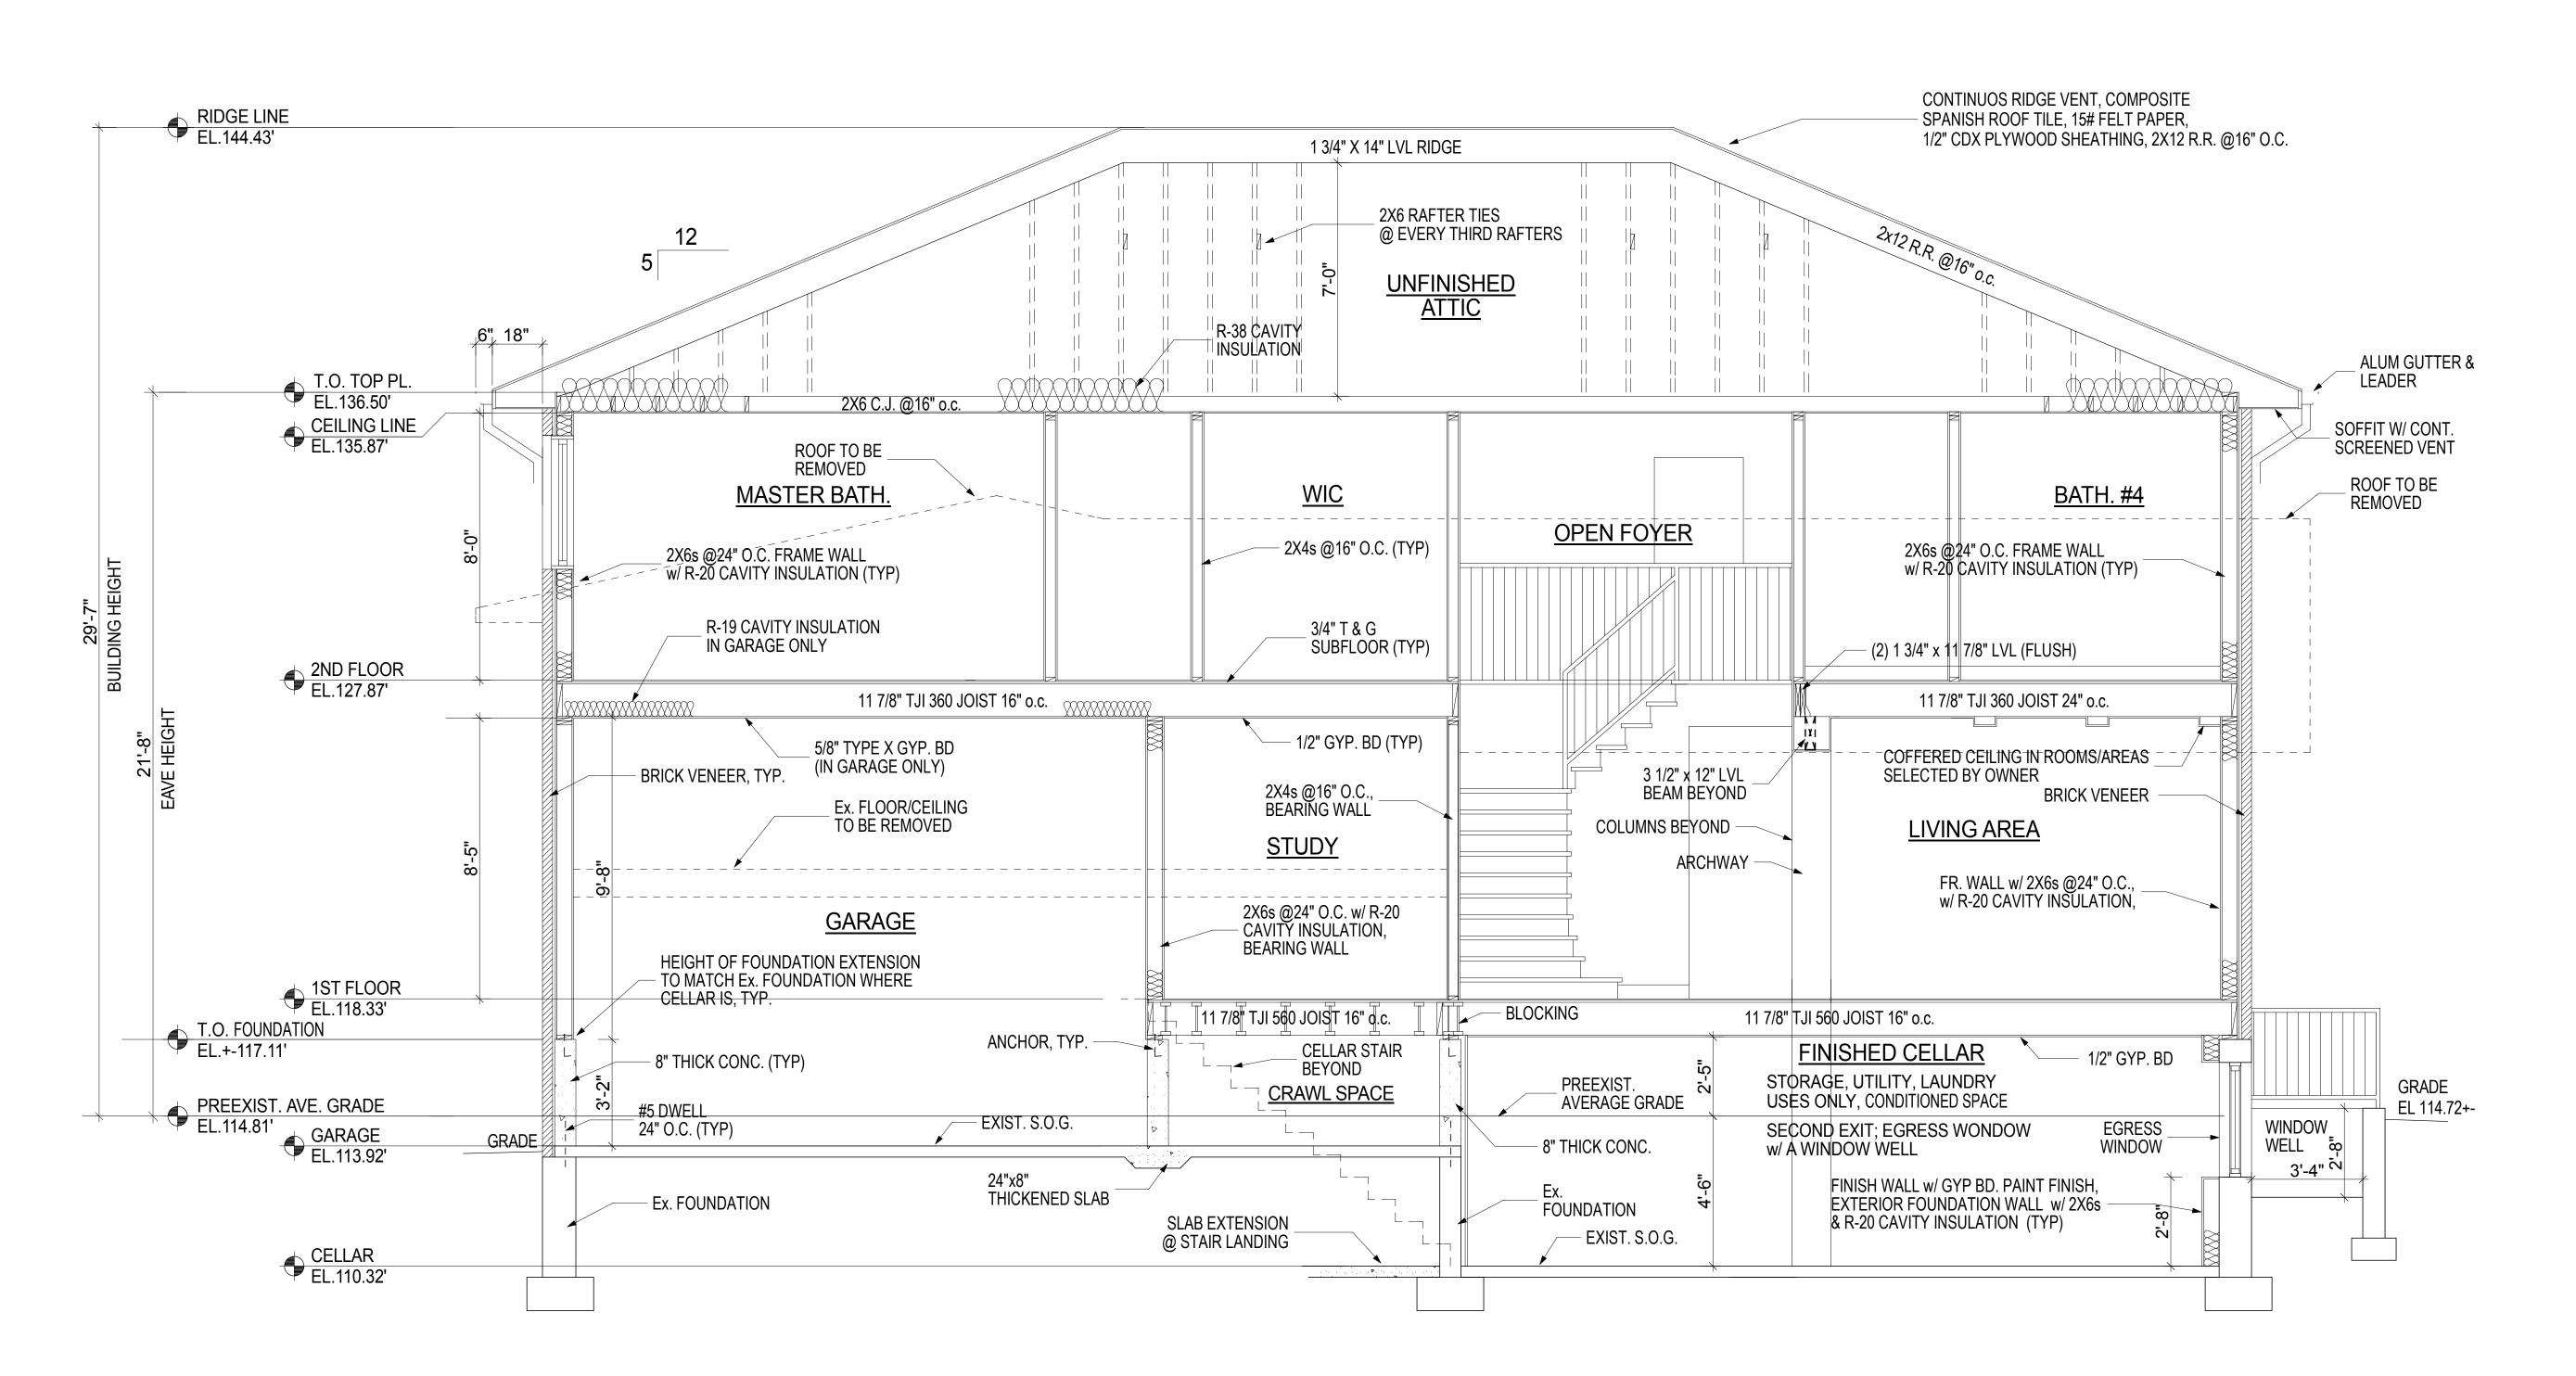

SECTION FROM LEFT TO RIGHT SCALE: 3/8" = 1'-0"

FACADE ARCHITECTURE

ARCHITECTS 6120 GRAND CENTRAL PKWY, B103, FOREST HILLS NY 11375 347-957-2245 .FACADE3A@GMAIL.COM

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PROJECT:

MR. & MRS. SINGH RESIDENCE

47 REED DRIVE ROSLYN NY 11576

TAX SECTION: 9 TAX BLOCK: 653 TAX LOT:

FOR:

MR. & MRS. SINGH 80-34 230TH STREET BELLEROSE MANOR, NY 11427

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ISSUED FOR PERMITS: 11/28/18 DRAWN BY: CHECKED. BY: AS NOTED SCALE:

> MICHIO SANGA ARCHITECT




#11577 #020628

SHEET TITLE:

BUILDING SECTION

SHEET NO:

A-5

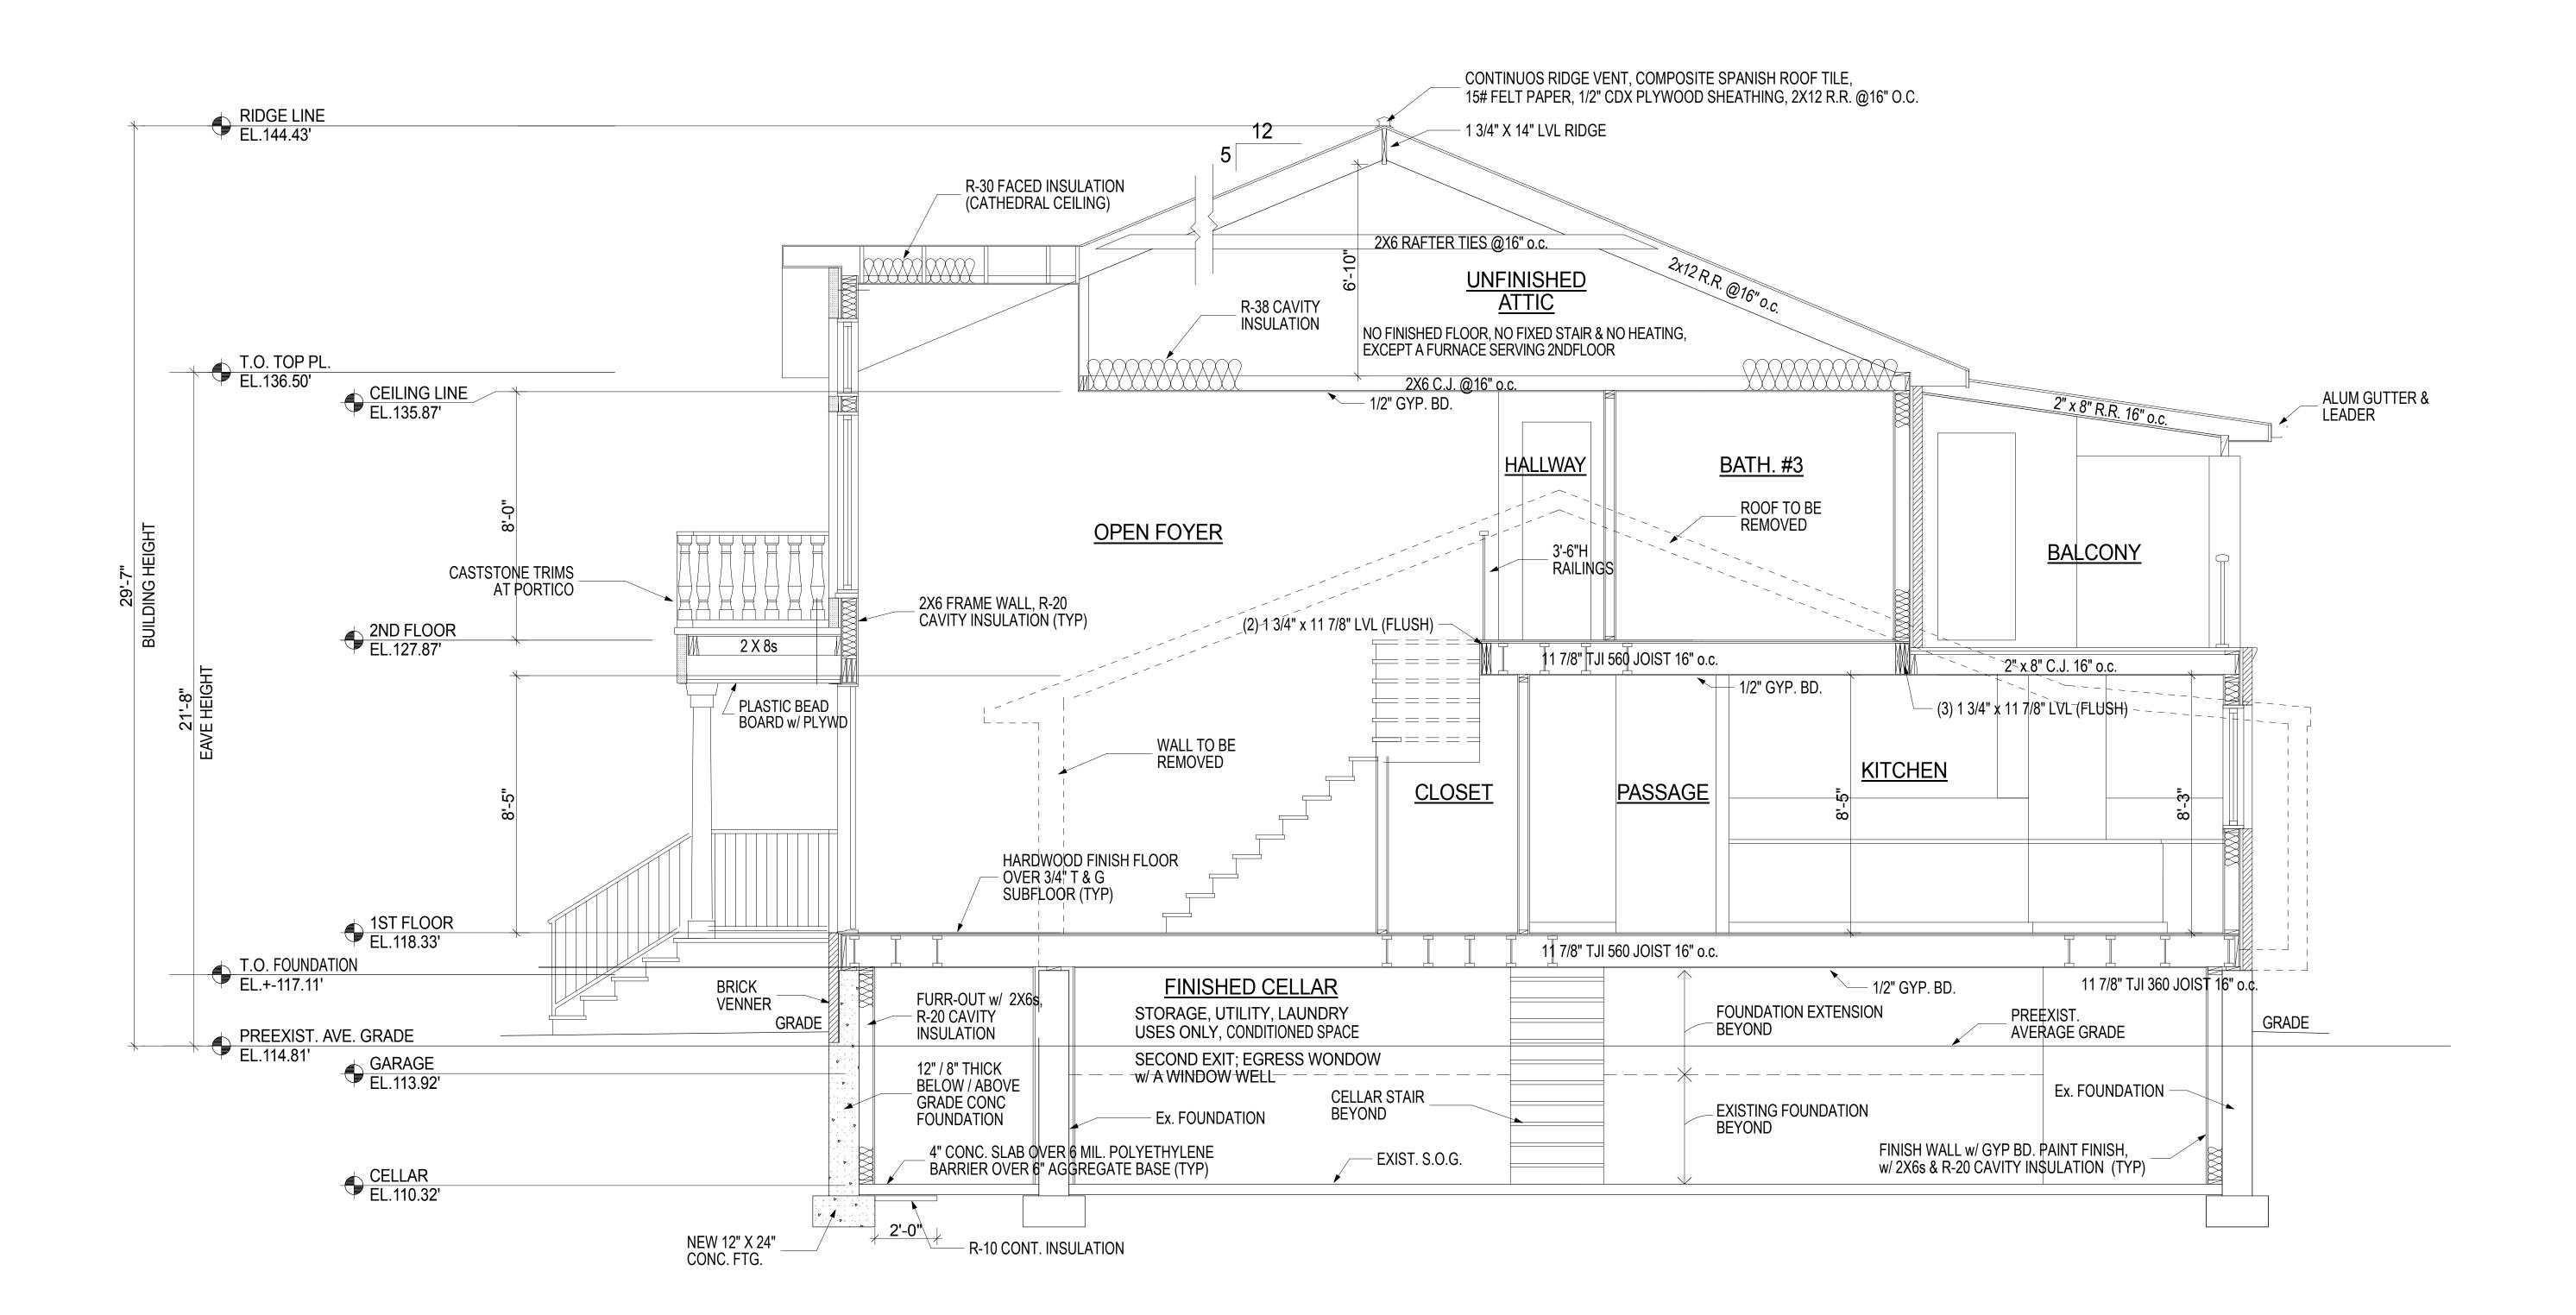

1 SECTION, FROM FRONT TO REAR SCALE: 3/8" = 1'-0"

FACADE ARCHITECTURE

ARCHITECTS
6120 GRAND CENTRAL PKWY,
B103, FOREST HILLS NY 11375
347-957-2245
.FACADE3A@GMAIL.COM

PROJECT DESCRIPTION:

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PROJECT:

MR. & MRS. SINGH RESIDENCE

47 REED DRIVE ROSLYN NY 11576

TAX SECTION: 9
TAX BLOCK: 653
TAX LOT: 64

FOR:

MR. & MRS. SINGH 80-34 230TH STREET BELLEROSE MANOR, NY 11427

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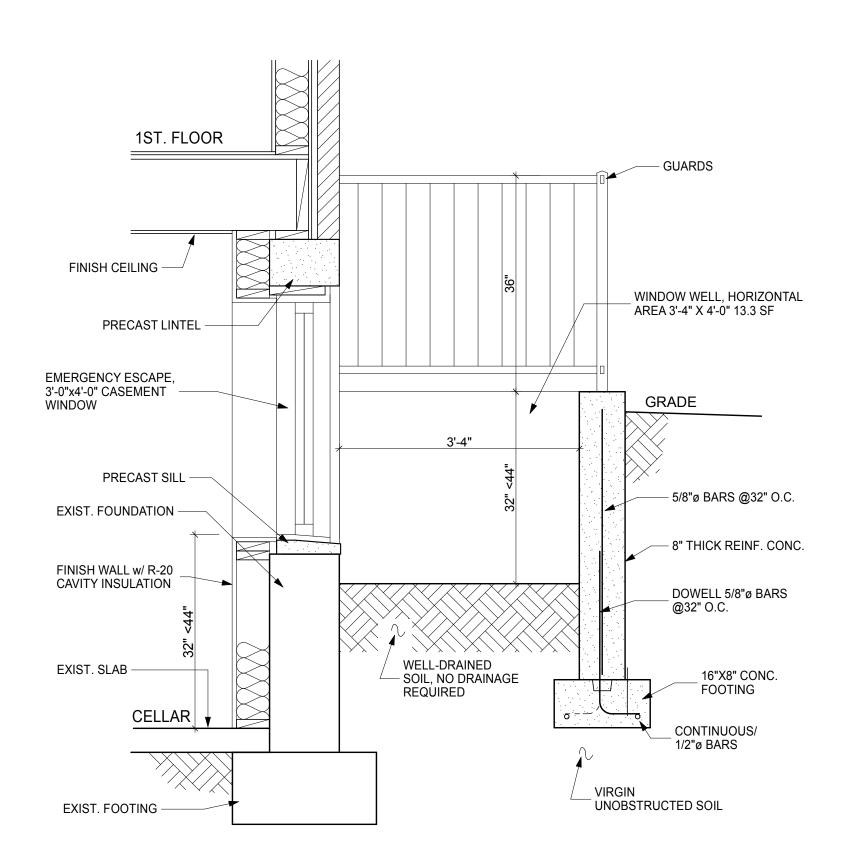


NJRA NYRA SHEET TITLE:


BUILDING SECTION


SHEET NO:

A-6





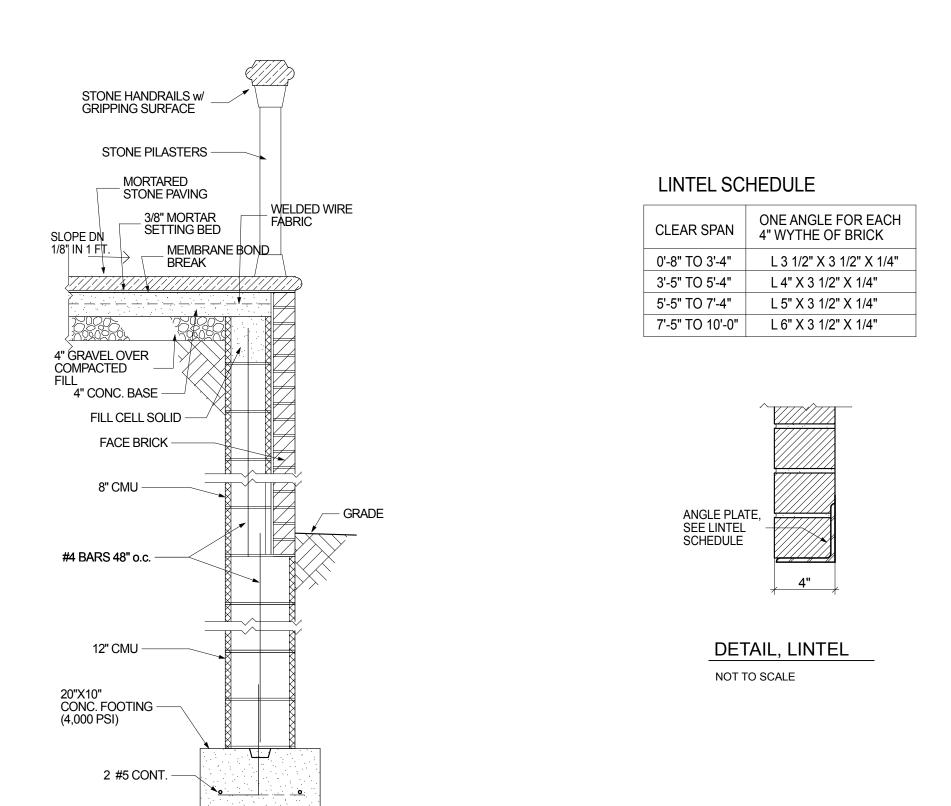

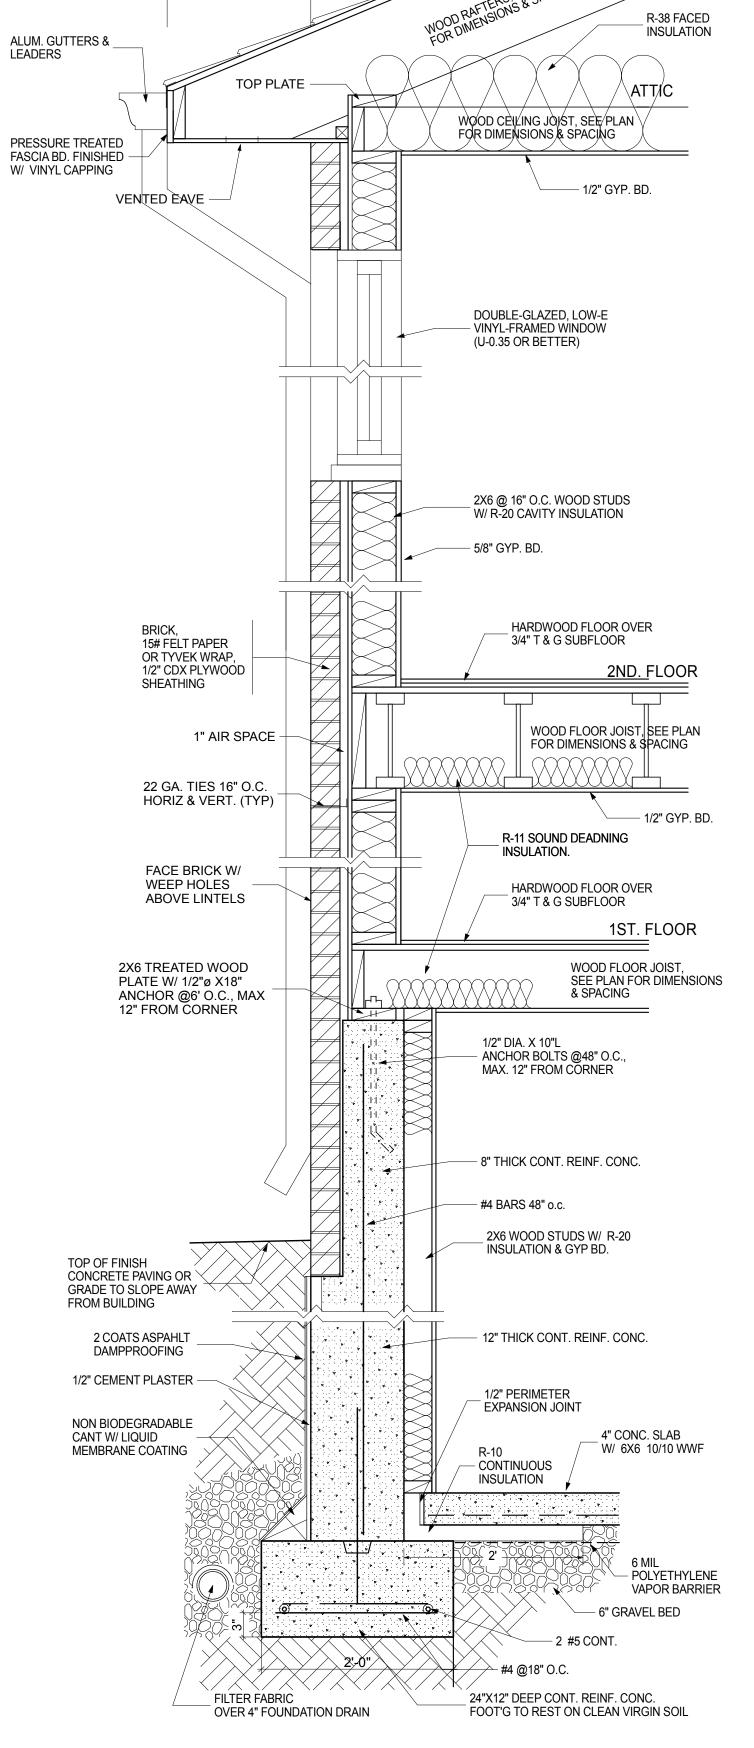



CONTINUOS RIDGE VENT, COMPOSITE SPANISH ROOF TILE,


1/2" CDX PLYWOOD SHEATHING,

15# FELT PAPER,

2X12 R.R. @16" O.C.

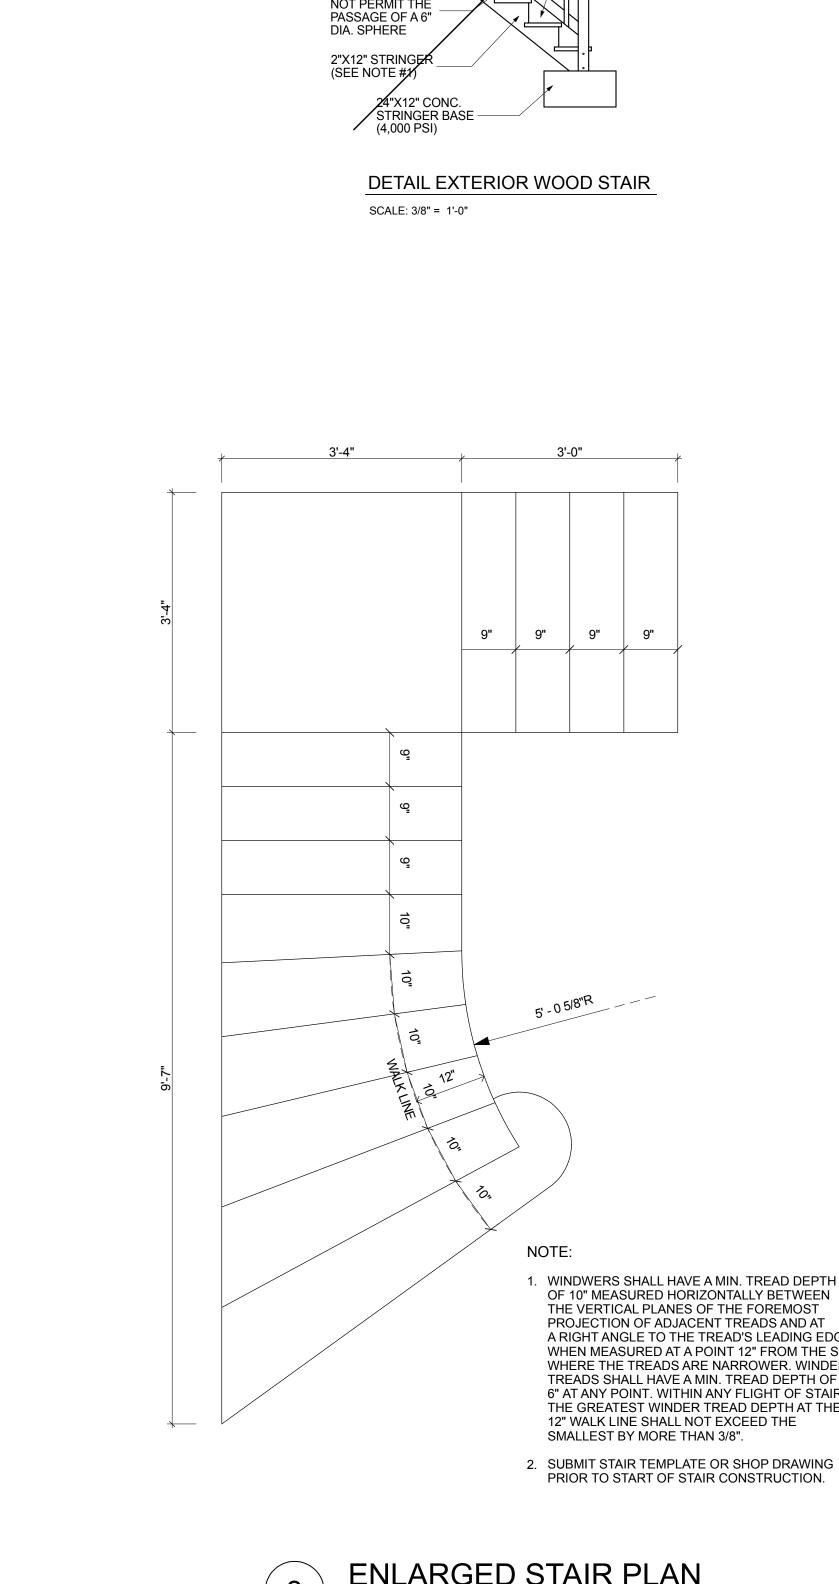

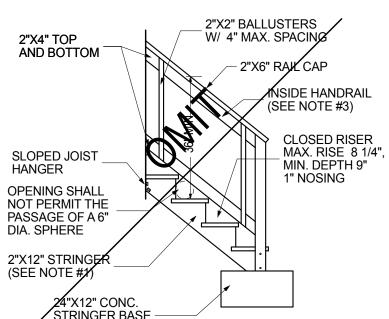

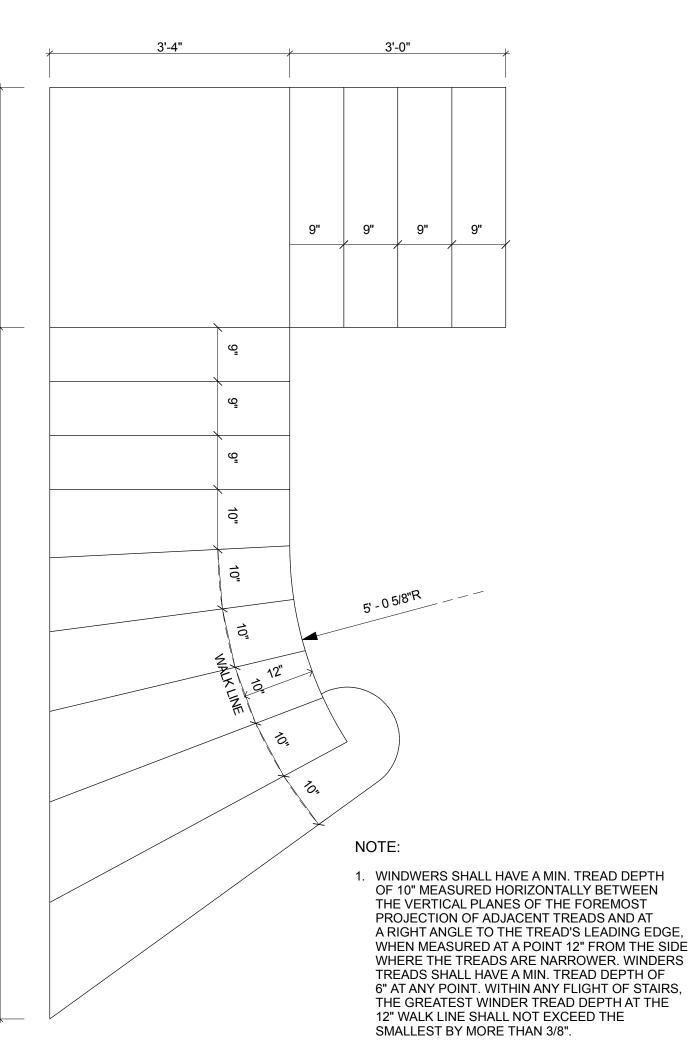

ENLARGED STAIR PLAN SCALE: 3/4" = 1'-0"

TYP. WALL SECTION

FACADE ARCHITECTURE

ARCHITECTS 6120 GRAND CENTRAL PKWY, B103, FOREST HILLS NY 11375 347-957-2245 .FACADE3A@GMAIL.COM

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PROJECT:

MR. & MRS. SINGH RESIDENCE

47 REED DRIVE ROSLYN NY 11576

TAX SECTION: TAX BLOCK: 653 TAX LOT:

FOR:

MR. & MRS. SINGH 80-34 230TH STREET BELLEROSE MANOR, NY 11427

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ISSUED FOR PERMITS: 11/28/18 DRAWN BY: CHECKED. BY: SCALE: AS NOTED

79 TOWN VARIANCE REAPPLICATION 4.11.24

MICHIO SANGA ARCHITECT



SHEET TITLE:

TYP. WALL SECTION, BRICK DECK DETAIL, WINDOW WELL DETAIL ENLARGED STAIR PLAN, LINTEL DETAILS

SHEET NO:



HVAC / ELECTRICAL / PLUMBING

1. MECHANICAL SYSTEMS SHALL BE DESIGNED, AND INSTALLED IN STRICT CONFORMANCE WITH CHAPTER 13 OF THE 2015 INTERNATIONAL RESIDENTIAL CODE (2015 IRC) AND SHALL MEET THE MINIMUM ENERGY EFFICIENCY REQUIREMENTS OF THE CHAPTER 11 OF 2015 IRC. 2. HEATING AND COOLING SYSTEMS SHALL BE DESIGNED, AND INSTALLED IN STRICT CONFORMANCE WITH CHAPTER 14 OF THE 2015 IRC. 3. EXHAUST SYSTEMS SHALL BE DESIGNED, AND INSTALLED IN STRICT CONFORMANCE WITH CHAPTER 15 OF THE 2015 IRC. 4. DUCT SYSTEMS SHALL BE DESIGNED, AND INSTALLED IN STRICT CONFORMANCE WITH CHAPTER 16 OF THE 2015 IRC. 5. COMBUSTION AIR REQUIREMENTS SHALL BE DESIGNED, AND INSTALLED IN STRICT CONFORMANCE WITH CHAPTER 17 OF THE 2015 IRC. 6. CHIMNEYS AND VENTS SHALL BE DESIGNED, AND INSTALLED IN STRICT CONFORMANCE WITH CHAPTER 18 OF THE 2015 IRC. 7. HYDRONIC PIPING SYSTEMS SHALL BE DESIGNED, AND INSTALLED IN STRICT CONFORMANCE WITH CHAPTER 21 OF THE 2015 IRC. 8. SPECIAL PIPING AND STORAGE SYSTEMS SHALL BE DESIGNED, AND INSTALLED

IN STRICT CONFORMANCE WITH CHAPTER 22 OF THE 2015 IRC. 9. SOLAR SYSTEMS SHALL BE DESIGNED, AND INSTALLED IN STRICT CONFORMANCE WITH CHAPTER 23 OF THE 2015 IRC. 10. FUEL GAS SYSTEMS SHALL BE DESIGNED, AND INSTALLED IN STRICT CONFORMANCE WITH CHAPTER 24 OF THE 2015 IRC AND

THE INTERNATIONAL FUEL GAS CODE AS IT GOVERNS SINGLE AND TWO FAMILY DWELLINGS. 11. WATER SUPPLY AND DISTRIBUTION SYSTEMS SHALL BE DESIGNED, AND INSTALLED IN STRICT CONFORMANCE WITH CHAPTER 29 OF THE 2015 IRC. 12. PLUMBING SYSTEMS, GENERAL PLUMBING REQUIREMENTS, PLUMBING FIXTURES, WATER HEATERS, WATER SUPPLY AND DISTRIBUTION SYSTEMS, SANITARY DRAINAGE SYSTEMS, VENTING SYSTEMS, AND PLUMBING TRAP SYSTEMS SHALL BE DESIGNED, INSTALLED AND TESTED IN STRICT CONFORMANCE WITH 2015 IRC AND THE INTERNATIONAL PLUMBING CODE AS IT GOVERNS SINGLE AND TWO FAMILY DWELLINGS. 13. REFER TO CONSTRUCTION DRAWINGS FOR SCHEMATIC PULMBING RISER DIAGRAM AND SCHEMATIC GAS RISER DIAGRAM. 14. ELECTRICAL SYSTEMS, LIGHTING SYSTEMS, ELECTRICAL EQUIPMENT AND COMPONENTS SHALL BE DESIGNED AND INSTALLED IN STRICT CONFORMANCE WITH THE INTERNATIONAL ELECTRICAL CODE AS IT GOVERNS SINGLE AND TWO FAMILY DWELLINGS. 15. FURNISH AND INSTALL EXHAUST FANS AS SHOWN ON THE CONSTRUCTION

SMOKE DETECTORS


1. POWERED BY HOUSE CURRENT, HARDWIRED, INTERCONNECTED, ON SEPARATE CIRCUIT AND WITH BATTERY BACKUP. 2. INSTALL ONE DETECTOR ON EACH FLOOR NEAR TOP OF STAIR, INSIDE AND OUTSIDE OF EACH BEDROOM, ATTIC, AND CELLAR.


DRAWINGS. EXHAUST FANS SHALL PROVIDE A MINIMUM OF 50 CFM AND

CARBON MONOXIDE DETECTORS

SHALL BE DIRECTLY DUCTED TO THE EXTERIOR.


1. POWERED BY HOUSE CURRENT, HARDWIRED, ON SEPARATE CIRCUIT AND WITH BATTERY BACKUP. 2. INSTALL ONE DETECTOR ON EACH FLOOR IN A COMMON HALLWAY, AND WITHIN 15 FEET OF EVERY BEDROOM.

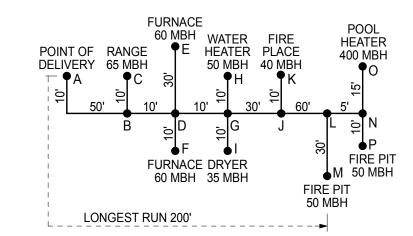

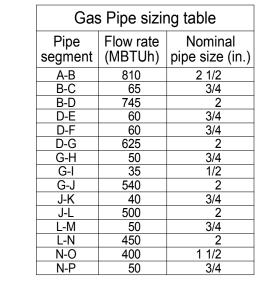

GAS PIPING LAYOUT

NOT TO SCALE

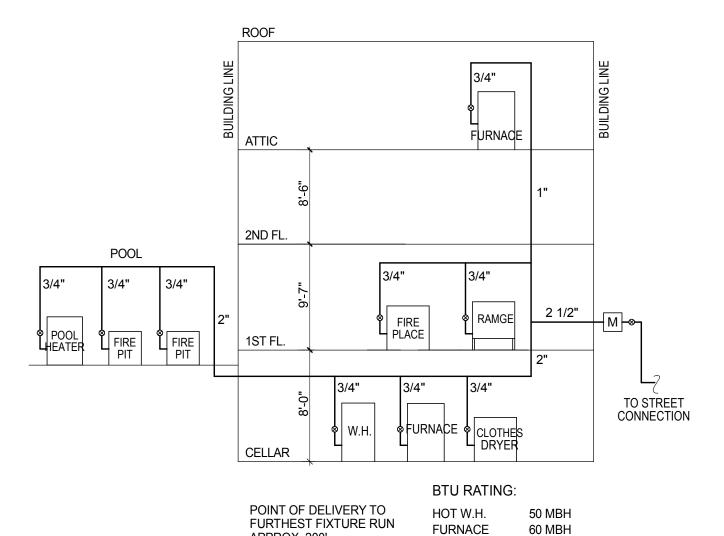

GAS RISER DIAGRAM

STOVE

DRYER

FIRE PLACE

POOL HEATER 400 MBH

FIRE PIT


65 MBH

35 MBH


40 MBH

50 MBH

APPROX. 200'

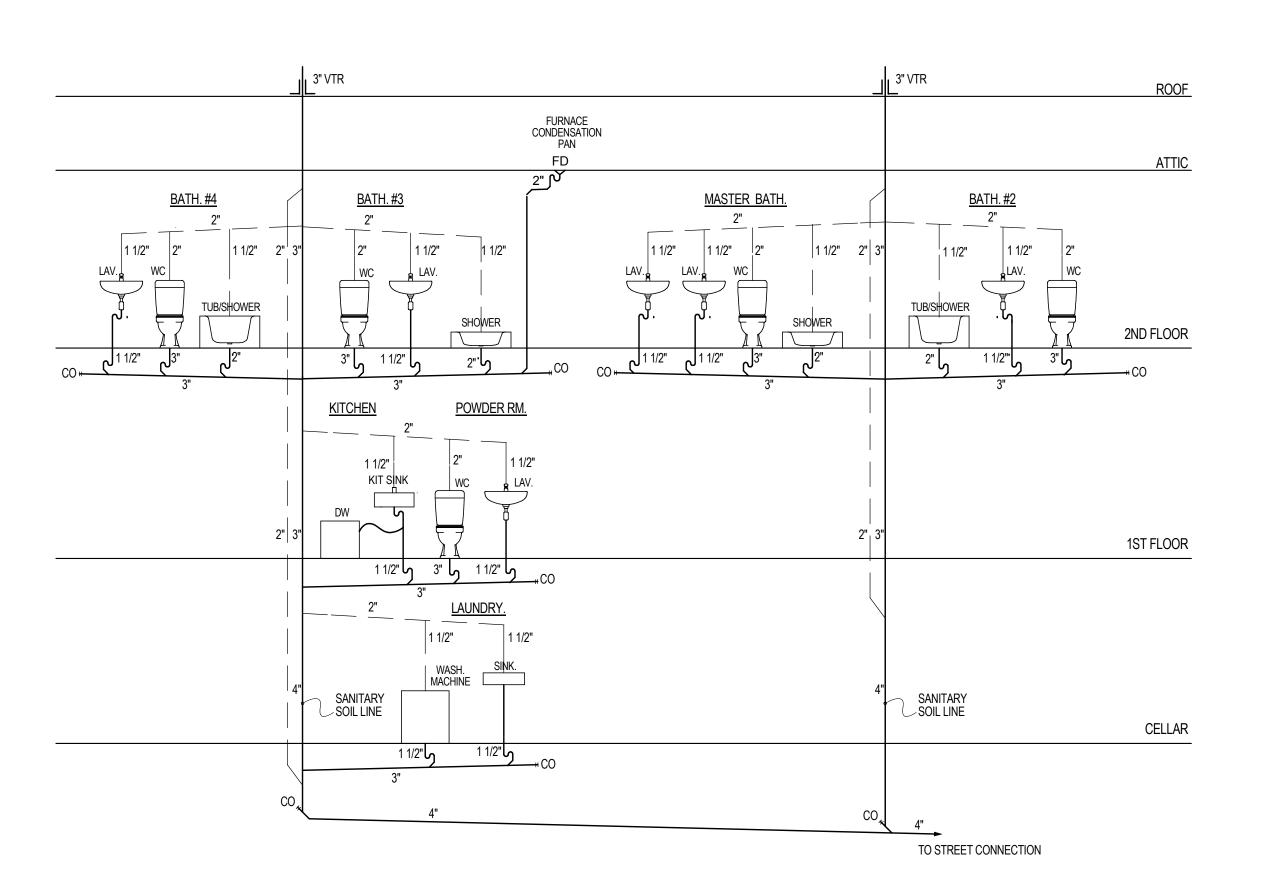



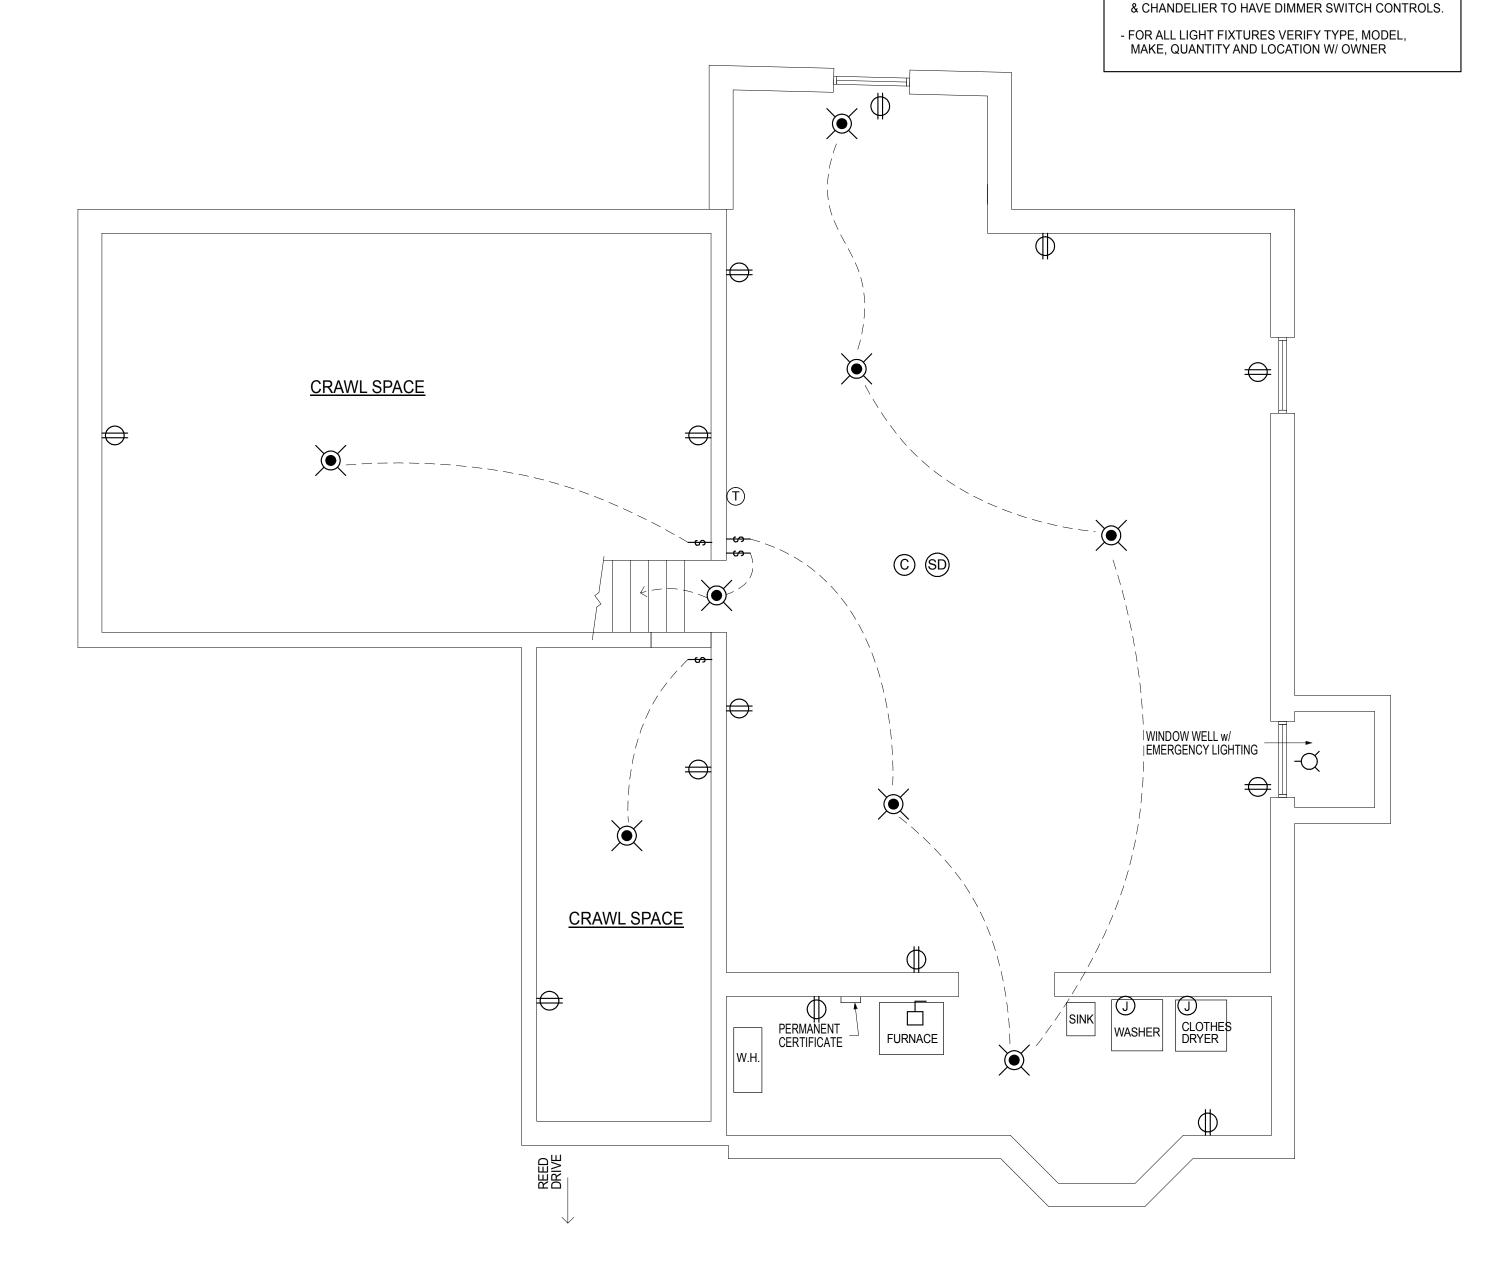

CELLAR POWER/LIGHTING PLAN

FACADE ARCHITECTURE

ARCHITECTS 6120 GRAND CENTRAL PKWY, B103, FOREST HILLS NY 11375 347-957-2245 .FACADE3A@GMAIL.COM

ELECTRICAL LEGEND

RECESSED DOWNLIGHTING

SURFACE MOUNTED CEILING LIGHTING

SURFACE MOUNTED VANITY STRIPS

EXHAUST FAN LIGHT COMBO W/

REMOTE EXHAUST EXTERIOR

MORTOR W/ SCREEN CAP

STANDARD DUPLEX OUTLET

DUPLEX OUTLET W/ COVERS

DUPLEX OUTLET W/ GROUND-

WATERPROOF EXTERIOR

FAULT INTERRUPTER

SINGLE POLE SWITCH

TELEPHONE / DATA JACK

WATERPROOF JUNCTION BOX

PROGRAMABLE THERMOSTAT

- ALL RECESSED DOWNLIGHTING, CEILING LIGHTING

SMOKE DETECTOR - HARD-WIRE,

CARBON MONOXIDE DETECTOR - HARD-WIRE

3-WAY SWITCH

DISCONNECT

JUNCTION BOX

INTERCONNECT

CHANDELIER

SCONCE

 \bigoplus_{GFI}

PROJECT DESCRIPTION: EXISTING BUILDING IS A 1 1/2 STORY SPLIT LEVEL 1 FAMILY DWELLING; IN THE SOUTH SIDE OF HOUSE IS GARAGE AND DEN WITH BEDROOMS ABOVE, NORTH SIDE OF HOUSE IS KITCHEN, IVING/DINING AREA WITH CELLAR BELOW

FILING IS FOR A NEW 2 STORY DWELLING ON AN EXISTING AND NEW FOUNDATION WITH ATTACHED PORTICO.
RELATED FILINGS ARE FOR DEMOLITION, POOL, FENCING, AIR CONDITIONING

PROPRIETARY NOTE: PROPRIETARY NOTE:

IT IS A VIOLATION OF NYS LAW FOR ANY PERSON,
UNLESS ACTING UNDER THE DIRECTION OF THE
ARCHITECT OF RECORD, TO ALTER OR CHANGE
ANY ITEM ON THESE PLANS. THE INFORMATION
AND DRAWINGS HEREIN ARE OF PROPRIETARY
NTURE AND FOR USE BY OUR CLIENTS ONLY, ON
THIS SITE ONLY, AND NOT TO BE USED FOR ANY
OTHER PURPOSE OTHER THAN THIS LOCATION OR
OWNER WITHOUT WRITTEN CONSENT OF MICHIO
SANGA.

PROJECT:

MR. & MRS. SINGH RESIDENCE

47 REED DRIVE ROSLYN NY 11576

TAX SECTION: 653 TAX BLOCK: TAX LOT:

FOR:

MR. & MRS. SINGH 80-34 230TH STREET BELLEROSE MANOR, NY 11427

	REVISION	DATE
1	PLANS COMPLYING 03.11.19	05.28.19
	OMMISSIONS LETTER	
2	PLANS COMPLYING 06.18.19	07.22.19
	OMMISSIONS LETTER 2	
3	PLANS COMPLYING 08.03.19	08.19.19
	OMMISSIONS LETTER 3	
4	PLANS COMPLYING 10.23.19	
	OMMISSIONS LETTER 4, POOL	12.02.19
5	TOWN BOARD REVIEW	5.11.22
6	STATE VARIANCE APPLICATION	1.19.23
7	TOWN VARIANCE APPLICATION	7.27.23
8	STATE VARIANCE REAPPLICATION	8.04.23

ISSUED FOR PERMITS: DRAWN BY: CHECKED. BY: SCALE: AS NOTED

TOWN VARIANCE REAPPLICATION 4.11.24

MICHIO SANGA ARCHITECT




SHEET TITLE:

CELLAR POWER/LIGHTING PLAN, ELECTRICAL LEGEND, PLUMBING RISER DIAGRAM, GAS RISER DIAGRAM GAS PIPING LAYOUT, NOTES


SHEET NO:


A-8

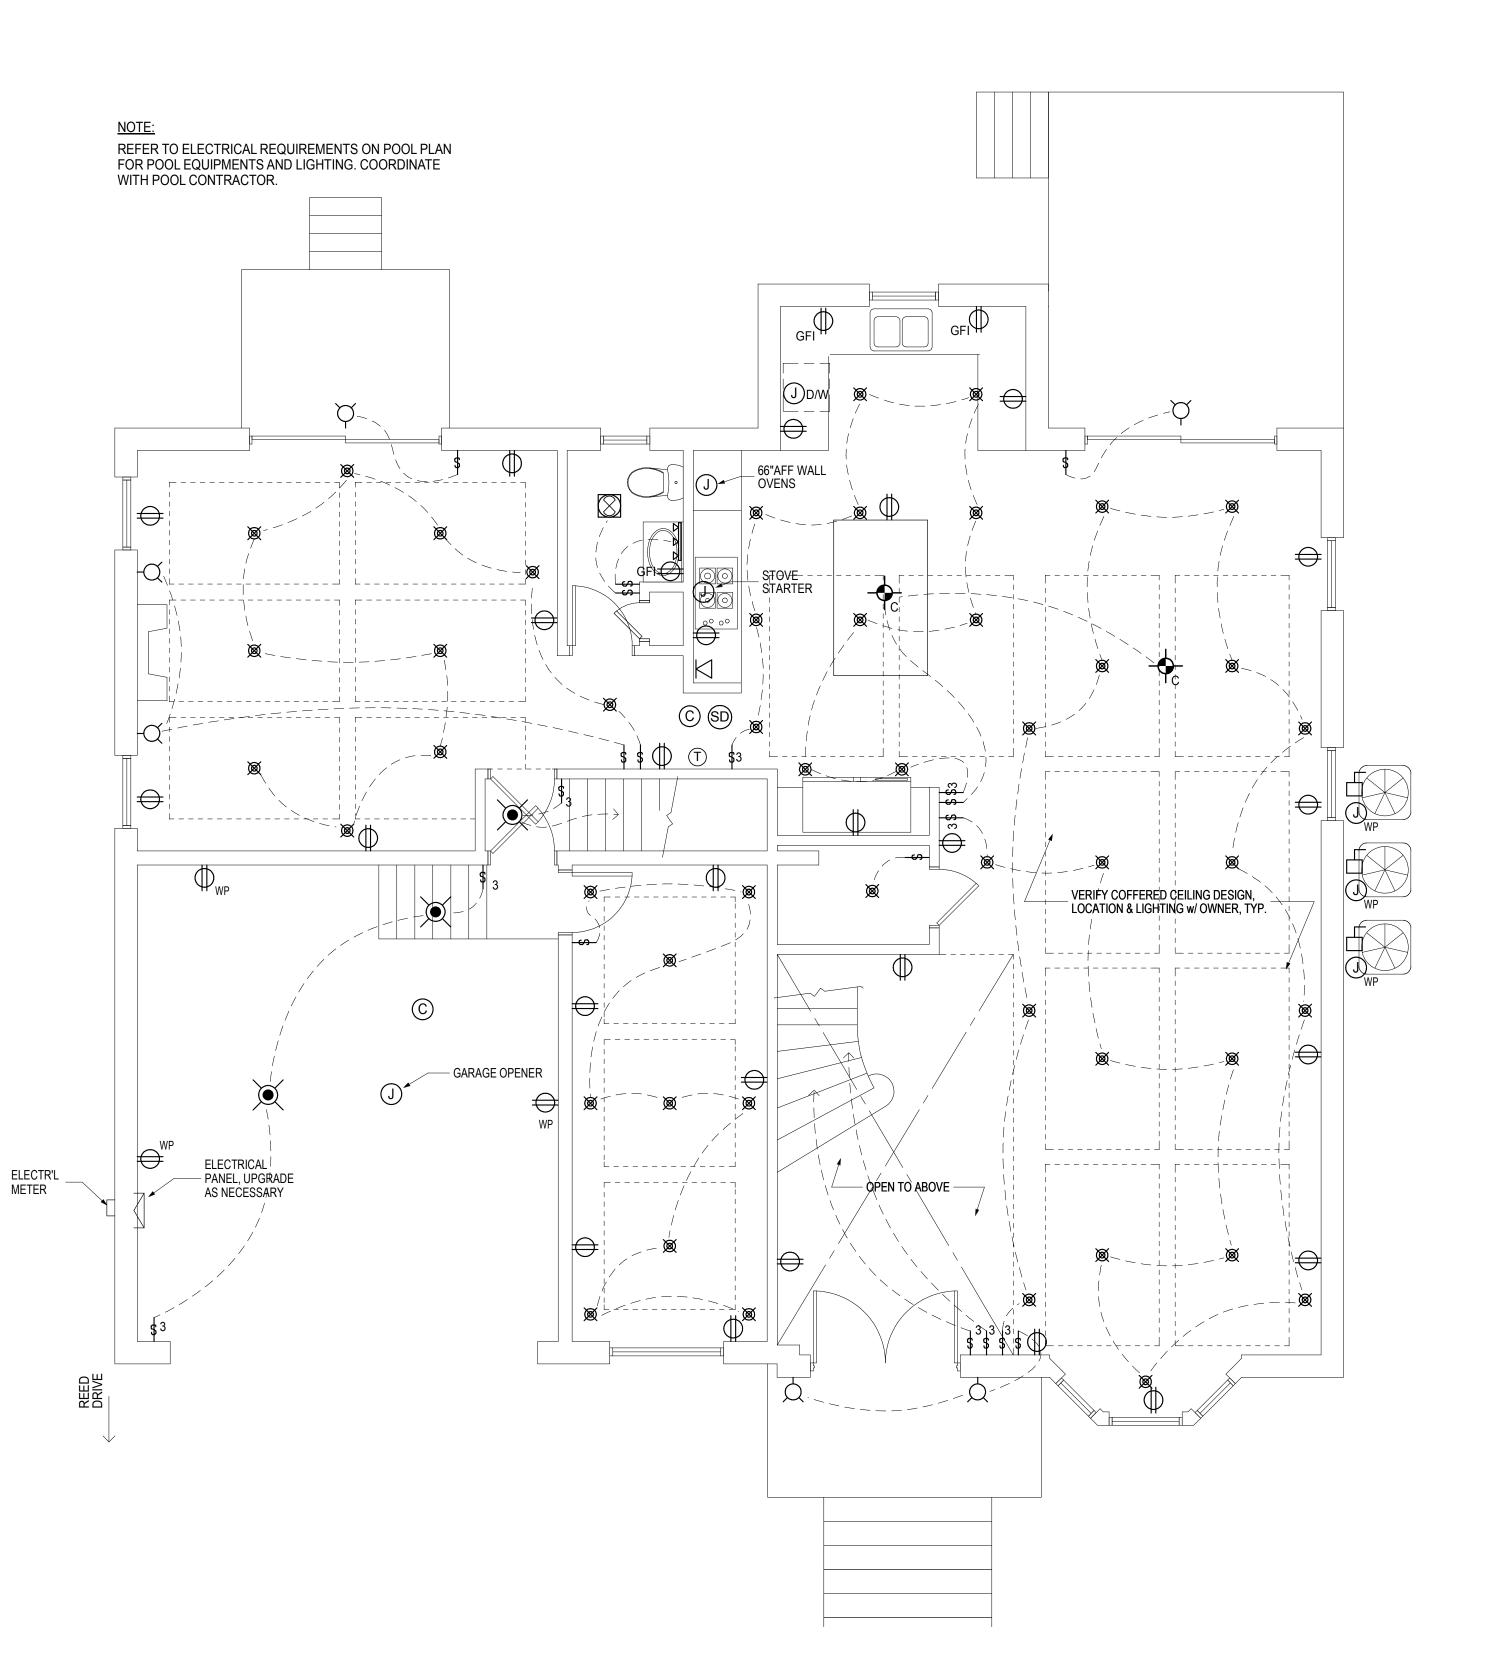

1 1ST FLOOR POWER/LIGHTING PLAN

SCALE: 1/4" = 1'-0"

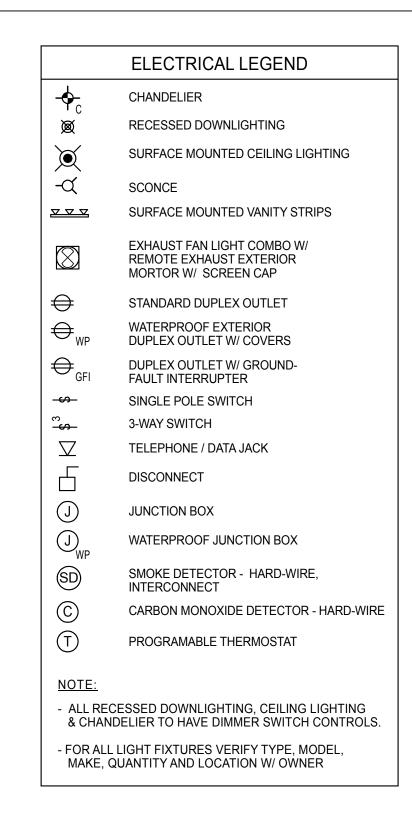

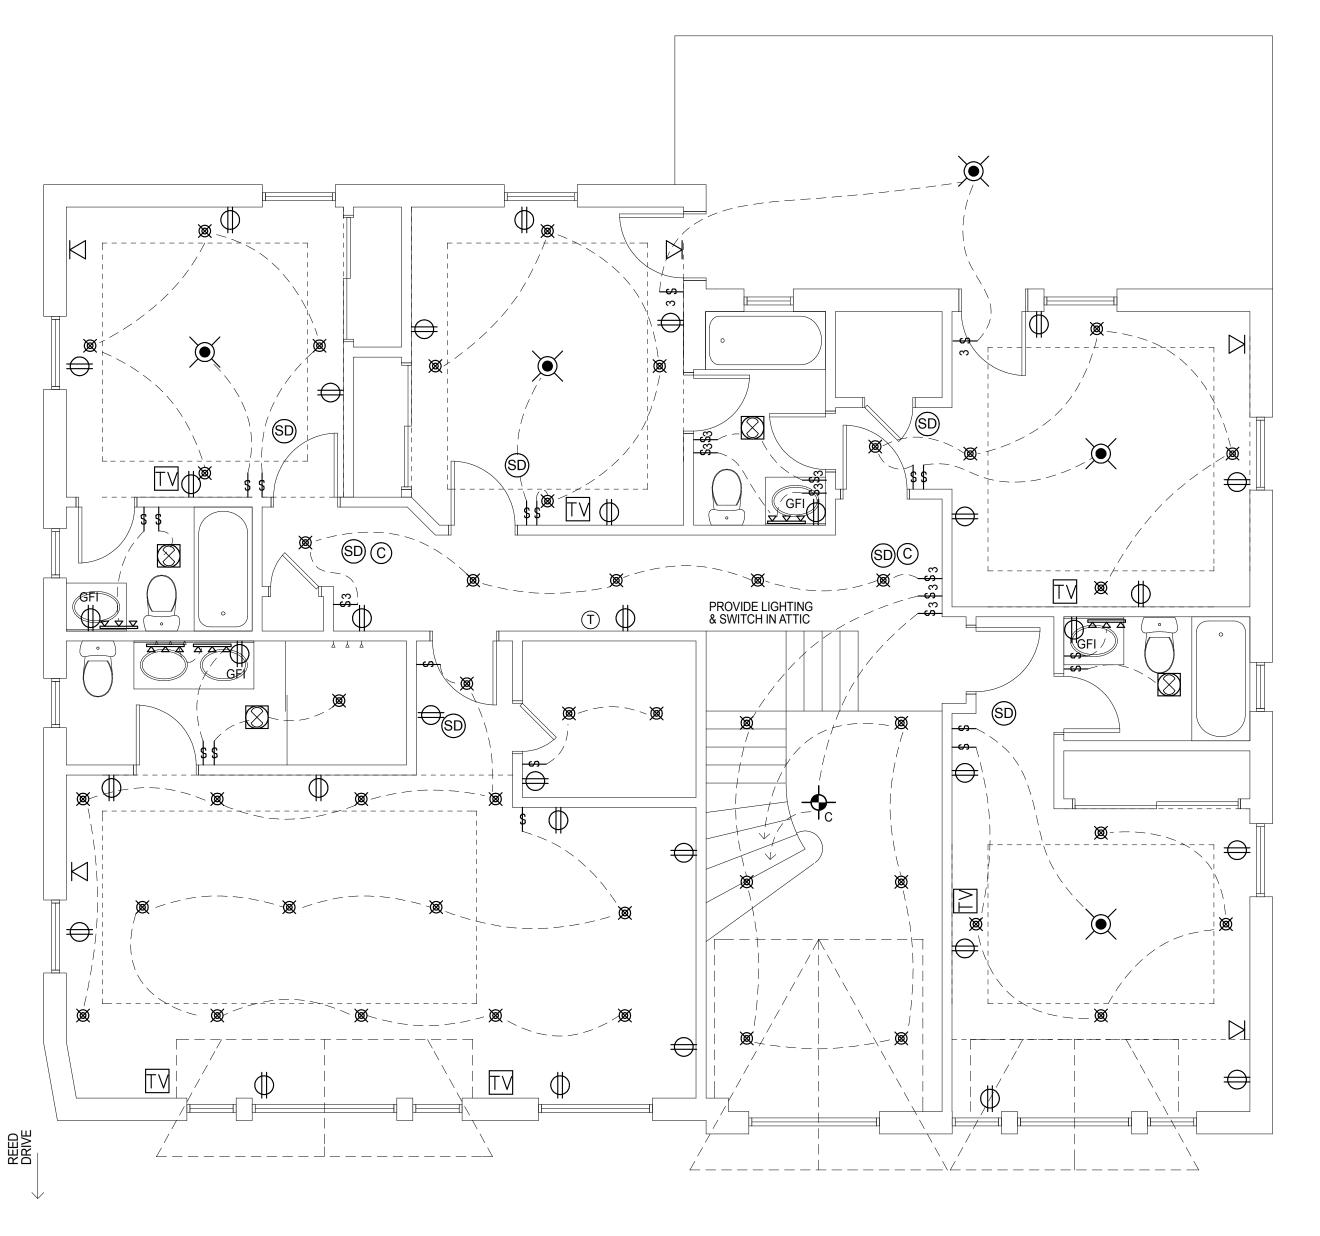

2 2ND FLOOR POWER/LIGHTING PLAN

SCALE: 1/4" = 1'-0"

FACADE ARCHITECTURE

ARCHITECTS
6120 GRAND CENTRAL PKWY,
B103, FOREST HILLS NY 11375
347-957-2245
.FACADE3A@GMAIL.COM

PROJECT DESCRIPTION:

EXISTING BUILDING IS A 1 1/2 STORY
SPLIT LEVEL 1 FAMILY DWELLING;
IN THE SOUTH SIDE OF HOUSE IS GARAGE
AND DEN WITH BEDROOMS ABOVE,
NORTH SIDE OF HOUSE IS KITCHEN,
LIVING/DINING AREA WITH CELLAR BELOW.

FILING IS FOR A NEW 2 STORY DWELLING
ON AN EXISTING AND NEW FOUNDATION
WITH ATTACHED PORTICO.
RELATED FILINGS ARE FOR DEMOLITION,
POOL, FENCING, AIR CONDITIONING
EQUIPMENT AND DRYWELLS.

PROPRIETARY NOTE:

IT IS A VIOLATION OF NYS LAW FOR ANY PERSON, UNLESS ACTING UNDER THE DIRECTION OF THE ARCHITECT OF RECORD, TO ALTER OR CHANGE ANY ITEM ON THESE PLANS. THE INFORMATION AND DRAWINGS HEREIN ARE OF PROPRIETARY NTURE AND FOR USE BY OUR CLIENTS ONLY, ON THIS SITE ONLY, AND NOT TO BE USED FOR ANY OTHER PURPOSE OTHER THAN THIS LOCATION OR OWNER WITHOUT WRITTEN CONSENT OF MICHIO SANGA.

PROJECT:

MR. & MRS. SINGH RESIDENCE

47 REED DRIVE ROSLYN NY 11576

TAX SECTION: 9
TAX BLOCK: 653
TAX LOT: 64

.

MR. & MRS. SINGH 80-34 230TH STREET BELLEROSE MANOR, NY 11427

	REVISION	DATE
1	PLANS COMPLYING 03.11.19	05.28.19
	OMMISSIONS LETTER	
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8	STATE VARIANCE REAPPLICATION	8.04.23
9	TOWN VARIANCE REAPPLICATION	4.11.24

ISSUED FOR PERMITS: 11/28/18
DRAWN BY: MS
CHECKED. BY: MS
SCALE: AS NOTED

MICHIO SANGA ARCHITECT



NYRA

SHEET TITLE:

1ST FLOOR POWER/ LIGHTING PLAN, 2ND FLOOR POWER/ LIGHTING PLAN, ELECTRICAL LEGEND

SHEET NO:

A-9

GENERAL NOTES

1. ALL WORK SHALL CONFORM TO THE 2020 RESIDENTIAL CODE OF NEW YORK STATE, ENERGY CODE AND ALL RULES AND REGULATIONS OF LOCAL AUTHORITIES HAVING JURISDICTION, INCLUDING THE LATEST EDITIONS OF THE NATIONAL FIRE CODE AND ALL REQUIREMENTS OF THE OCCUPATIONAL SAFETY AND HEALTH ACT.

2. THE CONTRACTOR IS TO CHECK AND VERIFY THESE DOCUMENTS AND BE RESPONSIBLE

FOR ALL MEASUREMENTS, DIMENSIONS AND CONDITIONS. ANY DISCREPANCIES ARE TO BE REPORTED TO THE ARCHITECT BEFORE A SUBMISSION OF BID. A SUBMISSION OF BID SHALL IMPLY CONTRACTOR'S ACCEPTANCE OF THE DRAWINGS AND THE EXISTING CONDITIONS.

3. COMMENCEMENT OF CONSTRUCTION WILL SIGNIFY THAT THE CONTRACTOR AND TRADE CONTRACTOR WILL HOLD THE ARCHITECT HARMLESS FOR ANY AND ALL ERRORS, OMISSIONS AND PERSONAL LIABILITY.

4. THESE DRAWINGS ARE INTENDED TO CONVEY THE OVERALL DESIGN INTENT AND GENERAL SCOPE OF WORK. ALL CONNECTIONS, ASSEMBLIES AND DETAILS REQUIRED TO CARRY OUT THIS DESIGN INTENT ARE TO BE PROVIDED BY THE GENERAL CONTRACTOR.

5. ALL CONDITIONS CONTAINED IN THE LATEST EDITION OF THE A.I.A AIØT "GENERAL CONDITIONS OF THE CONTRACT" SHALL BE INCORPORATED INTO THESE SPECIFICATIONS AND SHALL BE BINDING TO THE CONTRACT AS IF WRITTEN HEREIN.

6. CONTRACTOR SHALL OBTAIN AND PAY FOR ALL REQUIRED UNDERWRITER'S CERTIFICATES, CERTIFICATE OF OCCUPANCY, AND/OR COMPLETION FOR ALL WORK INDICATED FROM ANY AGENCIES HAVING JURISDICTION.

7. IF, IN THE COURSE OF CONSTRUCTION, A CONDITION EXISTS WHICH DISAGREES WITH THAT AS INDICATED ON THESE DRAWINGS, THE CONTRACTOR SHALL STOP WORK AND NOTIFY THE ARCHITECT IMMEDIATELY. SHOULD HE FAIL TO FOLLOW THIS PROCEDURE AND CONTINUE TO WORK, HE SHALL ASSUME ALL RESPONSIBILITY AND LIABILITY ARISING THEREFROM.

8. DO NOT SCALE DRAWINGS. WRITTEN DIMENSIONS SUPERSEDE SCALED DIMENSIONS.

9. DURING THE COURSES OF CONSTRUCTION, IF MODIFICATION TO THE DESIGN OCCUR AS A RESULT OF EXISTING CONDITIONS, REQUEST OF THE OWNER, DESIGNER, ETC., THE CONTRACTOR SHALL SUBMIT TWO WRITTEN COPIES OF A CHANGE ORDER WITH THE AMENDED PRICE IMMEDIATELY. CONTRACTOR SHALL NOT CONTINUE WITH ANY CHANGES UNTIL HE RECEIVES WRITTEN AUTHORIZATION FROM THE OWNER.

10. CONTRACTOR SHALL PATCH AND MATCH ALL FINISHES AFFECTED BY CONSTRUCTION.

11. ALL MATERIALS USED ARE TO BE PERMANENT. MATERIALS TO BE USED IN THE CONSTRUCTION OF THE PREMISES

SHALL BE NEW AND UNUSED.

12. THE CONTRACTOR SHALL GUARANTEE THE WORK OF EACH TRADE AND THE ENTIRE WORK OF THIS CONTRACT FOR A PERIOD OF ONE

13. CONTRACTOR TO SUPPLY TO OWNER IN WRITING A WAIVER OF ALL LIENS FOR HIMSELF AND ALL SUBCONTRACTORS AT TIME OF FINAL

YEAR FROM THE DATE OF ACCEPTANCE BY THE OWNER.

14. UPON COMPLETION OF WORK, CONTRACTOR SHALL BROOM CLEAN

ALL AFFECTED AREAS AND CART AWAY ALL DEBRIS.

15. STRUCTURAL LUMBER: SHALL MEET OR EXCEED THE FOLLOWING:

E = 1,760,000 DOUGLAS FIR CONSTRUCTION GRADE 1

16. CONCRETE: SHALL BE F'C = 4,000 PSI @ 28 DAYS SEE STRUCTURAL

ENGINEERS NOTE THIS PAGE

T. STRUCTURAL STEEL: SEE STRUCTURAL ENGINEERS NOTES ON THIS

18. FOOTINGS: SHALL BEAR ON UNDISTURBED SOIL.

19. DRYWALL: ALL DRYWALL PRODUCTS, INCLUDING GYPSUM BOARD, STUDS, SCREW, JOINT COMPOUND, TAPES AND TRIM SHALL BE U.S. GYPSUM CO., OR APPROVED EQUAL. ALL JOINTS SHALL RECEIVE 3 COATS OF JOINT TREATMENT. SAND FINAL COAT TO A UNIFORM SMOOTH SURFACE. ALL WALLS, CEILINGS AND INTERIOR OF CLOSETS TO BE TAPED AND SPACKLED 3 COATS, READY FOR PAINT. ALL GYPSUM BOARD SHALL BE 1/2" UNLESS OTHERWISE NOTED.

20. PAINTING AND FINISHING: ALL WALLS AND SURFACES AS ON THE DRAWINGS ARE TO BE PAINTED WITH I COAT PRIMER AND 2 COATS OF FINISH PAINT. REMOVE ALL HARDWARE TRIM, SWITCH PLATES, ETC., PRIOR TO PAINTING AND REPLACE SAME AT COMPLETION OF WORK. WALL COLOR IS TO BE DETERMINED BY OWNER BUT MANUFACTURED BY: BENJAMIN MOORE PAINTS, CEILING COLOR IS TO BE FLAT PAINT IS TO BE USED ON THE WALLS AND CEILINGS AND SEMI-GLOSS IS TO BE USED ON ALL DOORS AND TRIM.

21. CONTRACTOR TO PROVIDE A MINIMUM OF ONE SINGLE STATION SMOKE DETECTOR AT EACH NEW BEDROOMS, HALLWAYS ETC. SEE REFLECTED CEILING PLAN OF THE HOUSE IN COMPLIANCE WITH NYSEC ASIO. DETECTORS SHALL BE ELECTRIC AND SHALL BE DIRECTLY CONNECTED TO LIGHTING CIRCUITS WITH NO INTERVENING SWITCHES.

22. WINDOWS: ALL WINDOWS TO BE NEW, INSULATED GLASS, SIZE AND FUNCTION AS INDICATED ON PLANS AND ELEVATIONS (SEE DRAWINGS FOR DETAILS). PROVIDE INSECT SCREENS AS REQUIRED. ALL GLASS LESS THAN 18" ABOVE FINISHED FLOOR TO BE TEMPERED. ALL CUSTOM GLAZING SHALL BE 1" INSULATED GLASS. EXTERIOR FRAMEWORK TO BE DETERMINED AND COLOR. PROVIDE 3 SETS OF SHOP DRAWINGS ON CUSTOM UNITS TO ARCHITECT FOR APPROVAL PRIOR TO FABRICATION. SEE PLANS AND ELEVATIONS.

23. PLUMBING AND FIXTURES: ALL PLUMBING WORK SHALL BE DONE BY DULY LICENSED PLUMBER. ALL PLUMBING FIXTURES TO BE SUPPLIED AND INSTALLED BY CONTRACTOR OR OTHERWISE NOTED.

24. DOORS: ALL NEW INTERIOR DOORS SEE DOOR SCHEDULE. ALL CLOSET DOORS TO SEE DOOR SCHEDULE. ALL HARDWARE TO BE SCHLAGE, OR APPROVED EQUAL. FUNCTION AS REQUIRED.

25. INSULATION: INSULATE ALL NEW EXTERIOR WALLS, FLOORS AND CEILINGS AS INDICATED ON PLANS AND SECTIONS. ALL BATT INSULATION IS TO HAVE FOIL SURFACE ONE SIDE, OR AS REQUIRED.

26. OMIT

27. GENERAL CONTRACTOR SHALL PERFORM ALL THE CUTTING AND PATCHING FOR ALL TRADES.

28. GUTTERS: CONTRACTOR TO INSTALL NEW GUTTERS AND LEADERS

THROUGHOUT.

29. CLOSETS: ALL NEW CLOSETS TO BE AS PER PLANS AND OWNER SPECIFICATIONS.

30. FLOORING: CONTRACTOR TO SUPPLY AND INSTALL NEW FLOORS AS INDICATED AREAS ON PLAN AND MATERIAL SELECTED BY OWNER. CONTRACTOR TO SUPPLY AND INSTALL ALL MATERIALS AS PER OWNER.

BI. ROOFING: NEW ON GABLES

32. ELECTRICAL: ALL ELECTRICAL WORK TO BE BOARD OF FIRE UNDERWRITERS APPROVED AND TO INCLUDE INSTALLATION OF FIXTURES AND SPECIFICATIONS AS INDICATED. LIGHT FIXTURES TO BE SUPPLIED AND INSTALLED BY CONTRACTOR EXCEPT WHERE NOTED. GFI OUTLETS REQUIRED AT ALL WET AREAS, EXTERIOR AND STORAGE AREAS. INSTALL ALL OUTLETS AS PER CODE. ALL WORK TO DONE IN STRICT ACCORDANCE WITH THE NEW YORK STATE CODE BY DULY LICENSED ELECTRICIANS. ALL NEW SWITCHES AND OUTLETS TO BE LEVITION, DECOR WHITE, SUPPLIED AND INSTALLED BY

TO BE LEVITION, DECOR WHITE, SUPPLIED AND INSTALLED BY CONTRACTOR. OUTLETS AND SWITCHES TO BE SUPPLIED AND INSTALLED BY CONTRACTOR. CONTRACTOR TO DO ALL HOOK-UPS AS REQUIRED FOR KITCHEN,

33. HEADER: TO BE INSTALLED ABOVE ALL NEW OPENINGS, DOORS AND WINDOWS IN BEARING WALLS. TECO JOIST HANGERS TO BE USED ON ALL FLUSH HEADER CONNECTIONS. ENDS OF HEADERS TO REST FULLY ON (2) 2"X6" JACK STUDS UNLESS OTHERWISE NOTED. TYPICAL SPAN: SIZE OF HEADER

2-2"×8" 2-2×10" 2-2×12"

0'-4'

AT ANY OPENING THERE SHOULD BE DOUBLE JACK STUDS, ALL HEADERS ARE TYPICAL UNLESS OTHERWISE NOTED. INSTALL METAL BRIDGING AT 6'-0" O.C.

34. HEATING CONTRACTOR TO PROVIDE NEW GAS BOILER

NOTE: NOTE: CONSTRUCTION NOTE: CONSTRUCTION NOTE: CONSTRUCTION COMPLIES WITH 2020 COMPLIES WITH 2020 COMPLIES WITH 2020 BUILDING CODE OF MECHANICAL CODE OF FIRE CODE OF NEW NEW YORK STATE YORK STATE NEW YORK STATE NOTE: CONSTRUCTION NOTE: CONSTRUCTION NOTE: CONSTRUCTION COMPLIES WITH 2020 COMPLIES WITH 2020 COMPLIES WITH 2020 ENERGY CONSERVATION FUEL GAS CODE OF RESIDENTIAL CODE CODE OF NEW YORK OF NEW YORK STATE NEW YORK STATE

DL = 600 PSF

STRUCTURAL LOAD CALCULATIONS

UPLIFT FOUNDATION/ FOOTING

MAINTENANCE CODE

OF NEW YORK STATE

ROOF ATTIC LL= 95 PSF X 10' = 950 PSF

20 PSF X 10' = 200 PSF

NOTE: CONSTRUCTION NOTE: CONSTRUCTION

PROPERTY

COMPLIES WITH 2020 COMPLIES WITH 2020

PLUMBING CODE OF

NEW YORK STATE

LL= 95 PSF X 10' = 950 PSF DL= 15 PSF X 10' = 150 PSF

FLOOR LL =40 PSF X 10' = 400 PSF DL = 10 PSF X 10' = 100 PSF

DL = 80 PSF

TOTAL BEARING LOAD

LL = 1350 PSF

DL = 850 PSF

NOTE: CONSTRUCTION

COMPLIES WITH 2020


OF NEW YORK STATE


EXISTING BULDING CODE

2200 PSF
THERFORE MIN. 1.5 TON SOIL
CAPACITY ACCEPTABLE

SITE AND ZONING	DATA 141 COUNTRY	CLUB DRIVE, MANHASSET N.Y	. 11030			
BECTION		3				
BLOCK	148					
_OT(S)	73					
ONE DESCRIPTION		RESIDENCE A				
OT AREA	9,6	22 SF OR 22 ACRE				
ZONING	REQUIRED	PROPOSED	CODE SECTION			
MAXIMUM BUILDING HEIGHT	2 1/2-STY / 3Ø.Ø'	EXTG 2 STORY	70-26			
IINIMUM LOT AREA	8,500 SF	EXTG 9,622	TØ-2T			
MINIMUM LOT WIDTH	65.0'	EXTG 68.38'	TØ-27.1			
OT COVERAGE	25%	NEW 24.8%	70-28			
MAXIMUM F.A.R.	36% NOT TO EXCEED 4,000 SF	EXTG 2,974 5Q/FT EXTG 31%	7Ø-29			
VERAGE FRONT YARD SETBACK	31.8' OR 31'-9 ½"	NEW PORTICO 28'-2 ½"	7Ø-3ØC			
ECONDARY FRONT YARD SETBACK	3Ø'	NEW DECK 20'-6"	70-30B VARIANCE			
IINIMUM FRONT YARD SETBACK	35'	EXTG 36.1	7Ø-3ØA			
IINIMUM FRONT YARD SETBACK	35'	NEW GABLE 1 = 34'-2 ½"	70-30A VARIANCE			
INIMUM FRONT YARD SETBACK	35'	NEW GABLE 2 = 33'-6 3"	70-30A VARIANCE			
IINIMUM FRONT YARD SETBACK	35'	NEW GABLE 3 = 37'-0 ½"	7Ø-3ØA			
INIMUM SIDE YARD SETBACK	30% LOT WIDTH MIN 10'	NEW DECK 13'-8" AND 37'-3 4" AGG 50'-11 4"	7Ø-31			
IINIMUM REAR YARD SETBACK	15-0"	NEW 20'-6"	7Ø-32			
ARKING	MIN. 2	EXTG NO CHANGE	7Ø-42.l			
OKY EXPOSURE PLANE	2 VERT. 1 HORIZ.	EXTG NO CHANGE	7Ø-32.3			
EAVE HEIGHT	22'-Ø"	EXTG NO CHANGE	TØ-32.T			
NEAR YARD LOT COVERAGE 40%	40%	NEW 13%	70-100.1A			
TONT YARD PAVING 40%	40%	NEW 26.1%	70-32.6			
ACCESSORY STRUCTURES FENCES	FRONT FACE 4' SIDES 5' REAR 6'	NEW FRONT FACE 4' NEW SIDES 5' NEW REAR 6'	70-100.2			

	2020 RESIDENTIAL CODE OF NEW YORK STATE TABLE R301.2(1) CLIMATIC AND GEOGRAPHIC DESIGN CRITERIA											
GROUND SNOW LOAD	WIND SEMIC WIND-BORNE WEATHERING EROST TERMITE DECAY				DESIGN	ICE SHIELD UNDERLAYING REQUIRED	FLOOD HAZARDS	AIR FREEZING INDEX	MEAN ANNUAL TEMP.			
45	130	С	YES	SEVERE	3'-0" MIN.	MODERATE / HEAVY	SLIGHT/ MODERATE	15°F	YES / 24"	PER FEMA FLOOD MAP	1500 OR <	52.9°F

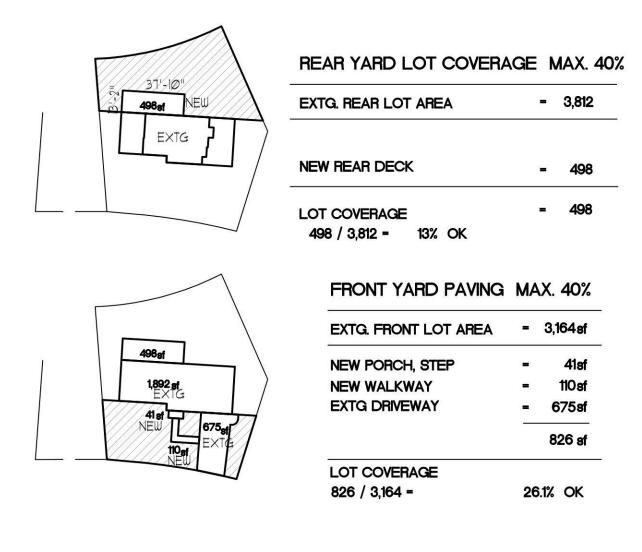


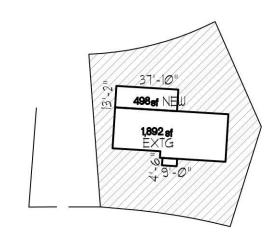


LOT COVERAGE CALCUL	ATION	IS	
EXTG. LOT AREA	=	9,622	ef
EXTG. FIRST FLR.	_	1,892	sf
NEW REAR DECK	=	498	sf
NEW FRONT POTICO (excluded)	10.00	0	ef
(Oxoladod)		2,390	sf
LOT COVERAGE			
2,390 / 9,622 =	2	4.8%	


	CLUB DRIVE	SEC: 3
BLOCK	LOT	AVERAGE F.Y.
148	167	31.1'
148	72	31.8'
148	73	SUBJECT PROPERTY
148	83	36.6'
148	82	27.6'


#21589

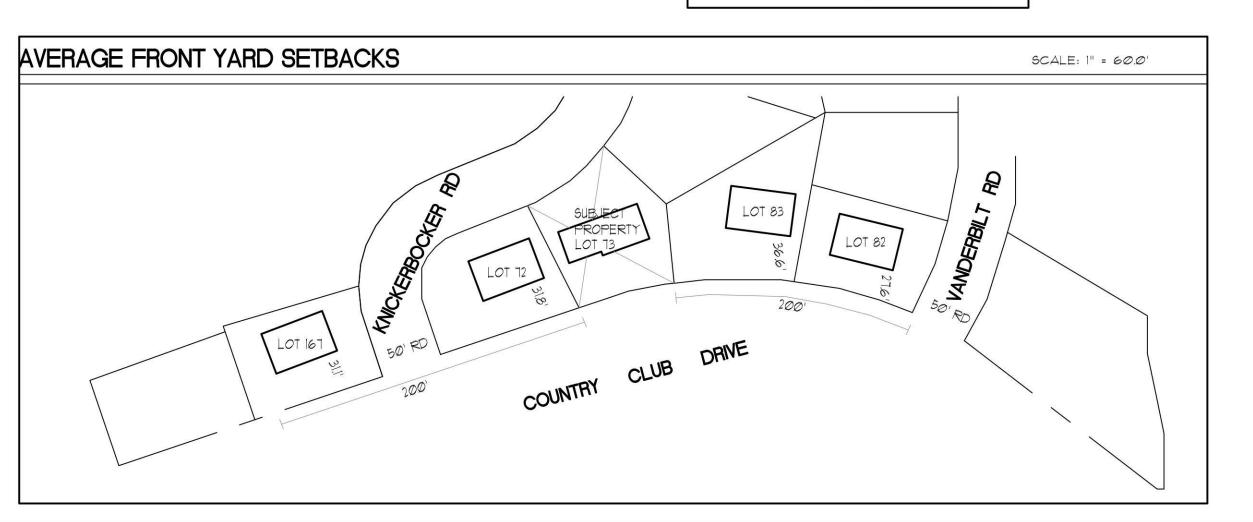

KARANIKAS RESIDENCE 141 COUNTRY CLUB DRIVE, MANHASSET, NEW YORK 11030

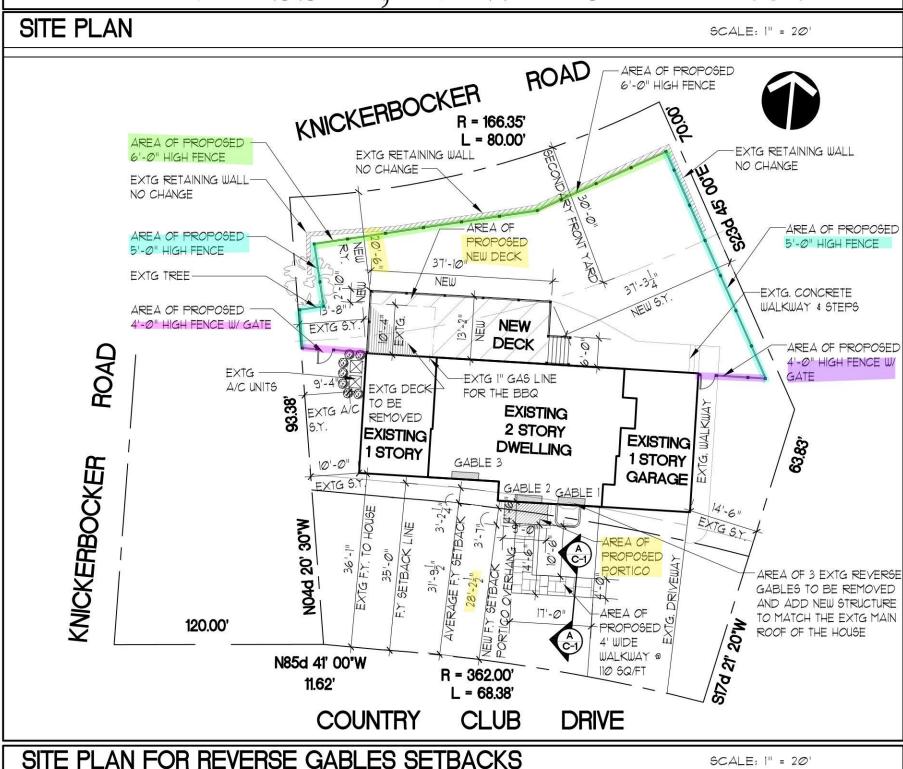

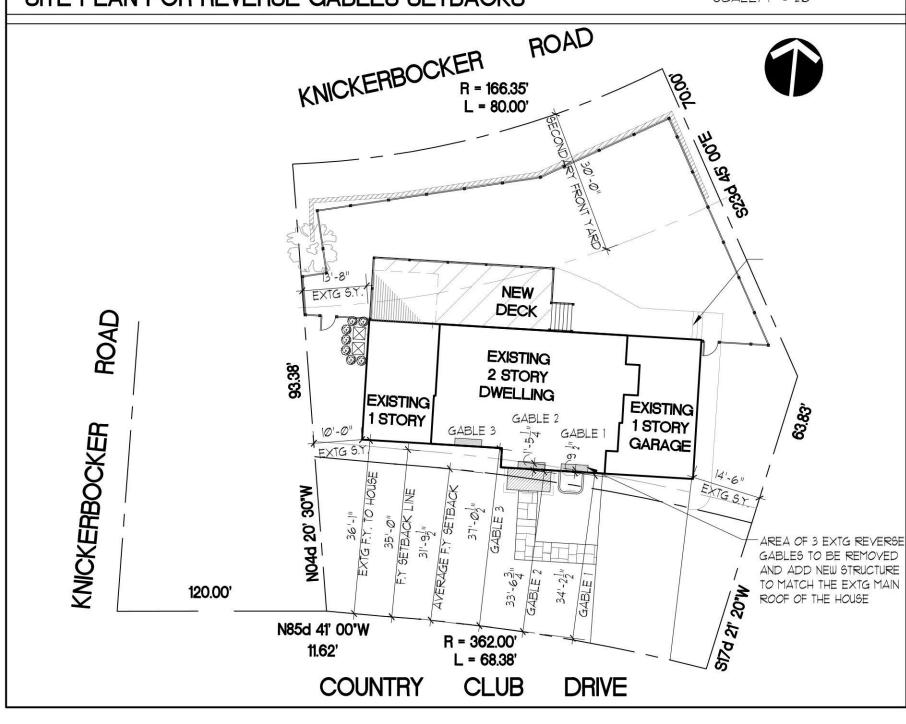

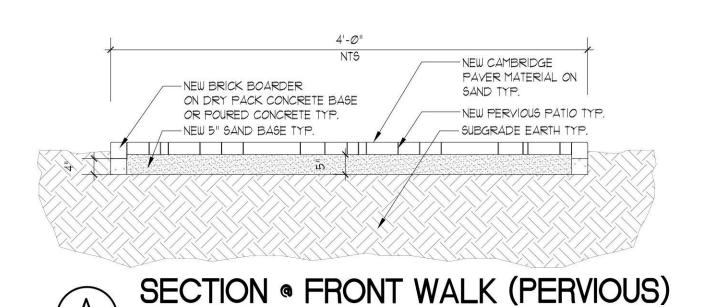



INSTRUMENT OF SERVICE AND ARE THE PROPERTY OF THE ARCHITECT. INFRINGEMENTS WILL BE PROSECUTED.

CONTRACTOR SHALL VERIFY ALL CONDITIONS AND MEASUREMENTS IN THE FIELD AND BE RESPONSIBLE FOR FIELD FIT AND QUANTITY OF WORK. NO ALLOWANCES SHALL BE MADE IN BEHALF OF THE CONTRACTOR FOR ANY ERROR OR NEGLECT ON HIS PART.

O. REVISION DATE

NOTES, ZONING

S. RESIDON

S. RESIDENCE

S. LUB DRIVE

NOTED A.D.B

AS

WARD PAUL BUTT
chitect, AIA

New Hyde Park, New York 11040

DRAWING NO.:

NOTE: NOTE: FOR ALL NEW HEADER SIZES AND OPENINGS SEE SHEET A-I COVER SHEETS GENERAL NOTES TYP. UNLESS OTHERWISE

NOTE: CONTRACTOR TO PROVIDE SOLID BRIDGING AS REQ. IN ALL FLOOR JOISTS TYP.

TO HAVE $\frac{1}{2}$ " TOP AND BOTTOM PLATES TO COVER THE SIZE OF BEAMS DESCRIBED IN THE PLANS

NOTE: FOR ALL STEEL COLUMNS

ALL NEW STEEL COLUMN POST MUST REST ON NEW OR EXTG FOUNDATIONS BELOW

NOTE:
CONTRACTOR TO PROVIDE 4"X6" WOOD POSTS (DBL. JACK STUDS) BETWEEN ALL WINDOWS AND DOORS W/ HEADERS ACROSS TYP. ON ALL WINDOWS UNLESS OTHERWISE NOTED.

ALL EMERGENCY ESCAPE AND RESCUE OPENINGS AND MEANS OF EGRESS SHALL CONFORM TO SECTION 310 THROUGH 311.5 OF THE 2020 RESIDENTIAL CODE OF NEW YORK STATE.

NOTE: CONTRACTOR TO PROVIDE AND INSTALL ALL NEW FASCIA BOARDS, RACER BOARDS, TRIMS ETC. AS REQUIRED. MIN. OF ONE COAT OF PRIMER BOTH SIDES TO

ALL WOODS PRIOR TO CAPPING OF ANY ALUMINUM.

NOTE: CONTRACTOR TO PROVIDE AND INSTALL ALL NEW ALUMINUM CAPPING AS REQUIRED THR-OUT ALL WINDOWS, DOORS, FASCIAS, RAKERS, TRIM WORK ETC.

AND CAULK AROUND ALL VOIDS EXPOSED TO THE

WEATHER AS REQUIRED.

GUARD OPENING LIMITATIONS, ANY OPENING SHALL NOT ALLOW PASSAGE OF A SPHERE 4" OR MORE IN DIAMETER AS PER SECTION R312 OF THE 2020 RESIDENTIAL CODE OF NEW YORK STATE

NOTE: ALL GLASS SHOWER ENCLOSURE DOORS AND GLASS SURROUND. GLAZING MUST BE TEMPERED GLASS TYP.

NEW (2) 2"XI2" P.T. DROPPED

NOTE: FOR ALL NEW LVL OR ML MUST BE BOLTED TOGETHER 24" UNLESS OTHERWISE NOTED

ALL HALLWAYS, STAIRWAYS , HEADROOM ETC SHALL CONFORM TO SECTION 311.6, AND 311.7 THROUGH 311.8.3 OF THE 2020 RESIDENTIAL CODE OF NEW YORK STATE.

> 37'-10" NEW OVERALL DECK ABOVE

> > 36'-6"

NEW (2) 2"X12" P.T. DROPPED NEW (2) 2"X12" P.T. DROPPED

3'-15"

NEW

NOTE: PROVIDE SIMPSON H2 STRAPPINGS ON ALL RAFTER, BEAMS AND JOISTS

WINDOWS TO BE TEMPERED GLASS AT ALL LOCATIONS WHERE SILLS THAT ARE 18" OR LESS TO THE

NEW (2) 2"X12" P.T. DROPPED

BEAM ACROSS

ALL TREADS SHALL BE NOT LESS THAN 9" INCHES AND ALL RISER HEIGHTS SHALL BE NOT MORE THAN 8 1 INCHES AS PER SECTION 311.7.5 STATE OF THE 2020 RESIDENTIAL CODE OF NEW YORK STATE.

NOTE: GYPSUM COMPLY WITH SECTION R102.3.5 OF THE 2020 RESIDENTIAL CODE OF NEW YORK STATE

CONTRACTOR IS TO PROVIDE MECHANICALLY VENTILATED SYSTEM IN THE CELLAR AND INSTALLED IN ACCORDANCE WITH SECTION MIDOS OF THE 2020 RESIDENTIAL CODE OF NEW YORK STATE AND TO SATISFY SECTION R303 LIGHT,


VENTILATION AND HEATING EXCEPTION I


NOTE: PLUMBING COMPLY WITH SECTION R307 OF THE 2020 RESIDENTIAL CODE OF NEW YORK


NOTE: NOTE: BATHROOM ROOM TO HAVE MARBLE SADDLE

NOTE: PROVIDE STRAPPING AT NOTE: CONTRACTOR IS NOT TO USE FIRST FLOOR DECKING TO STUD PRESSURE TREATED POST IN WALLS TYP. ANYWHERE IN THE HOUSE. PRESSURE TREATED IS UNACCEPTABLE.

CONTRACTOR IS TO PROVIDE ENOUGH ARTIFICIAL LIGHTING IN THE CELLAR THAT IS CAPABLE OF PRODUCING AND AVERAGE ILLUMINATION OF 6 FOOTCANDLES (65 LUX) OVER THE AREA OF THE ROOM AT A HEIGHT OF 30 INCHES ABOVE THE FLOOR LEVEL AS PER SECTION R303 EXCEPTION 2 OF THE 2020 RESIDENTIAL CODE OF NEW

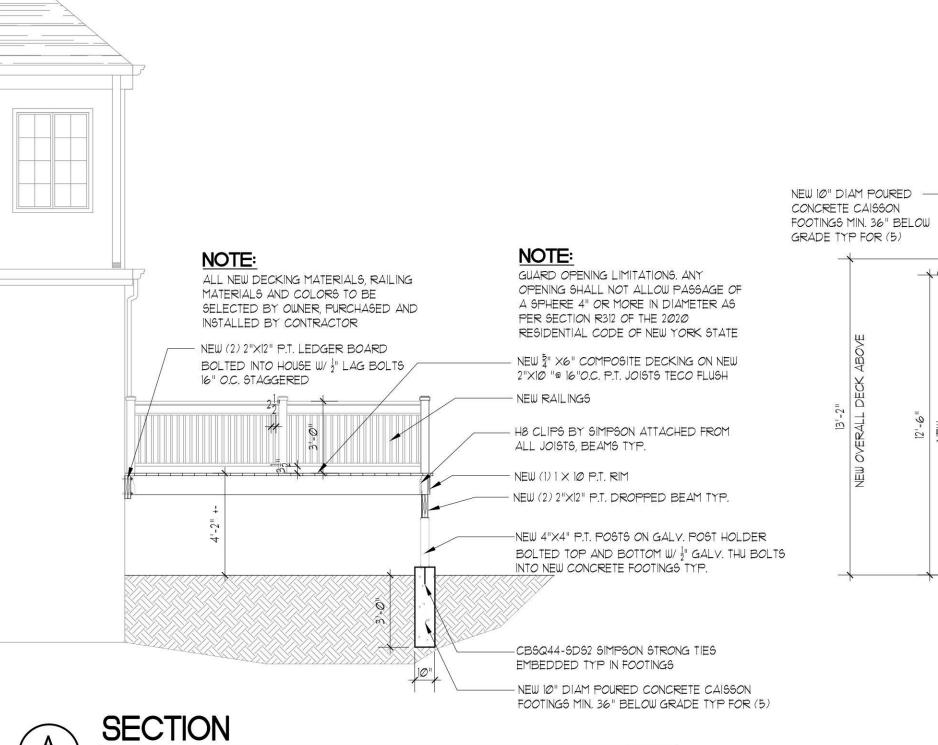

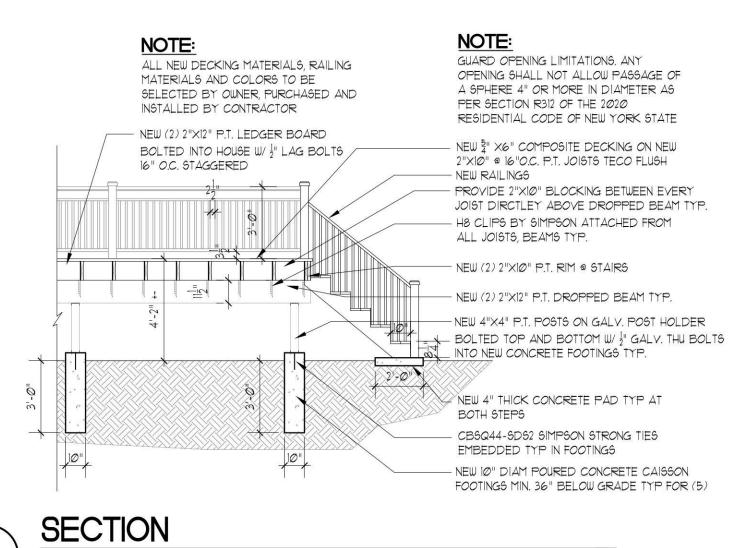

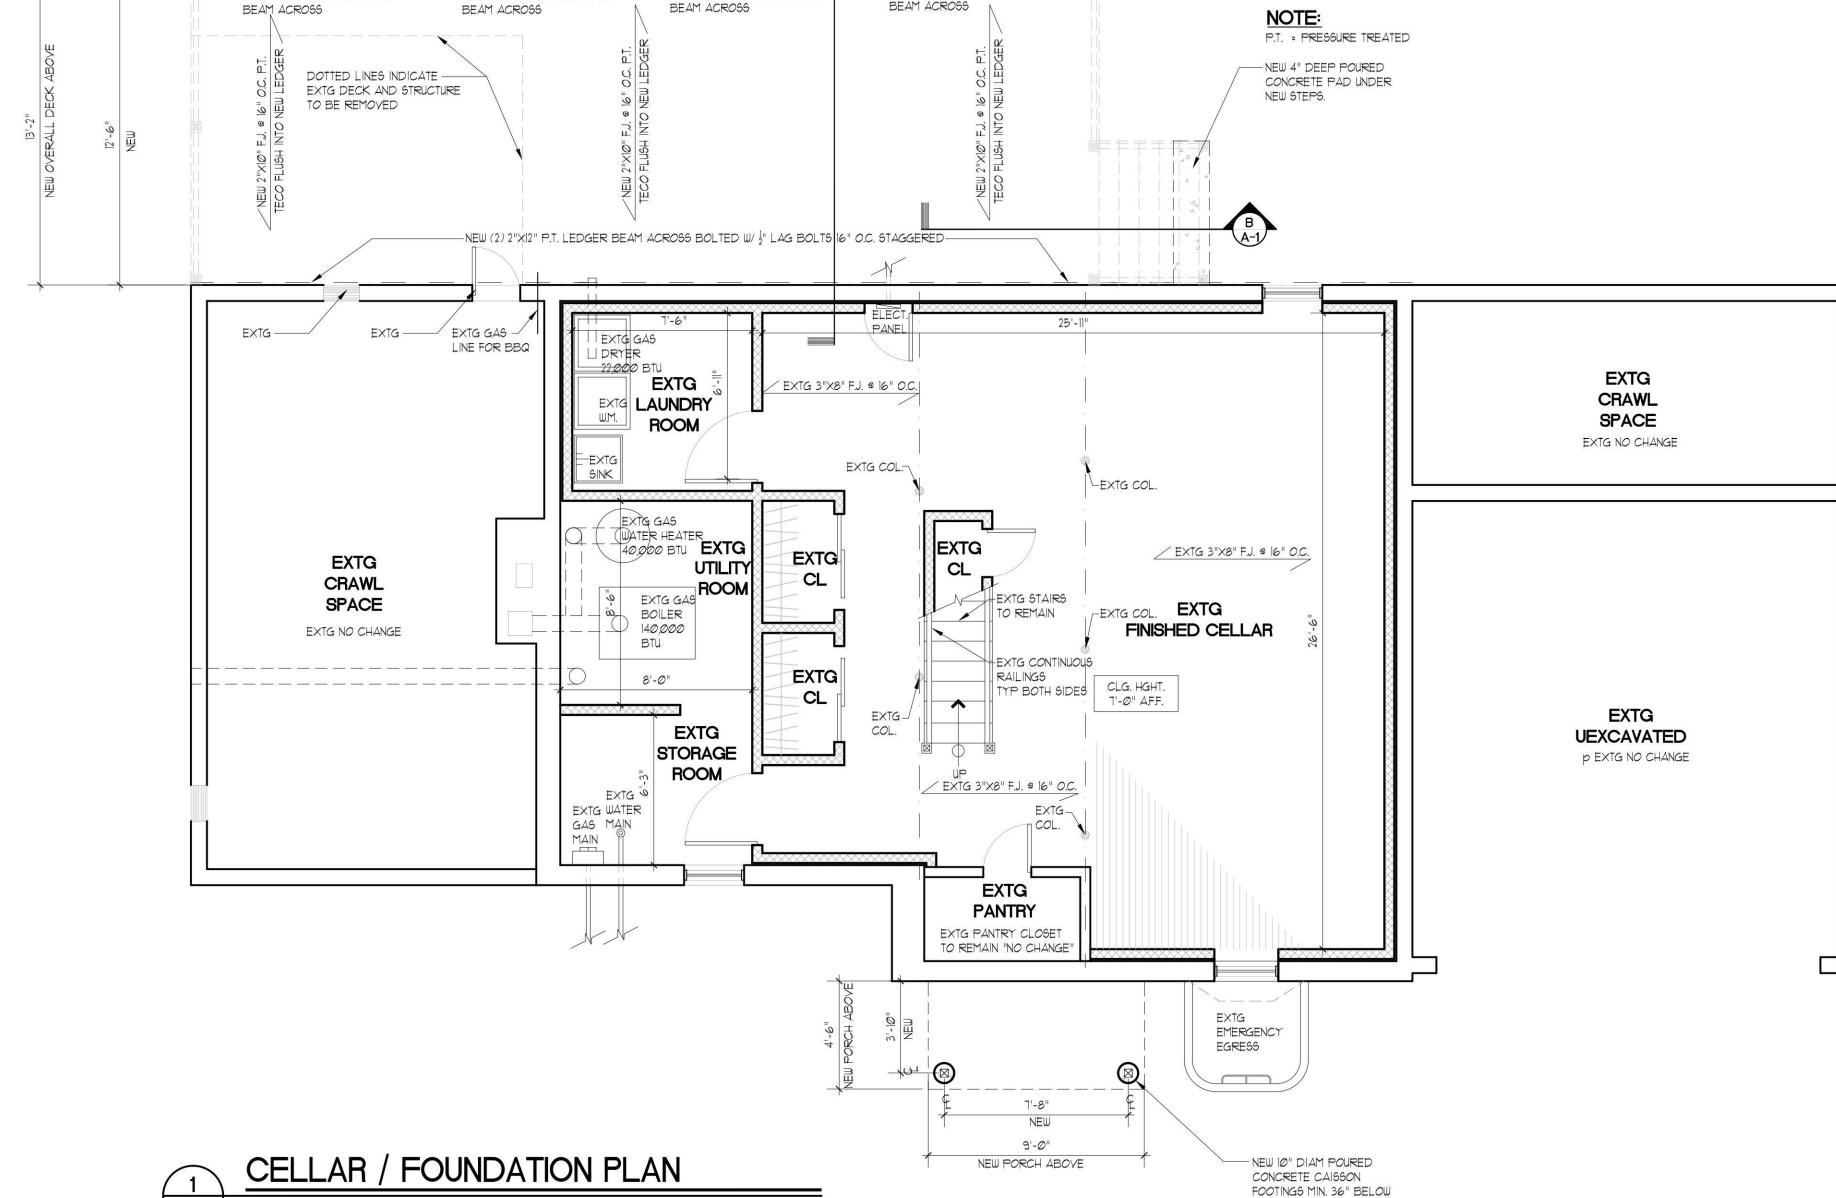

DISAPPROVED Nicholas Vissichelli 06/27/2024 No errors, omissions, or oversight on the part of the Plan Examiner shall release the design professional, applicant, and/or owner of the responsibility to comply with all the requirements of the NYS Building Code, Zoning Laws of the Town of North Hempstead, and all other applicable codes and standards of jurisdictions having authority over the work.

RBP24-000586

DRAWING NO .: / - $\overline{}$

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NO ALLOWANCES SHALL BE

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REVISION DATE

AS NOTED
A.D.B

GRADE TYP FOR (2)

CONCRETE CAISSON FOOTINGS MIN. 36" BELOW NOTE:

NOTE: FOR ALL NEW HEADER SIZES AND OPENINGS SEE SHEET A-I COVER SHEETS GENERAL NOTES TYP. UNLESS OTHERWISE

NOTE: CONTRACTOR TO PROVIDE SOLID BRIDGING AS REQ. IN ALL FLOOR JOISTS TYP.

NOTE:
CONTRACTOR TO PROVIDE 4"X6" WOOD POSTS (DBL. JACK STUDS) BETWEEN ALL WINDOWS AND DOORS W/ HEADERS ACROSS TYP. ON ALL WINDOWS UNLESS OTHERWISE NOTED.

AND MEANS OF EGRESS SHALL CONFORM TO

SECTION 310 THROUGH 311.5 OF THE 2020

RESIDENTIAL CODE OF NEW YORK STATE.

ALL NEW STEEL COLUMN POST MUST REST ON NEW OR EXTG FOUNDATIONS AND OR NEW OR EXTG STEEL BEAMS BELOW TYP

NOTE: FOR ALL STEEL COLUMNS

TO HAVE $\frac{1}{2}$ " TOP AND BOTTOM

PLATES TO COVER THE SIZE OF

BEAMS DESCRIBED IN THE PLANS

NOTE: NOTE: CONTRACTOR TO PROVIDE AND INSTALL ALL NEW FASCIA BOARDS, RACER BOARDS, TRIMS ETC. AS REQUIRED. MIN. OF ONE COAT OF PRIMER BOTH SIDES TO ALL WOODS PRIOR TO CAPPING OF ANY ALUMINUM.

NOTE: CONTRACTOR TO PROVIDE AND INSTALL ALL NEW ALL EMERGENCY ESCAPE AND RESCUE OPENINGS ALUMINUM CAPPING AS REQUIRED THR-OUT ALL WINDOWS, DOORS, FASCIAS, RAKERS, TRIM WORK ETC. AND CAULK AROUND ALL VOIDS EXPOSED TO THE WEATHER AS REQUIRED.

GUARD OPENING LIMITATIONS. ANY OPENING SHALL NOT ALLOW PASSAGE OF A SPHERE 4" OR MORE IN DIAMETER AS PER SECTION R312 OF THE 2020 RESIDENTIAL CODE OF NEW YORK STATE

NOTE: ALL GLASS SHOWER ENCLOSURE DOORS AND GLASS SURROUND, GLAZING MUST BE TEMPERED GLASS TYP.

NOTE: FOR ALL NEW LVL OR ML MUST BE BOLTED TOGETHER 24" UNLESS OTHERWISE NOTED

ALL HALLWAYS, STAIRWAYS , HEADROOM ETC SHALL CONFORM TO SECTION 311.6, AND 311.7 THROUGH 311.8.3 OF THE 2020 RESIDENTIAL CODE OF NEW YORK STATE.

NOTE: PROVIDE SIMPSON H2 STRAPPINGS ON ALL RAFTER,

BEAMS AND JOISTS

FLOOR

WINDOWS TO BE TEMPERED GLASS AT ALL LOCATIONS WHERE SILLS

THAT ARE 18" OR LESS TO THE

ALL TREADS SHALL BE NOT LESS THAN 9" INCHES AND ALL RISER HEIGHTS SHALL BE NOT MORE THAN 8 $\frac{1}{4}$ " INCHES AS PER SECTION 311.7.5 OF THE 2020 RESIDENTIAL CODE OF NEW YORK STATE.

NOTE:
NOTE: GYPSUM COMPLY WITH SECTION
RT02.3.5 OF THE 2020 RESIDENTIAL CODE OF NEW YORK STATE

WALLS TYP.


NOTE: PLUMBING COMPLY WITH SECTION R307 OF THE 2020 RESIDENTIAL CODE OF NEW YORK <u>STATE</u>

NOTE: PROVIDE STRAPPING AT FIRST FLOOR DECKING TO STUD

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NOTE: NOTE: BATHROOM ROOM TO


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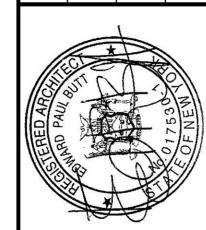
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NO ALLOWANCES SHALL BE MADE IN BEHALF OF THE CONTRACTOR FOR ANY ERROR OR NEGLECT ON HIS PART. REVISION DATE per bldg dept 12.16.21

comments per owner 3.14.22 design change amendment add gas line 2.24.23 for bbq

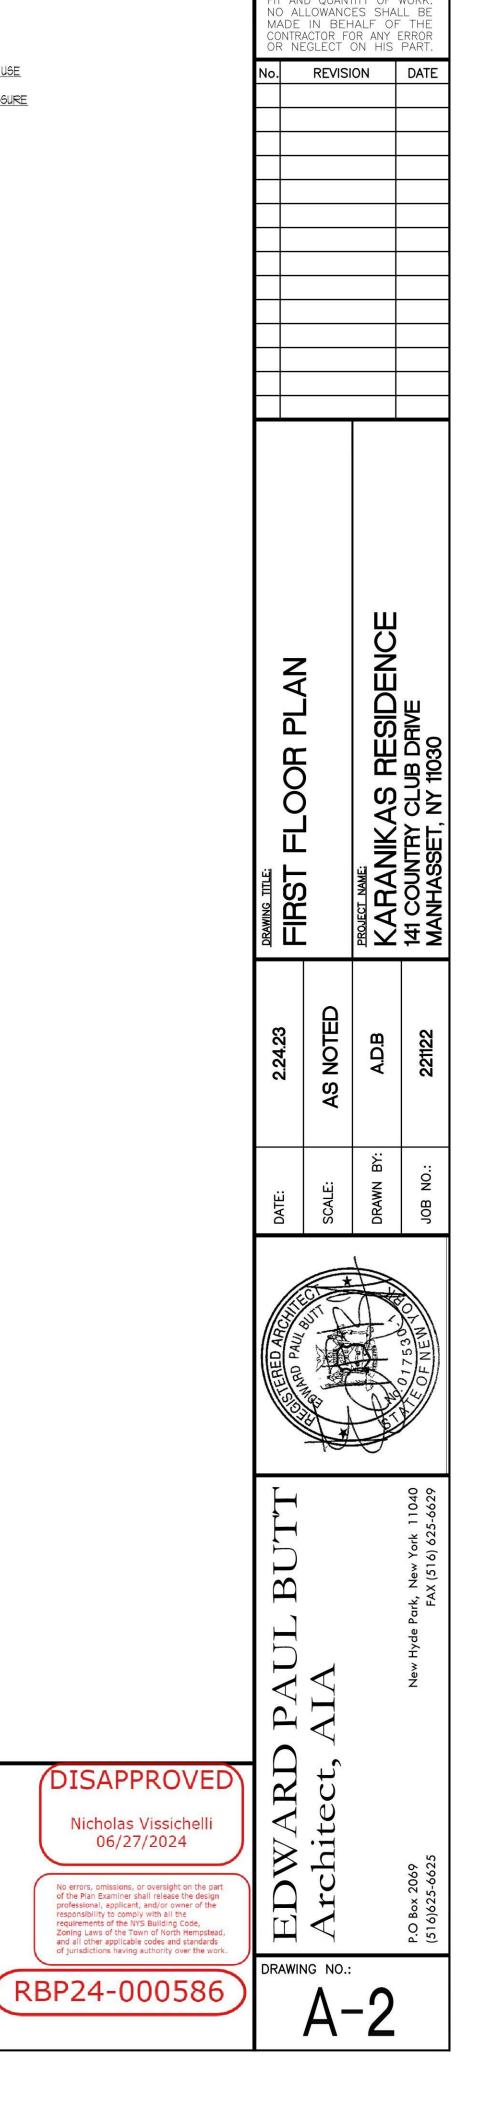



DISAPPROVED


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Nicholas Vissichelli 06/27/2024

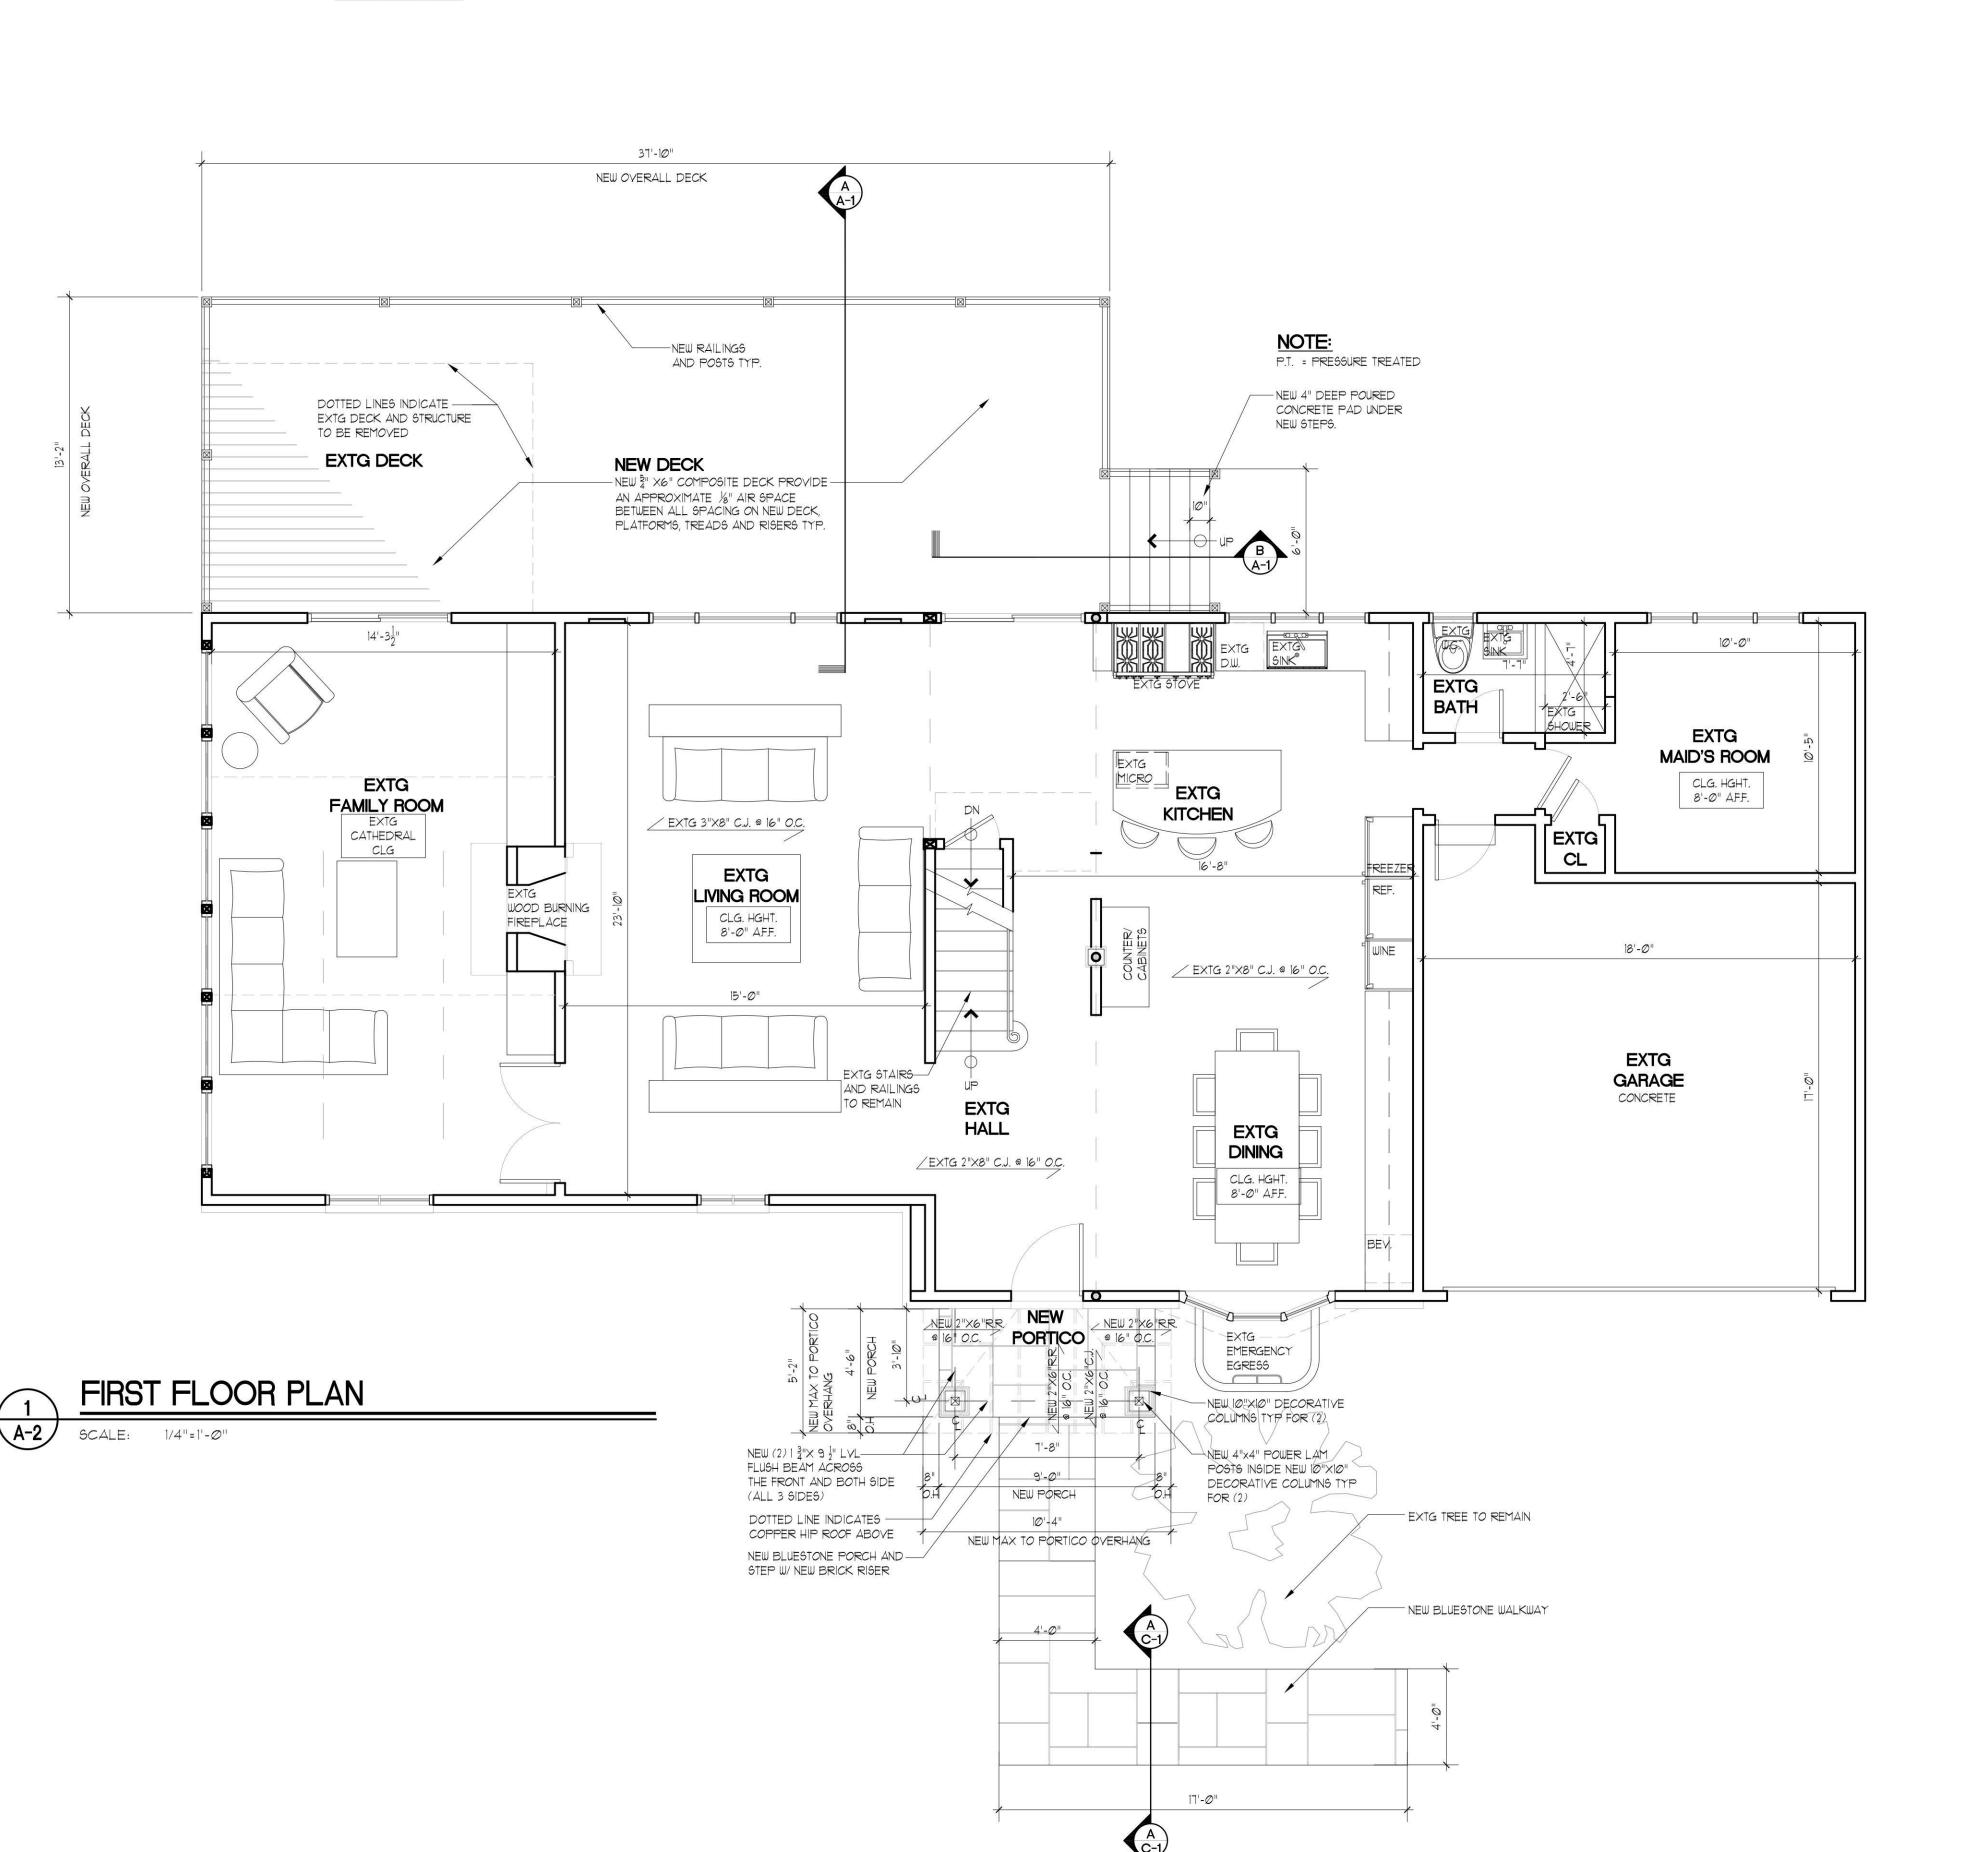DRAWING NO .: RBP24-000586 A-3



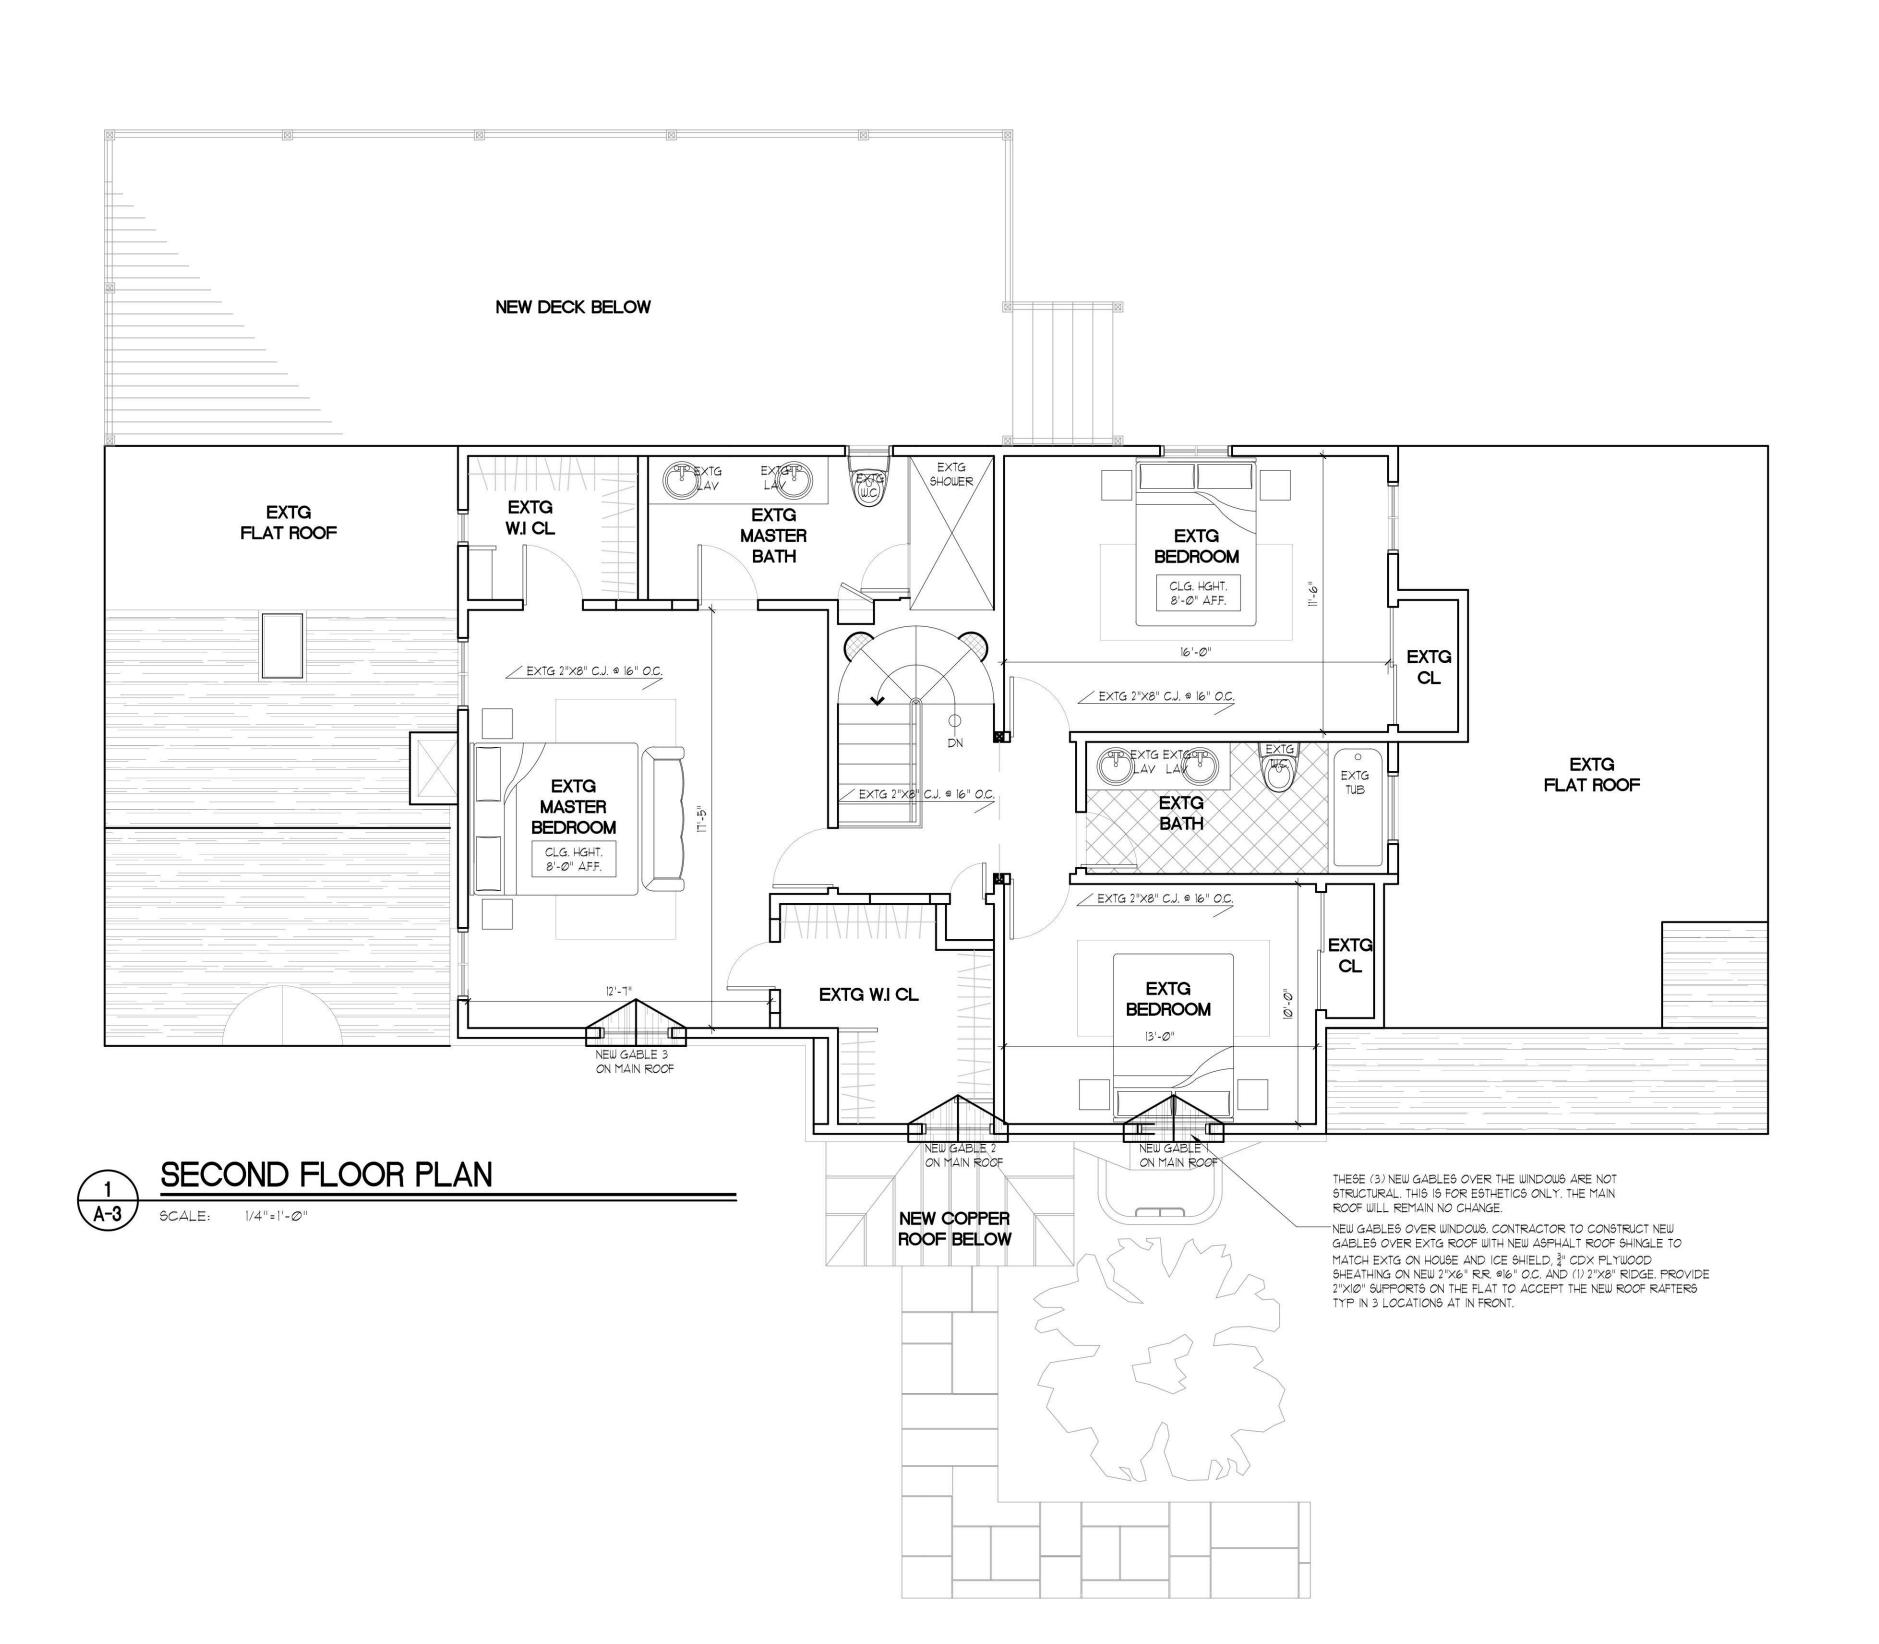

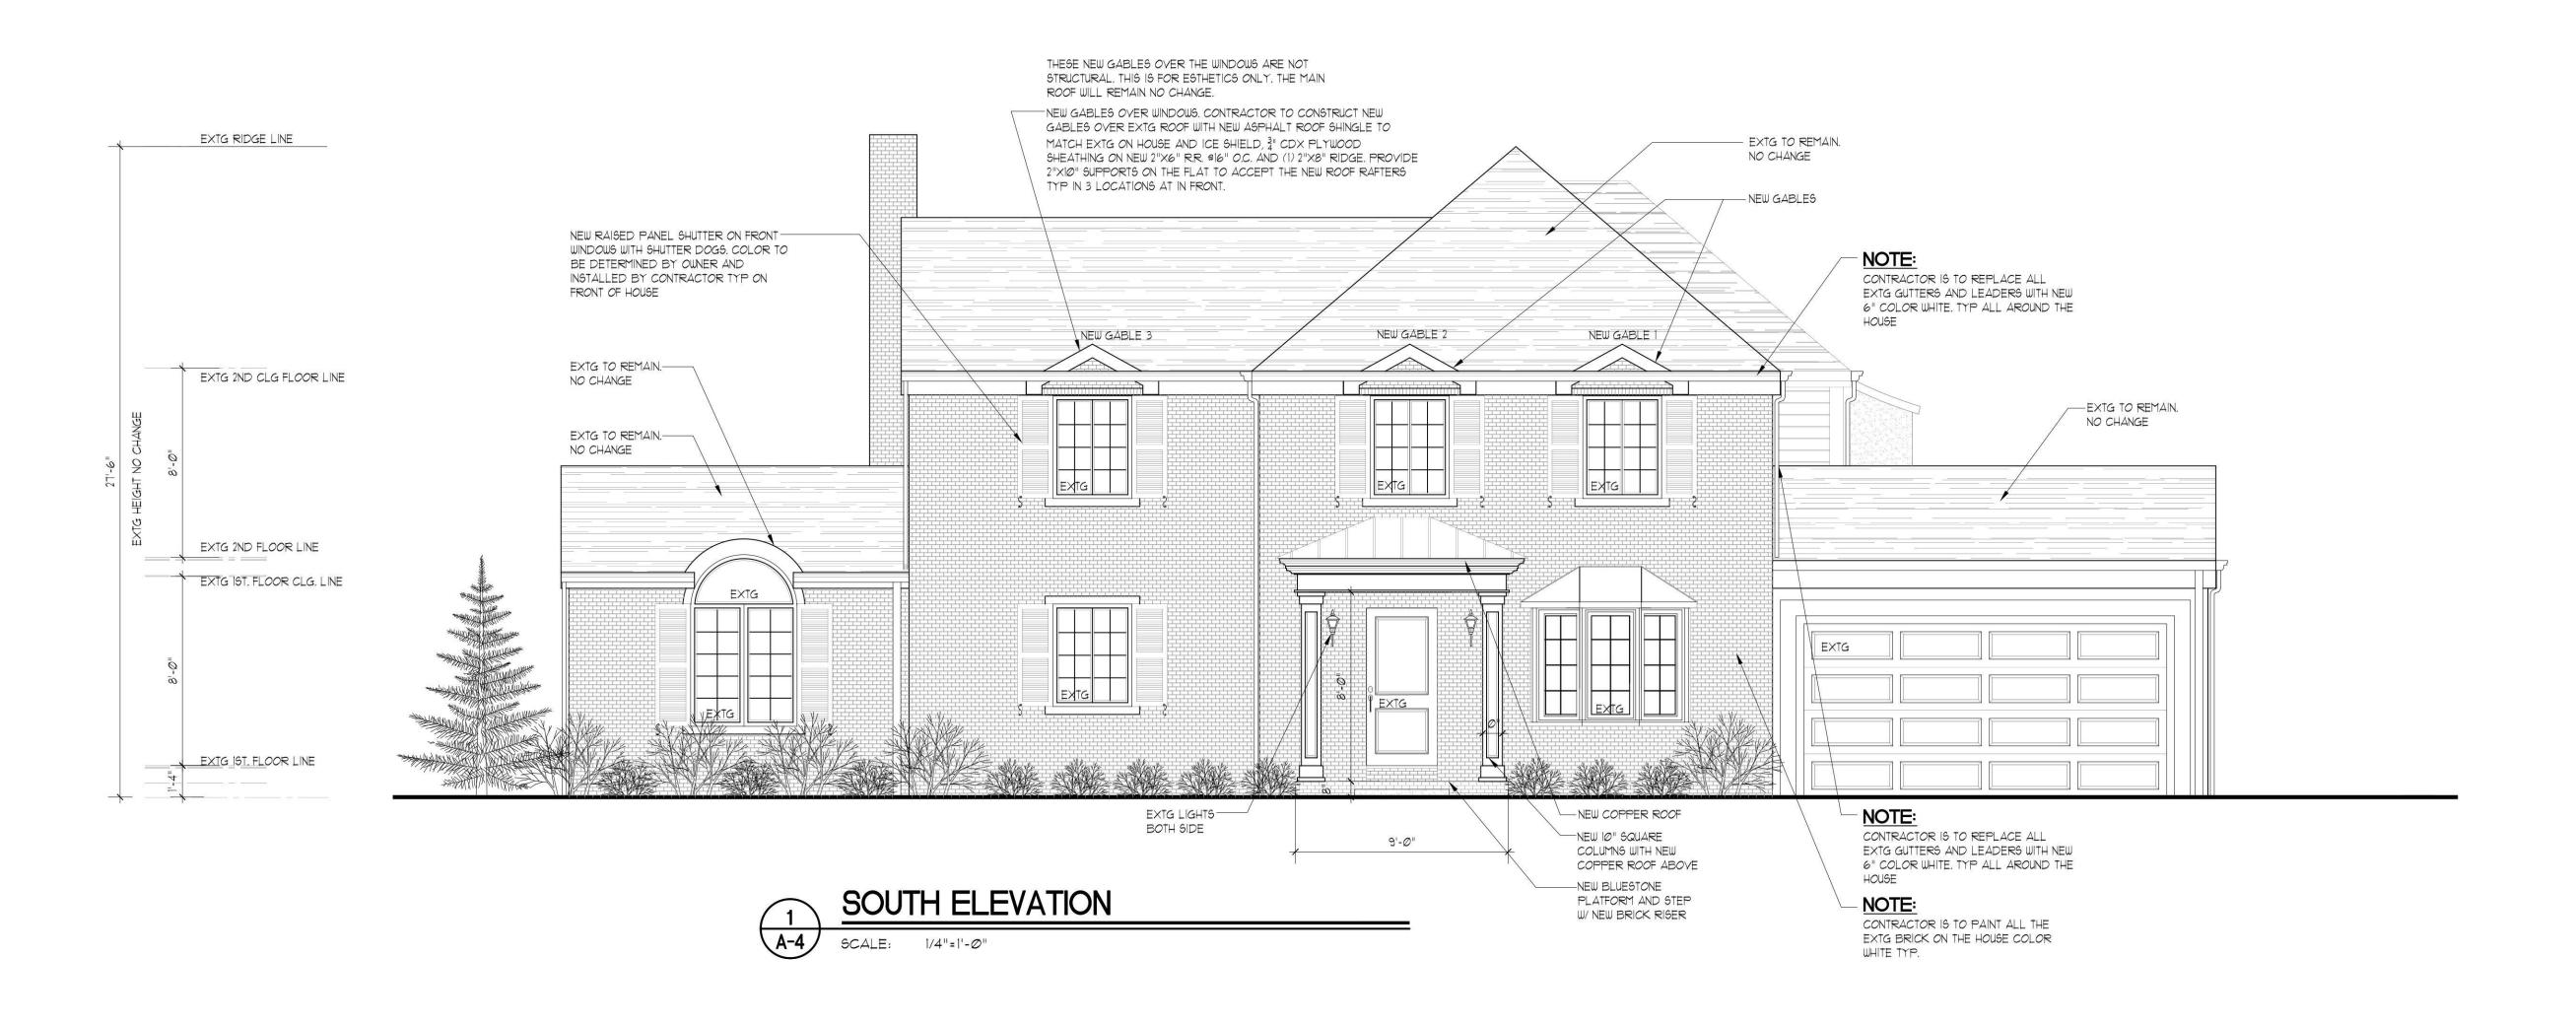

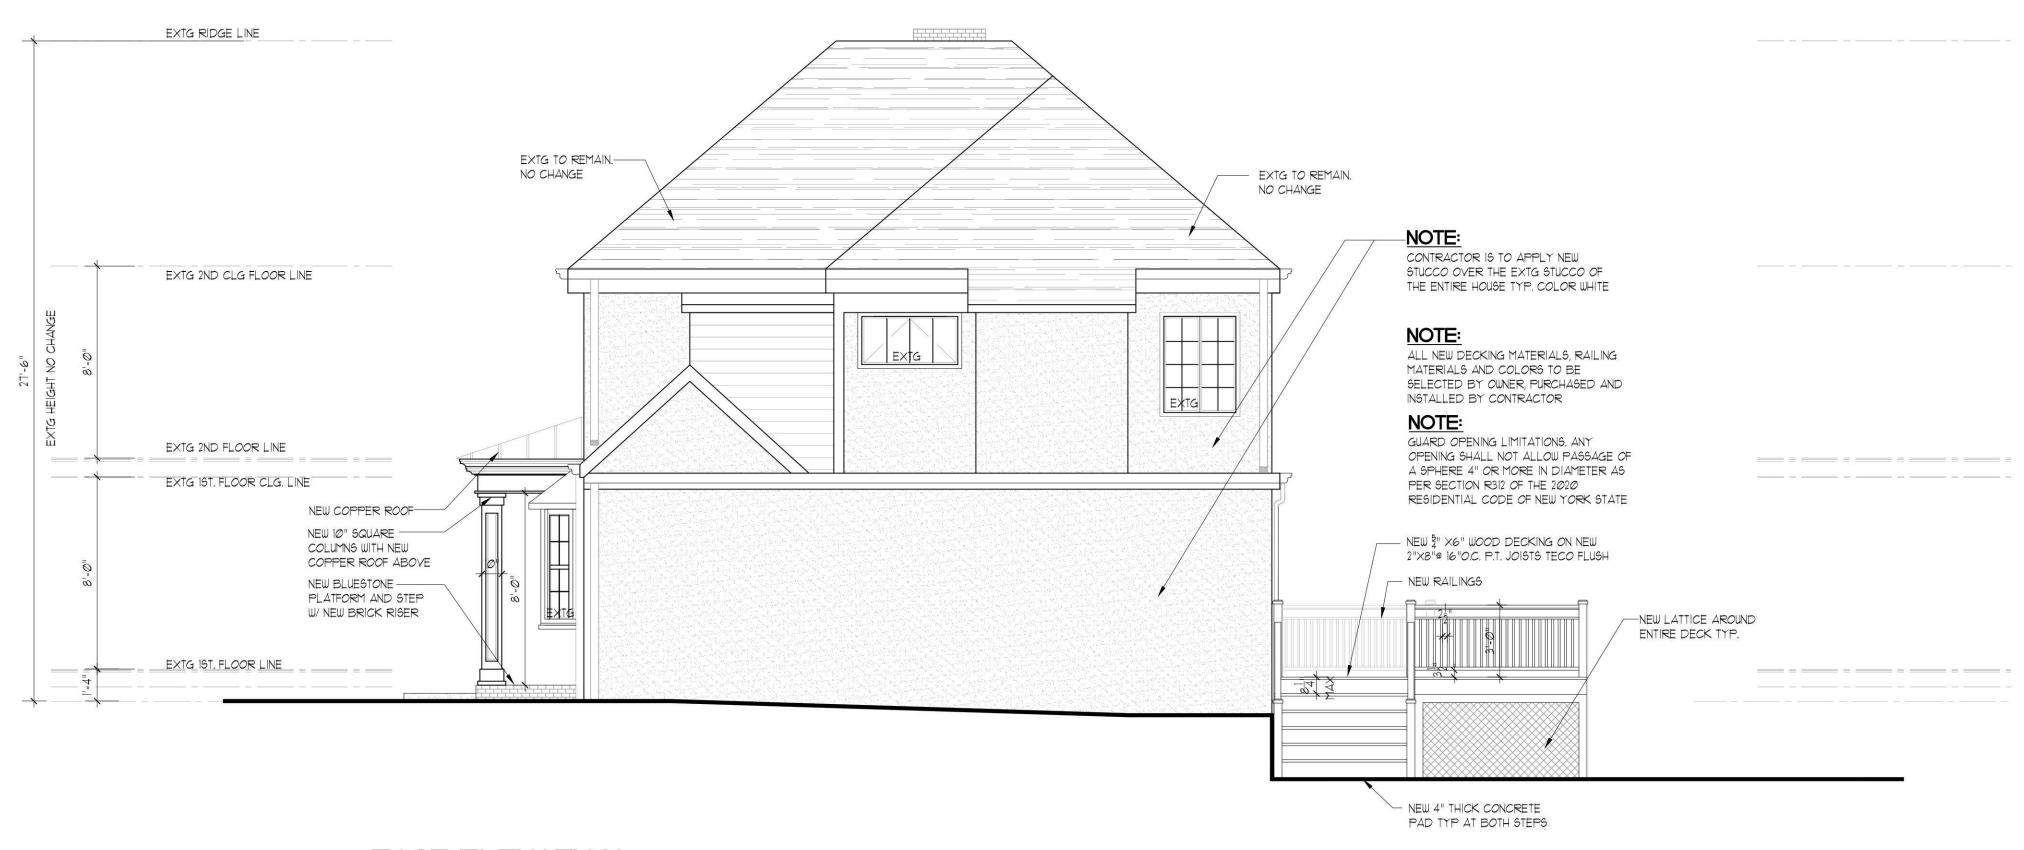

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RBP24-000586

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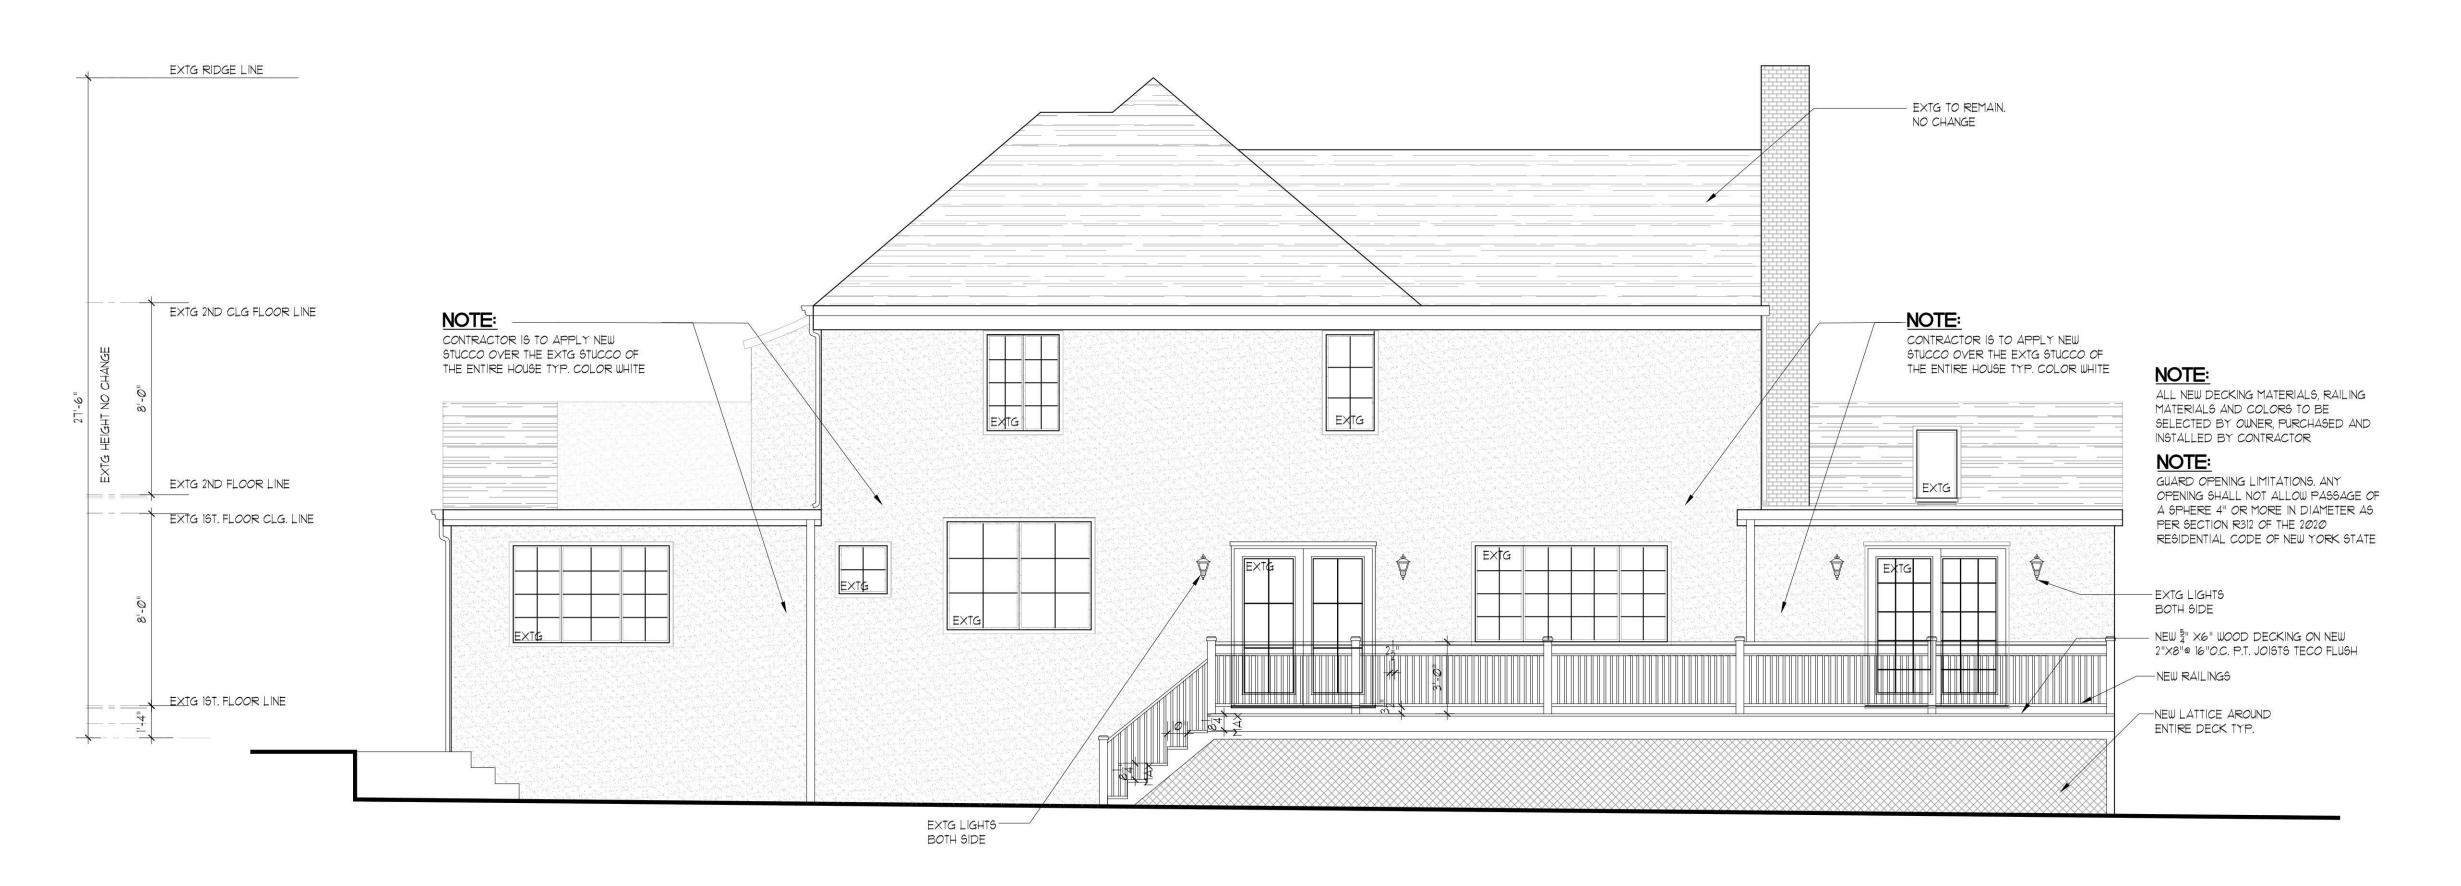
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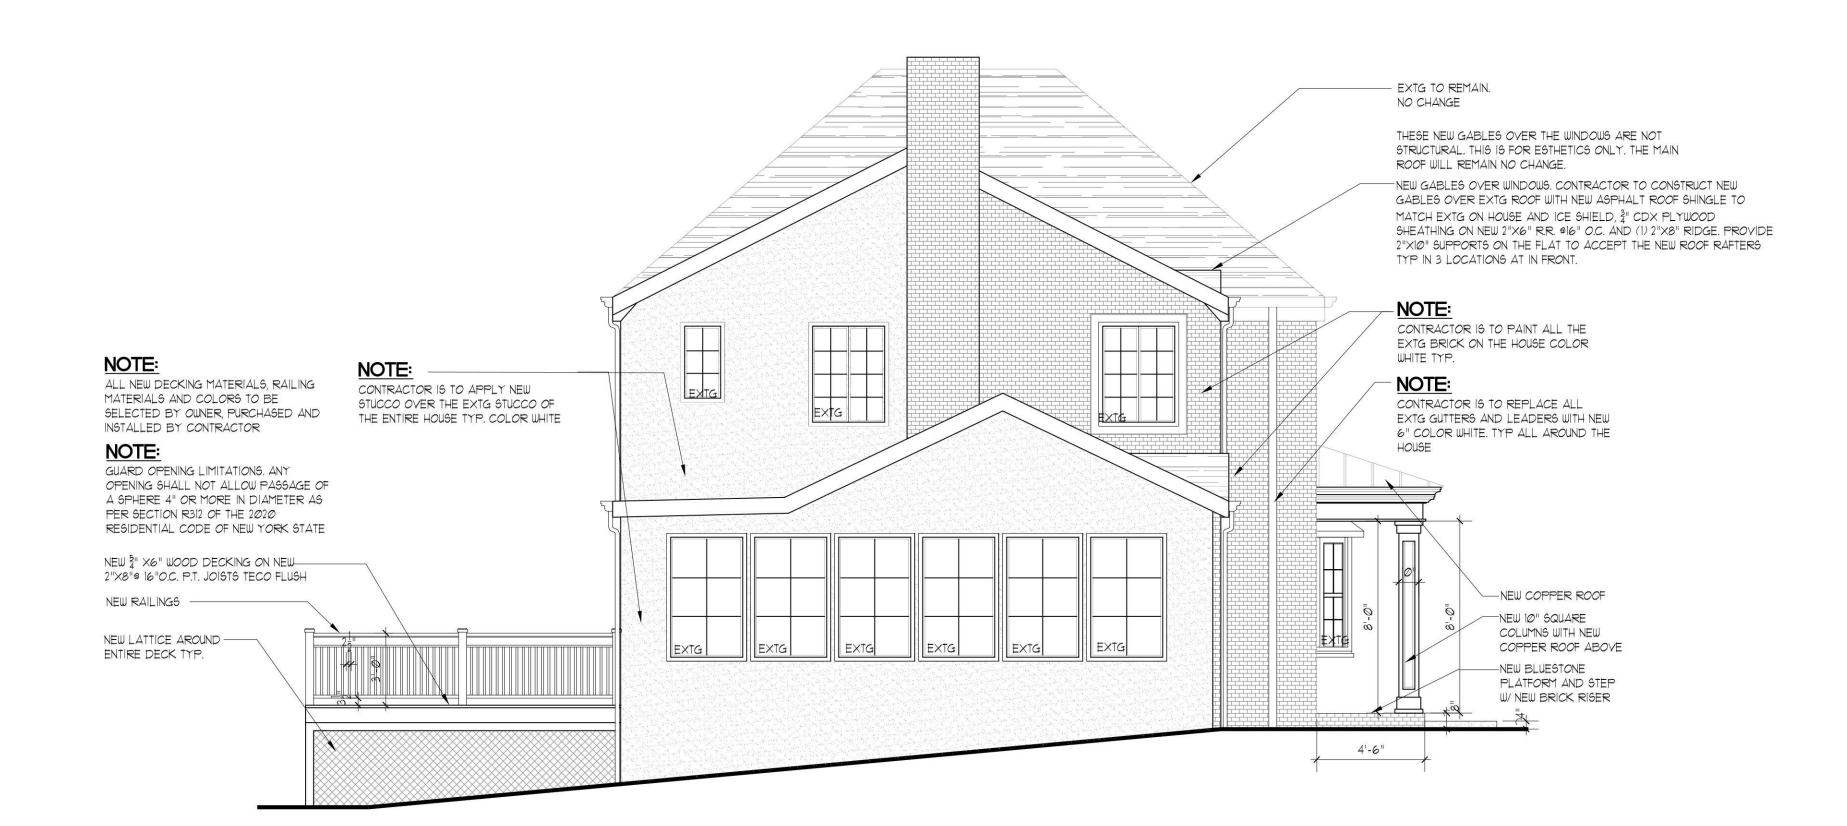
ERED ARU, OR 1753 Oct.

PAUL BUTT
AIA

EDWARD PA Architect, AL









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DRAWING TITLE: FI FVATION		KARANIKAS RESIDENCE	141 COUNTRY CLUB DRIVE MANHASSET, NY 11030
2.24.23	AS NOTED	A.D.B	221122
DATE:	SCALE:	DRAWN BY:	JOB NO.:
STERED ARCHITECTURE	The state of the s		FOF NEW YOU
JL BUTT			Jew Hyde Park, New York 11040 FAX (516) 625-6629


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DISAPPROVED

Nicholas Vissichelli 06/27/2024

DRAWING NO .:



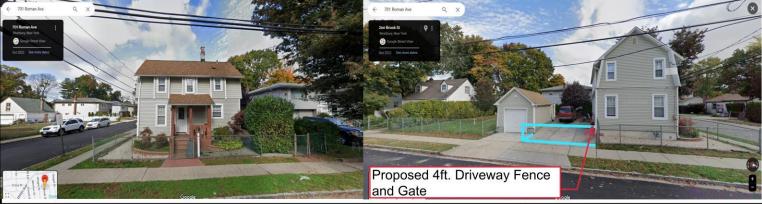

NOTE: CURRENT NON-PERMITTED/NON-CONFORMING GRAY FENCING TO BE WELL REMOVED AND REPLACED WITH NEW 4FT. HIGH NON-CONFORMING BLACK FENCING.





Nassau County New York

Figure 1 Proposed Conditions Garcia Property - 701 Roman Ave.

Date: 6/14/2024

Version: 1



#21591

15

N.58°-28'-17"E.

70:00

ALL ROOF OVERHANG - 2.6 106.06 18.66 17 16 BAY WINDOW 12.0 30 08 SPLIT LEVEL S.31°-31'-43"E BAY N.31°-31-43"W. ISAPPROVED 26.9 28.5 S.61°-07'-43" W. 60.08

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COURT

LOT	_BLK 415	ON MAP OF_	CEDAR	RIDGE ESTATES SEC.
SITUATED AT NEW			-2	NASSAU COUNTY, N. Y.
GUARANTEED TO WILLI				VACANTUNDER CONST//-4-5-4
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NASSAU CO. LAND MAP	SEC. //	SCALE/''	=20'	JOB NO

DEVELOPMENT PLANNING C.C. BOHN SURVEYOR

TITLE & MORTGAGE SURVEYS

5. LIC. NO. 22055

137 POST AVE. WESTBURY, N.Y.

WEST. 7-0020